



Wauwatosa, WI

Community Affairs Committee

Meeting Agenda - Final

7725 W. North Avenue
Wauwatosa, WI 53213

Tuesday, April 25, 2023

7:00 PM

Council Chambers and Zoom:
<https://servetosa.zoom.us/j/82923188685>,
Meeting ID: 829 2318 8685

Regular Meeting

HYBRID MEETING INFORMATION

Members of the public may observe and participate in the meeting in-person or via Zoom at the link above. To access the Zoom meeting via phone, call 1-312-626-6799 and enter the Meeting ID.

CALL TO ORDER

ROLL CALL

COMMUNITY AFFAIRS COMMITTEE ITEMS

1. Committee interview of candidate Christopher Due for Plan Commission appointment [23-997](#)
2. Request by Jonathan Ward, Altius Building Company, for a Zoning Map Amendment from C2 District to C2/Planned Unit Development (PUD) District at 11400 W. Blue Mound Road [23-900](#)
Recommendation: No action needed. Action is with item #3
3. Ordinance amending the Official Zoning Map of the City of Wauwatosa from C2 District to C2 District/Planned Unit Development Overlay at 11400 W Blue Mound Road and 11430 W Blue Mound Road [23-1231](#)
Recommendation: Introduced on April 18, 2023, for adoption consideration
4. Request by Jonathan Ward, Altius Building Company, for Planned Unit Development preliminary plans at 11400 W. Blue Mound Road for a multi-unit building [23-1002](#)
5. Youth Commission Annual Report [23-1155](#)
6. Resolution approving a Conditional Use Permit in the M1 District at 1435 N 113th Street for a sports and recreation participant establishment, Bron Launsby, Innovative Heights Wauwatosa, LLC, applicant [23-1222](#)

Recommendation: Referred from Council

ADJOURNMENT

NOTICE TO PERSONS WITH A DISABILITY

Persons with a disability who need assistance to participate in this meeting should call the City Clerk's office at (414) 479-8917 or send an email to tclerk@wauwatosa.net, with as much advance notice as possible.

CITY OF WAUWATOSA
Amended Resolution

R-16-177

By: Community Affairs Committee

WHEREAS, pursuant to Section 2.24.020 (b) of the Wauwatosa Municipal Code, the Community Affairs Committee shall interview candidates for appointment to the Plan Commission.

NOW, THEREFORE, BE IT RESOLVED that the Committee shall ask the following questions of the candidates at the interview:

- What relevant or pertinent education or work experience do you have that would be of value on the Plan Commission?
- Why do you want to serve on the Plan Commission or what interests you about serving on the Plan Commission?
- What recommendations do you have to move Wauwatosa forward as a leader in the region?
- Talk about your familiarity with the Comprehensive Plan and highlight the City's priority issues

BE IT FINALLY RESOLVED that the Committee is free to ask additional questions.

Passed and Dated October 4, 2016

Cara A. Heckerma
Clerk

Adopted: October 4, 2016

Page: **445**

Journal: 112

Approved October 5, 2016

Kristeen Riley
Mayor



Wauwatosa, WI

7725 W. North Avenue
Wauwatosa, WI 53213

Staff Report

File #: 23-900

Agenda Date: 4/25/2023

Agenda #: 2.

Request by Jonathan Ward, Altius Building Company, for a Zoning Map Amendment from C2 District to C2/Planned Unit Development (PUD) District at 11400 W. Blue Mound Road

Submitted by:

Tamara Szudy

Department:

Planning Division

A. Background/Options

The applicant is requesting a zoning map amendment from General Commercial (C2) District to C2/Planned Unit Development (PUD) Overlay District on an approximately 0.8 acre site located on the north side of Blue Mound Road between 114th Street and 115th Street. The intent of the amendment is to establish a PUD for a four-story, multi-unit residential development consisting of 41 residential units. Rezoning the site to C2/PUD Overlay District is necessary to allow for multi-family residential development, reduce required setbacks to move the building closer to the sidewalks along Blue Mound Road and 115th Street, and reduce the lot area per unit requirement.

The Plan Commission reviewed the project at the March meeting and recommended approval 7-0. The required public hearing before the Common Council was held April 18, 2023 with one person speaking in support of the project and two people providing comment including a concern about the proposed building setback from the Blue Mound Road property line.

Attached to this report is the applicant's project statement and zoning information. The next agenda item provides the plans for about the proposed development. The Plan Commission item is linked for reference.

B. Staff comments

Planning/Zoning Division:

The Future Land Use Map in the 2008-2030 Comprehensive Plan indicates maintaining the 2008 uses of the parcels through the future land use category of "Planned Commercial". Many goals, objectives, and policies found in Volume Two: Policies and Recommendations, primarily in Chapter 2.1 Land Use and Chapter 2.3 Housing and Neighborhood Development, support multifamily housing development opportunities in the City. In addition, to address changing conditions over the life of the Plan, Volume Two of the Comprehensive Plan on page 186 states "the precise location of zoning district boundaries may vary, as judged appropriate by the Plan Commission and City Council. Departures from the exact land use boundaries depicted on the Future Land Use map may be particularly appropriate for planned development projects, projects involving a mix of land uses and/or residential development types, properties split by zoning districts and/or properties located at the edges of future land use areas. In their consideration of zoning map issues, the Plan Commission and City Council will also evaluate the specific timing of the zoning map amendment request, its relationship to the nature of both existing and planned land uses, and the details of the proposed development. Therefore, this *Plan* allows for the timing of zoning actions and the refinement of the precise recommended land use boundaries through the zoning, conditional use, planned development, and land division processes." Volume Two of the Comprehensive Plan is found here:

<https://www.wauwatosa.net/home/showpublisheddocument?id=480>

The City's 2023 Housing Study and Needs Analysis identifies a continued demand for housing units that will likely be

supplied through multi-family developments. The Housing Study is found here:

<https://www.wauwatosa.net/home/showpublisheddocument/4879/638125711998330000>

Finally, consistent feedback heard during the review of other multi-family development proposals is multi-family developments should be located in areas where there is little impact to residential neighbors. While there are adjacent residential neighbors, the height of the proposed building is only five feet higher than the existing buildings and the massing is similar to the existing buildings.

The applicant also provided additional information related to the project's consistency with adopted plans and studies.

Building Division: No issues.

Assessor's Office: No issues with zoning map amendment.

City Clerk's Office: No issues.

Engineering Division: No issues with zoning map amendment. Site plan and landscaping comments are included in the preliminary PUD request.

Fire Department: No comments provided.

Health Department: No comments provided.

Police Department: No comments provided.

C. Recommendation

Staff recommends approval.

Recommendation: No action needed. Action is with item #3

11400-30 W. Bluemound Road PUD Redevelopment Narrative

Revel Real Estate Investments and Altius Development Integration Services are partnering with Smart Asset Capital to propose this demolition and redevelopment of the existing office buildings and parking deck at 11400 and 11430 W. Bluemound Road into a 41-unit multifamily building. Smart Asset Capital owns the properties through a related company and have been actively working with the City to create this redevelopment plan to address the structural issues with the parking deck. The existing buildings are class C office space and the demand for this grade of office space is low making it difficult to support the costs for significant capital improvements to the parking deck; however, the market for multifamily residential continues to expand and we believe the best use of this property would be to redevelop it into multifamily housing.



The new building will be oriented up along Bluemound Road partially wrapping the corner along 115th Street with a 5' landscape buffer along the sidewalk, to move the massing of the building to the front of the site, away from the single-family neighborhood behind it. This will both define the urban street edge, while also screening additional surface parking behind the building. This parking will also act as a transitional buffer to the neighborhood. There will be 41 parking stalls in the garage and 30 surface spaces totaling 71 spaces, or 1.73 per unit. The rear parking will be an improvement over the existing parking deck as it will be brought down to grade level with landscaping for screening. Site access will be off of 114th and 115th streets, the existing Bluemound curb cut will be eliminated. The total interior parking lot paved area will be 10,883 SF which requires 1,083 SF of interior parking landscaped area and six trees; we will provide 1,200 SF of interior parking landscaping area and seven trees. Other site details include two, five-stall bike parking stalls along sidewalk on the east side, along with a pet waste station. The refuse area will be located inside the building in the parking garage to minimize any noxious odors or debris from an outdoor refuse enclosure.

The building's public spaces will be located in the most prominent corner near the intersection of Bluemound and 114th Street in order to activate the street front. The first-floor lobby will have large windows with a front door off Bluemound to bring light, life and energy to the street level to create a sense of place, with eyes on the street for safety. Above the lobby on the second floor will be a community room and fitness center also with large windows and a rooftop deck over the rear lobby entrance to enhance the sense of activity and street life at the corner. The rest of the building will be three-stories of apartments over parking at-grade with 65,936 total s.f. a height of 46 feet or 4.7' taller than the existing building on the west side.

The project will contain a mix of unit sizes with fifteen one-bedroom, six one-bedroom with dens, seventeen two-bedroom, and three three-bedroom units to accommodate housing needs for a wide range of family sizes. Each unit will have a deck, stainless steel appliances, quartz counter tops, WiFi thermostats and keyless entries. Community amenities include a club room, rooftop terrace, fitness room, storage, bike storage, building-wide WiFi internet, rooftop solar and electric car chargers.

This will be a significant redevelopment investment of nearly \$13.6 million removing two deteriorating existing buildings with diminishing economic life and tax base with focused density for population growth along a State highway and one the City's main transportation corridors. It will improve upon the existing situation where the wall of the parking deck virtually abuts the neighbor's property line. This project promotes mixed-residential development, and walkability with responsible density, massing and height that is appropriate for this site and neighborhood in compliance of the City's Comprehensive Plan and Comprehensive Housing Study Needs Analysis.



Property: 11400 W. Bluemound Rd, tax key 411-0175-004 (.339 acres)
11430 W. Bluemound Rd, tax key 411-0175-003 (.460 acres)
The combined site is 0.80 acres.

The site is currently zoned C-2 Commercial which does not permit multi-unit residential buildings but has no height limits. Secondly, the 1,000 minimum lot area per unit allowed under C-2 only applies to mixed-use buildings and would only permit a maximum of 34 units. This few units makes the feasibility of clearing the existing buildings to redevelop the site, without public assistance, very difficult, this project is not requesting any public assistance. Finally, we're requesting a reduction in the 10-foot minimum front setback from the underlying zoning in order to move the building closer to the sidewalk in order to both accommodate an additional nine parking spaces in back and while minimizing any shadow the building would cast over neighboring properties to the north. We're requesting a 5.5' front setback and 4.8' setback on the west side where the existing zoning calls for 5' minimum. Therefore, we are requesting PUD zoning to allow for a multi-unit residential use and flexibility on the minimum lot area and setbacks.

- Fire access is provided on three sides of the building from the public streets with existing fire hydrants in close proximity. We intend to build to a NFPA 13 fire suppression rating rather than 13R for a higher level of protection.
- Stormwater catch basins will be connected to existing storm sewer lines in Bluemound Road. The increase in impervious surface over the existing site is negligible and far below ½ acre, so it does not require on-site stormwater detention.

24.05.040 - /PUD, Planned Unit Development Overlay.

A. Purpose.

1. General. The /PUD, Planned Unit Development Overlay district is intended to accommodate development that may be difficult if not impossible to carry out under

otherwise applicable zoning district standards. Examples of the types of development that may benefit from the PUD overlay district include the following:

a. **Enhanced Protection of Natural Resource Areas.** Developments that offer enhanced protection of natural resources and sensitive environmental features, including streams, water bodies, floodplains, wetlands, steep slopes and woodlands.

b. **Energy Conservation/Sustainability.** Developments that achieve extremely high levels of energy conservation and developments that achieve extremely high levels of sustainability, as evidenced by commitment to attain at least LEED Gold or equivalent ratings by recognized green building organizations.

c. **Traditional Urban Development.** Developments characterized by parcel configurations, street patterns, streetscapes and neighborhood amenities commonly found in urban neighborhoods platted or otherwise created before the 1950s.

d. **Mixed-use Development.** Developments that contain a complementary mix of residential and nonresidential uses.

Applicant Response: We are requesting a PUD zoning to accommodate a new 41-unit multi-unit residential building redevelopment of the deteriorating office buildings because the C-2 zoning does not accommodate multi-unit buildings as a permitted or conditional use; however, it does permit vertical mixed-use buildings which would be substantially the same type of use, with similar size and massing only with a higher intensity of use and traffic. We are requesting flexibility with the underlying 10' front setback requirement to pull the massing of the building closer to the Bluemound street front as would be more typical for traditional urban development while creating a larger buffer behind the building for the residential neighbors. This front setback flexibility is necessary to accommodate an adequate number of parking stalls behind the building to support the density necessary to make the redevelopment feasible without public assistance. The itself will provide parking screening in front and landscaping will be added to provide screening around the outdoor parking in back. While the building itself will be a single use, it promotes mixed use development by incorporating residences in a commercial district with many restaurants and services within walking distance.

2. **Objectives.** Different types of PUDs will promote different planning goals. In general, however, PUDs are intended to promote the following objectives:

a. implementation of and consistency with the city's adopted plans and policies;

b. flexibility and creativity in responding to changing social, economic and market conditions allowing greater public benefits than could be achieved using conventional zoning and development regulations;

c. efficient and economical provision of public facilities and services;

d. economic opportunity and environmental and social equity for residents;

e. variety in housing types and sizes to accommodate households of all ages, sizes, incomes and lifestyle choices;

f. compact, mixed-use development patterns where residential, commercial, civic and open spaces are located in close proximity to one another;

g. a coordinated transportation system that includes an inter-connected hierarchy of facilities for pedestrians, bicycles and vehicles;

h. compatibility of buildings and other improvements as determined by their arrangement, massing, form, character and landscaping;

i. the protection and enhancement of open space amenities and natural resource features such as tree canopy, native vegetation, wetland and stream buffer area and hydric soils in the development design;

j. the incorporation of sustainable development features including green infrastructure practices in landscapes and parking area, to maximize the aesthetic and water quality benefits of stormwater management practices; and

k. attractive, high-quality landscaping, lighting, architecture and signage, including the use of native landscaping, that reflects the unique character of the development.

Applicant Response: Excerpt from the Comprehensive Plan:

“As a first-ring community outside the City of Milwaukee, the future vitality of the community will depend largely on its ability to maintain a high quality of life for residents, capitalize on its numerous economic assets, and effectively promote, direct, and manage reinvestments in underused and functionally obsolete properties.”

– City of Wauwatosa Comprehensive Plan, p. 23

This project implements and advances the City’s objectives to reinvest in underused and functionally obsolete properties. The parking garage of the existing buildings is failing and needs extraordinary investment on repairs. These repairs would be throwing good many after bad because the office buildings are obsolete and will not be able to command adequate rents to justify the expense. Furthermore, the office market for class C office is extremely soft with no relief in sight and high vacancy and even bankruptcies for competing properties in the market. This property has become an eyesore for the neighborhood, the parking structure is no longer sound, and the market demand for office product like this is very weak which is why this property is a risk of becoming a blight and needs to be redeveloped.

Furthermore, the City of Wauwatosa’s Housing has identified a significant shortage in all housing types and all new housing promotes competition to help keep housing affordable. This project will offer a variety of unit sizes including one, one with dens, two and three-bedroom units to appeal to a variety of intergenerational residents from active seniors to families with children. The scale of this building is comparable to the scale of the existing buildings on the site and will cluster higher-density residential along transportation corridors. The property is located just a few blocks from the Oak Leaf Trail and bike storage will be incorporated and the garage and outside. Finally, solar panels will be incorporated on the roof and several electric car charges will be included in the garage.

B. Procedure. PUDs must be reviewed and approved in accordance with the procedures of [Section 24.16.050](#). Applications must be signed by all property owners of record.

C. Zoning Map. Approved PUDs must be identified on the zoning map by appending the map symbol "/PUD" as a suffix to the base zoning district classification, as in "R8/PUD."

D. Developer's Statement of Intent. Each PUD application must include a written explanation from the applicant describing the community benefits of the proposed development and how the proposed development provides greater benefits to the city than would a development carried out in accordance with otherwise applicable zoning ordinance standards. The statement must also include a comparison of the proposed development with the standards of the base zoning district.

Applicant Response: The benefits to the community of this development rather than one carried out in accordance to the C2 zoning is that as a mid-rise residential building it is a less intense use than the alternative uses allowed and promotes a mixed-use neighborhood with higher density residential along transportation corridors. The stated purpose of the C2 zoning is to accommodate, "a broad range of business and commercial uses, often in the physical form of shopping centers, large-format retail and other destination-oriented uses in which a large percentage of customers will arrive by automobile." This could include much higher traffic and intense uses such as a grocery store, medical office, other retailers. Unfortunately, while the City's Comprehensive Plan repeatedly calls for mixed-use development, it doesn't actually permit multi-unit residential buildings in commercially zoned areas, which would create mixed-use neighborhoods. Furthermore, there is no height restriction or minimum lot area which would allow a taller building to be built casting a shadow over the single-family neighboring properties to the north. Likewise, adhering to the 10' setback would push the massing of the building closer to the residences casting a shadow over their property.

E. Approval Criteria. A /PUD overlay zoning district may be approved only when the common council determines that the proposed PUD would result in a greater benefit to the city as a whole than would development under conventional zoning district regulations.

F. Standards Eligible for Modification. Unless otherwise expressly approved by the common council as part of the PUD approval process, PUDs are subject to all applicable standards of this zoning ordinance. The common council is authorized to approve PUDs that deviate from strict compliance with specified standards if they determine that the resulting development satisfies the approval criteria of Section 24.05.040E. PUDs may not deviate from compliance with [Title 14](#) (Fire Prevention) or [Title 15](#) (Buildings and Construction) of the city code of ordinances.

G. Allowed Uses. The uses to be allowed in a PUD must be identified as part of the PUD approval process along with all applicable conditions or supplemental use regulations that apply to such uses. Regardless of the underlying zoning, the common council may approve a mix of use types within a PUD as a means of accommodating mixed-use developments and developments with a broader range of housing types and housing options than allowed by the underlying zoning district.

H. Lot Size. Minimum lot area and width standards of the base zoning district may be reduced as part of the PUD approval, provided that lot sizes are adequate to safely accommodate all proposed buildings and site features.

I. Residential Density. The allowable residential density of the base zoning district may be changed if the common council determines that such a change is warranted to support the public benefit likely to result from the proposed development and that the resulting density can be supported by existing and planned public facilities and services.

J. Setbacks. The minimum setback standards of the base zoning district may be reduced as part of the PUD approval.

K. Height. The common council may allow an increase in allowable building heights if it determines that such an increase is warranted to support the public benefit likely to result from the proposed development.



L. Parking and Loading. Off-street parking and loading requirements may be modified when the common council determines that modified requirements are in keeping with projected parking and loading demand of the proposed development, that other means of meeting access demand will be provided or that the requested modifications will better meet the purpose of the PUD overlay.

M. Streets. Alternatives to otherwise "standard" street cross-sections and designs may be approved when the common council determines that such alternative designs would better meet the purpose of the PUD overlay, while still providing a safe and efficient traffic circulation system.

See Next Page...

C2, General Commercial. The C2, General Commercial district accommodates a broad range of business and commercial uses, often in the physical form of shopping centers, large-format retail and other destination-oriented uses in which a large percentage of customers will arrive by automobile.

Lot and Building Standards			Underlying Req. C2	Proposed	Notes
Minimum Lot Area (square feet)			None	n/a	
Minimum Lot Area Per Unit (square feet)[1]			1,000[5]	n/a, applies to vertical mixed-use buildings	
Minimum Lot Width (feet)			None	n/a	
Minimum Setbacks (feet)					
Front			10'	5.5'	see explanation
Street Side			5'	6.3' on East; 4.0' on West	
Interior Side			3[3][5]	n/a	
Rear			10[5]	45.3'	see explanation
Rear and Interior Side (Accessory Buildings)			3	n/a	
Rear Alley (Accessory Buildings)			10	n/a	
Maximum Height (feet)					
Principal Buildings			No max.	46'	4.7' taller than existing W. bldg. There would be not height restriction on a permitted use e.g. office.
Accessory Buildings			20	n/a	
Explanation: Adhering to the 10' setback both eliminates necessary parking and pushes the building closer to the single-family home to the north and could cause a shadow over their property. Our intent is to maximize a buffer to the north between our building and the single-family neighbors to the north while improving the existing conditions where the parking deck wall abuts the neighbor's property to the north along 114th street by bringing parking to grade and screening it with landscaping.					
Maximum Building Coverage (% of lot area)					
Interior Lots			No max.	n/a	
Corner Lots			No max.	n/a	
Parking: Multi-Unit Building	Spaces/Unit	Units	Required	Proposed	
One Bedroom	1	21	21		
Two Bedroom	1.5	17	26		
Three Bedroom	2	3	6		
Total*		41	53	71	see explanation
*28 outdoors + 2 outdoor ADA + 39 in-building + 2 ADA in-building		ratio	1.29	1.73	
Explanation: We will provide sufficient parking for our tenants and guests so they will not park along the street in the neighborhood; with no overnight street parking allowed, we must ensure we have adequate parking to accommodate all of our residents or we may not be able to market/lease some units.					
Permitted Uses:	Multi-Unit Building		-	41 Units	Mixed-Use Vertical Buildings are a permitted use
Estimate of Vehicle Trips Per Day for Existing Office vs. Proposed Multi-Unit Residential					
Existing Offices	Office	S.F		VTPD/1,000 SF	VTPD
	West Building	16,560			
	East Building	9,100			
		25,660		11.03	283
Proposed Multi-Unit Residential	Units	VTPD/Unit (Low Est.)	VTPD/Unit (High Est.)	VTPD Projected (Low Est.)	VTPD Projected (High Est.)
	41	5.44	6.65	223	273
The estimated vehicle trips per day for the proposed multi-unit residential are less than the estimated trips per day for the existing office use.					

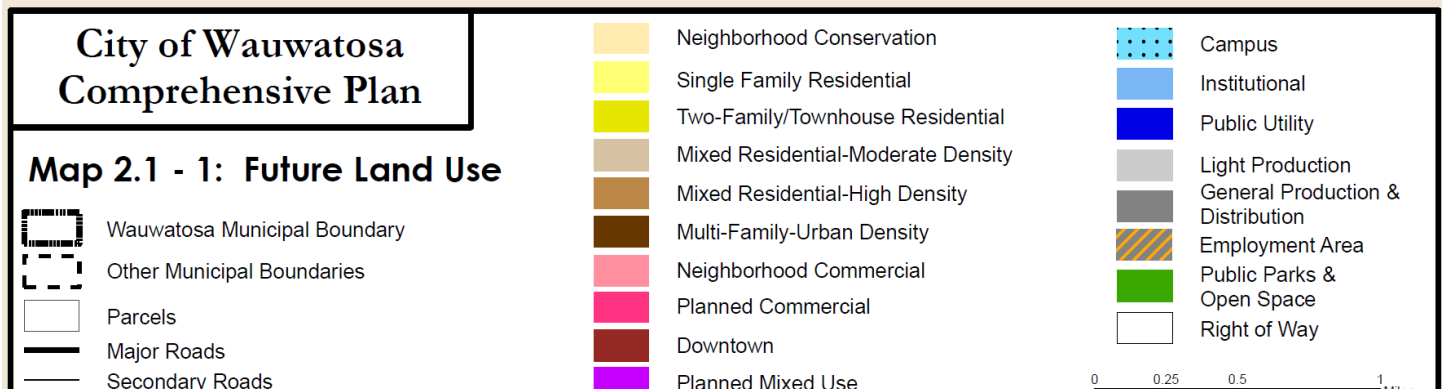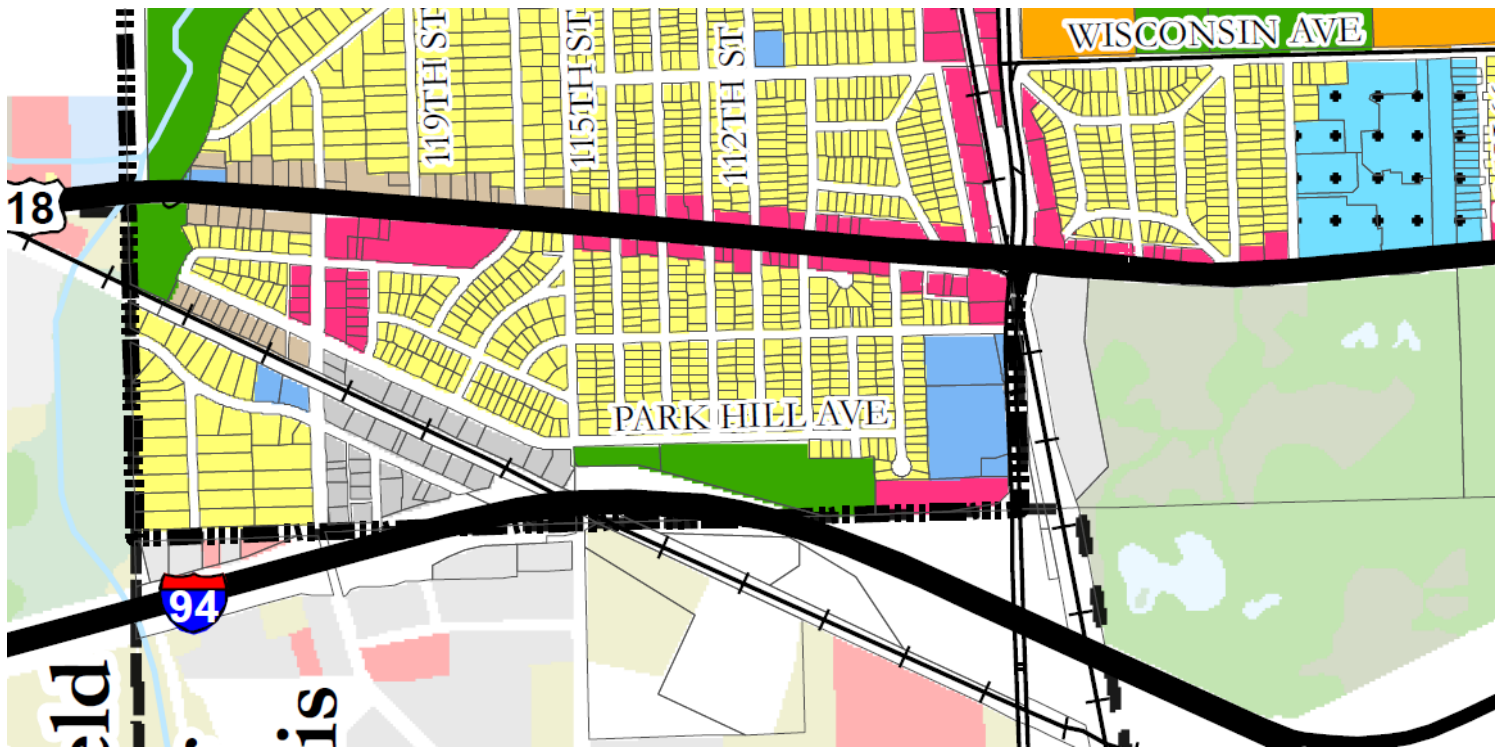



Wauwatosa, WI

7725 W. North Avenue
Wauwatosa, WI 53213

Staff Report

File #: 23-1231

Agenda Date: 4/25/2023

Agenda #: 3.

Ordinance amending the Official Zoning Map of the City of Wauwatosa from C2 District to C2 District/Planned Unit Development Overlay at 11400 W Blue Mound Road and 11430 W Blue Mound Road

The Common Council of the City of Wauwatosa ordains as follows:

Part 1. The Official Zoning Map of the City of Wauwatosa is hereby amended to reflect a Zoning Map Amendment from C2 District to C2 District/Planned Unit Development Overlay at 11400 W Blue Mound Road and 11430 W. Blue Mound Road described as follows:

11400 W. Blue Mound Road - SE QUAR SEC 30-7-21 PARCEL 2 & E 10FT OF PARCEL 1 CERT SURVEY MAP

11430 W. Blue Mound Road - SE QUAR SEC 30-7-21 PARCEL 2 CERT SURV MAP NO 1588

Part II. The City Administrator is hereby directed to change the Official Zoning Map of the City of Wauwatosa to conform to the provisions of the Ordinance, and said Map is declared amended accordingly.

Part III. This ordinance shall take effect on and after its date of publication.

By: Plan Commission

Recommendation: Introduced on April 18, 2023, for adoption consideration



Staff Report

File #: 23-1002

Agenda Date: 4/25/2023

Agenda #: 4.

Request by Jonathan Ward, Altius Building Company, for Planned Unit Development preliminary plans at 11400 W. Blue Mound Road for a multi-unit building

Submitted by:

Tamara Szudy

Department:

Planning Division

A. Background/Options

The applicant is requesting approval of a preliminary planned unit development (PUD) to construct a four-story, multi-family residential housing project on an approximately 0.8 acre site. The proposed project consists 41 apartments with a mix of one, two, and three bedroom units. The main building entrance is located at the corner of 114th Street and the ground floor serves as a parking garage with residential units located on the upper floors. Vehicular access to the site is provided from 114th Street and 115th Street with 71 parking spaces onsite (41 garage spaces and 30 surface spaces). Short-term bicycle parking is provided at the east end of the building adjacent to the main entrance at 114th Street and long-term bicycle storage is provided inside the parking garage. Community amenities include a club room, rooftop terrace, fitness room, rooftop solar, and electric vehicle chargers.

Currently, the project site contains two office buildings with a parking structures at the rear. In 2021, a City inspection revealed significant structural issues with the western parking structure and the structure's certificate of occupancy was revoked. Surrounding land uses include single-family residential uses to the north and commercial uses to the east, west, and south.

The Plan Commission reviewed the project at the March meeting and recommended approval 6-1. The required public hearing before the Common Council was held April 18, 2023 with one person speaking in support of the project and two people providing comment including a concern about the proposed building setback from the Blue Mound Road property line.

Attached to this report are the development plans. The Plan Commission item is linked.

B. Staff comments

Planning/Zoning Division: This request is contingent upon approval of the zoning map amendment and the certified survey map applications. Filing the certified survey map to combine the two properties is required prior to issuing building permits.

The project meets the objectives for a PUD outlined in WMC 24.05.040.A.2 by accomplishing certain housing goals in the City's Comprehensive Plan. Specifically, the project adds to the City's variety of housing types and densities, helps to create a "Complete Neighborhood" along Blue Mound Road by placing residential development adjacent to commercial uses, and serves as a housing option for seniors, young professionals, students, and other residents who cannot afford or do not wish to live in or maintain a single-family home.

The 2022 Wauwatosa vacancy rate for buildings with 4-25 units was 2.5% and for buildings with 26+ units was 2.2%. Given pent up demand from many years where no housing was constructed, the City's large non-resident workforce population, and continued developer interest in undertaking multi-family projects, demonstrates there remains demand for apartments at varying rent levels, including higher end. Vacancy rates are one of the key statistics the National Association of Home Builders track to judge the health and direction of the housing market. Low vacancy rates are typically interpreted as a sign of tight housing markets, with lower vacancy rates signaling a greater housing shortage, and vice versa for high vacancy rates. While the general perception of property vacancies may be a negative one, vacancy on some level is necessary for a healthy market and economy. Healthy vacancy rates ensure rents remain relatively stable and assist employers in recruiting and retaining workers who can find and afford a place to live in the community. The median rental vacancy rate in the United States has hovered around 7% in recent years and an average vacancy rate between 5-8 % is considered healthy. While there is a low vacancy rate, leasing agencies generally advertise because they want potential tenants to inquire about their residential communities and availability to have a database of prospective clients to contact when units become available.

Building Division: Design Review Board approval required; plan review, building permits and DSPS plan approvals required.

Assessor's Office: Provide detailed costs of any alterations and/or new construction, as well as income and expense information as requested by the Assessor's Office.

City Clerk's Office: No issues.

Engineering Division: Site plans showing adequate sewer capacity, construction staging information, lighting, and storm water management subject to approval by the Engineering Division.

The proposed development is located near a geographic high point and lower water pressures may exist. Fire and domestic water demand calculations must be submitted prior to Final PUD plan approval. Hydrant tests will be required by the developer and must be coordinated with the Water and Engineering Departments. Fire flow calculations must be in accordance with City Code Section 14.20.080 and NFPA 13.

All existing utilities that will not be re-used for the proposed development must be abandoned at the main.

Fire Department Connections and emergency access is subject to approval by the Fire Department.

Short- and long-term bicycle parking must be clearly identified and quantified to confirm compliance with City Code 24.11.080. Site data table must include number of housing units provided in each building broken down by type (number of 1-bedroom, 2-bedroom, etc.).

The City is currently anticipating pavement and utility construction in N. 115th Street from Blue Mound Road to Underwood Creek Parkway during the summer of 2023. Applicant shall coordinate locations and construction of proposed utilities and drive approach on N. 115th Street with City staff.

Any public sidewalk damaged during construction must be replaced as directed by the Engineering Department and will require a Street Occupancy permit.

A lighting plan must be submitted and adhere to Board of Public Works rules regulating maximum illumination at property lines.

Applicant shall meet all requirements of code chapter 24.12 pertaining to landscaping; including the requirement for a landscape performance guarantee (Section 24.12.070).

The construction staging plan shows public sidewalk closures on the east, south and west sides of the proposed development. If the public sidewalks are proposed to be closed for long term duration, the sidewalk closure is subject to approval by the Board of Public Works. The construction staging plan must be updated to include the crane swing radius. If the crane swing radius encroaches within the public right-of-way, the encroachment is subject to approval by the Board of Public Works. If the crane swing radius encroaches onto adjacent private property, the applicant will be required to work with affect adjacent property owners for crane swing rights and encroachment. The construction staging plan should also identify existing trees and landscaping that are to remain and how those features will be protected during construction. If any existing public street trees are damaged during construction, the applicant will be required to pay a street tree replacement fee. The construction staging plan must identify where contractor parking will be provided. If contractors will utilize public street parking, local parking regulations must be followed.

Engineering compared the number of trips that will be generated by this multi-family proposal and compared it to the existing office space use. The multi-family use generates 20 more trips (10 more in/10 more out) over the course of a weekday. On a peak hour basis, the multi-family generates 20 fewer trips (25 fewer in/5 more out) during the morning peak hour and 15 fewer trips (5 more in/20 fewer out) during the evening peak hour. Staff does not have any concerns about traffic operations with this proposal.

Fire Department: No comments provided.

Health Department: No comments provided.

Police Department: No comments provided.

C. Recommendation

Staff recommends approval subject to:

1. Approval of the CSM and zoning map amendment applications. Filing the CSM prior to issuing building permits.
2. Approval from the Design Review Board is required prior to submitting for Final PUD approval.
3. The final PUD submission shall include a signage plan describing the allowable number and area of signs or confirm that the base sign code will be utilized for this development.
4. Providing detailed costs of any alterations and/or new construction as well as income and expense information as requested by the Assessor's office.
5. Site plans showing adequate sewer capacity, construction staging information, traffic/access improvements, site lighting, bike parking, and storm water management subject to approval by the Engineering Division. An applicant response to all initial Engineering site plan review comments must be received by the Engineering Department prior to Final PUD application submittal.
6. Fire and domestic water demand calculations must be submitted prior filing Final PUD application.
7. Final plans must meet all requirements pertaining to landscaping and screening in WMC 24.12.
8. Filing application for Final PUD approval within 12 months of the date of Preliminary PUD approval.
9. Obtaining all necessary approvals, licenses, and permits.

WEST 1/4 COR.
SEC. 30-7-21

S1° 43' 03"E 2645.51'

S1° 43' 03"E 1858.59'
W. LINE OF SW 1/4 SEC. 30-7-21

WEST 1/4 COR.
SEC. 30-7-21

CALL DIGGERS' HOTLINE
1-800-242-8511
TOLL FREE
WE STATE (82.075/1974)
REQUIRE MIN. 3 WORK DAYS
NOTICE BEFORE YOU EXCAVATE
MILW. AREA 259-1181

THE UNDERGROUND UTILITY INFORMATION SHOWN ON THIS MAP IS BASED ON FIELD MARKINGS AND INFORMATION FURNISHED BY UTILITY COMPANIES AND THE LOCAL MUNICIPALITY. WHILE THIS INFORMATION IS BELIEVED TO BE RELIABLE, ITS ACCURACY AND COMPLETENESS CANNOT BE GUARANTEED.



LEGEND:	
---	SECTION 1/4 SECTION LINE
---	PROPERTY LINE
---	EASEMENT
X	CHAIN LINK FENCE
---	TREE LINE
OH	OVERHEAD UTILITY LINE
E	ELECTRIC
TEL	TELEPHONE
FO	FIBER OPTIC
CTV	CABLE TV
SAN	SANITARY SEWER
FM	FORCE MAIN
ST	STORM SEWER
W	WATER MAIN
G	GAS
670	EXISTING CONTOUR
WET	WETLAND
FP	FLOODPLAIN
MANHOLE	IRON PIPE FOUND/SET
CATCH BASIN	REBAR FOUND/SET
CATCH BASIN (ROUND)	CHISELED CROSS FOUND/SET
ROOF DRAIN	PK NAIL FOUND/SET
HYDRANT	SPIKE/NAIL
WATER VALVE	MONUMENT
GAS VALVE	BENCHMARK
UTILITY POLE	SIGN
GUY WIRE	DECIDUOUS TREE
GAS METER	CONIFEROUS TREE
ELECTRIC METER	BUSH
UTILITY PEDESTAL	POST
TRAFFIC SIGNAL	
LIGHT POLE	
SOIL BORING	
MONITORING WELL	

GENERAL NOTES:

1. THE UNDERGROUND UTILITY INFORMATION SHOWN ON THIS DRAWING IS BASED ON FIELD LOCATIONS AND/OR RECORDS FURNISHED BY MUNICIPALITIES AND UTILITY COMPANIES. THE LOCATION AND ACCURACY OF WHICH CANNOT BE GUARANTEED. THERE MAY BE ADDITIONAL UNDERGROUND UTILITY INSTALLATIONS WITHIN THE PROJECT AREA THAT ARE NOT SHOWN.

2. VERIFY ACTUAL LOCATIONS AND INVERTS IN THE FIELD. ANY POTENTIAL ERRORS, OMISSIONS, OR DISCREPANCIES SHALL BE BROUGHT TO THE ATTENTION OF THE ENGINEER PRIOR TO PROCEEDING WITH CONSTRUCTION.

3. DRAWING IS BASED ON FIELD SURVEY COMPLETED BY THE SIGMA GROUP ON OCTOBER 5TH, 2022.

4. DATUM FOR THE PROJECT SURVEY IS CITY OF WAUWATOSA. BENCHMARK FOR THE PROJECT SURVEY IS WEST FLANGE BOLT OF HYDRANT AT THE NORTHEAST CORNER OF BLUEMOUND AND 115TH ST. WITH AN ELEVATION OF 237.05.

5. CONTRACTOR TO VERIFY EXISTING CONDITIONS, CONTACT ENGINEER WITH DISCREPANCIES.


114TH AND BLUEMOUND
11430 - 11400 BLUEMOUND ROAD
WAUWATOSA, WISCONSIN

SITE SURVEY


PRELIMINARY
NOT FOR
CONSTRUCTION

SCALE:	1"=20'
PROJECT NO:	21393
DESIGN DATE:	----
PLOT DATE:	1/31/2023
DRAWN BY:	----
CHECKED BY:	----
APPROVED BY:	----
SHEET NO:	C001

THE SIGMA GROUP
Single Source. Sound Solutions.
www.thesigmagroup.com
1300 West Canal Street
Milwaukee, WI 53233
Phone: 414-643-4200
Fax: 414-643-4210

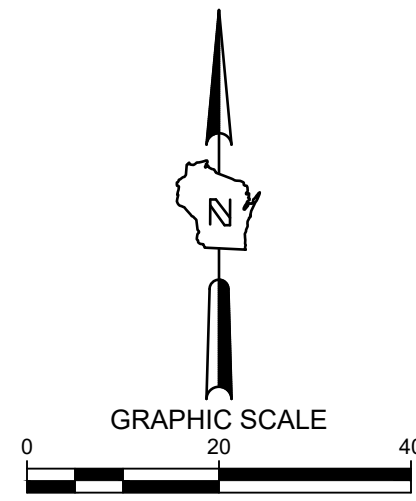

WEST 1/4 COR.
SEC. 30-7-21

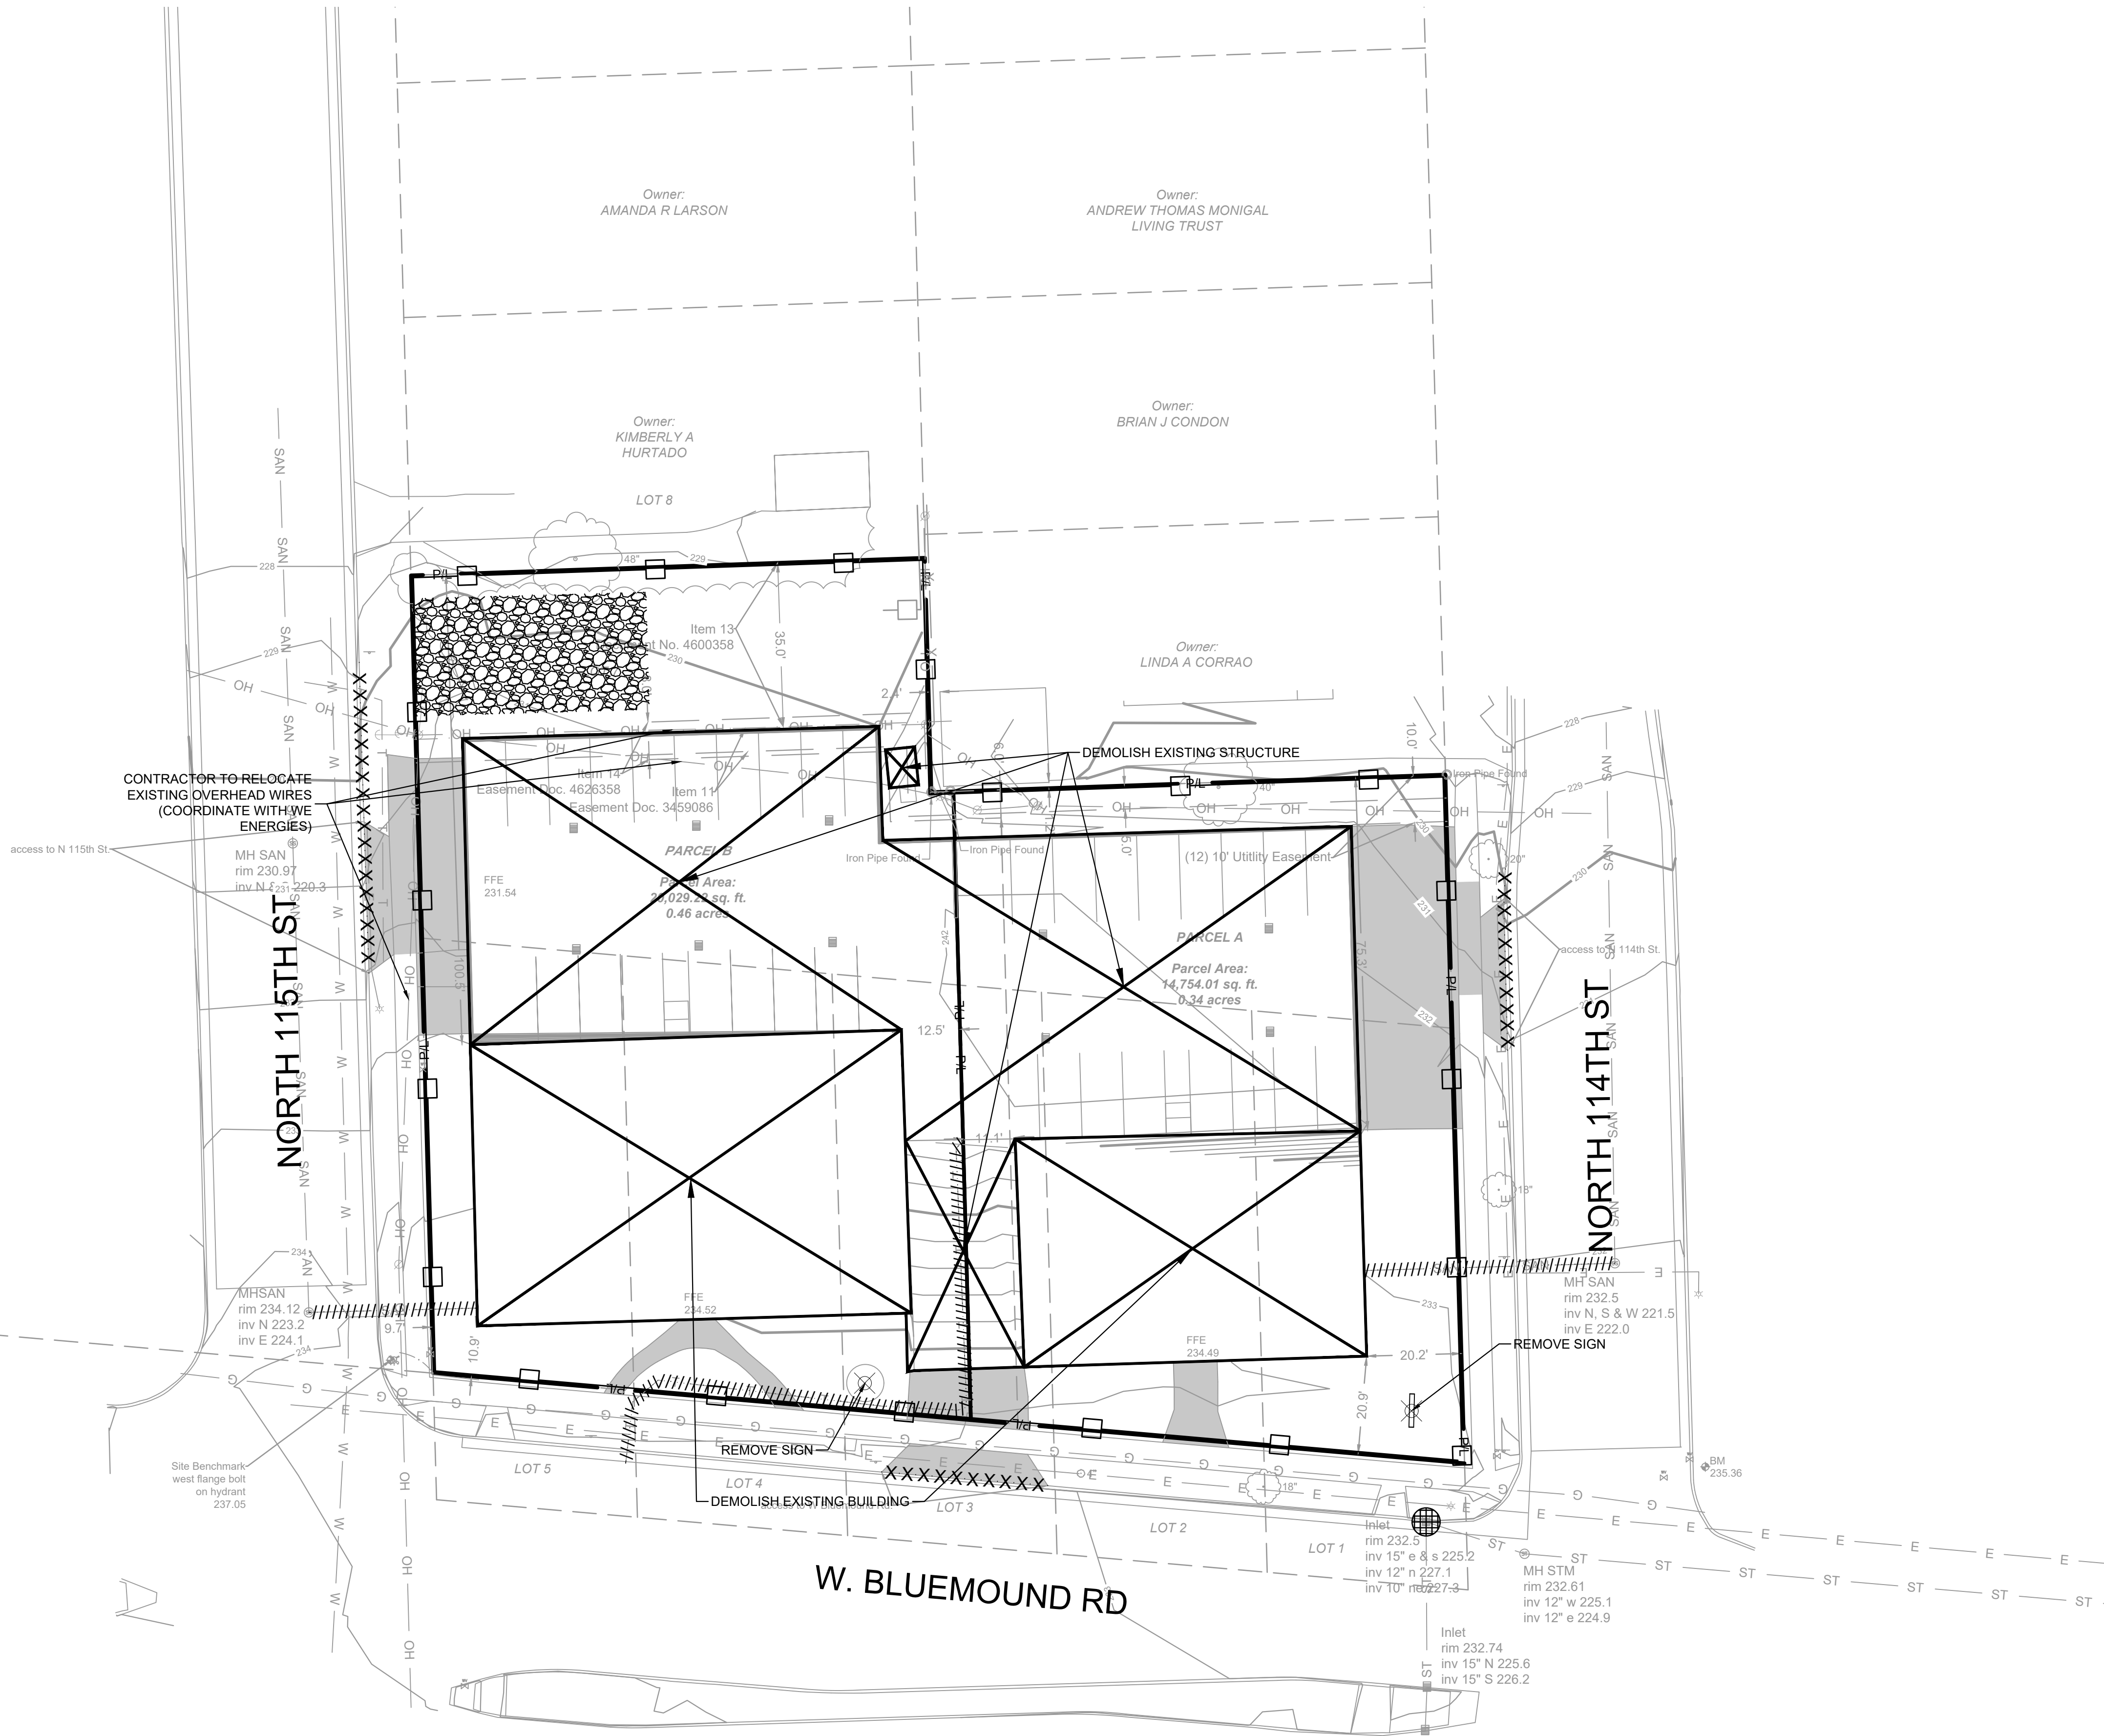

- LEGEND:**
- PROPOSED SILT SOCK
 - PROPOSED INLET PROTECTION
 - PROPOSED TRACKING PAD
 - PROPOSED EROSION MATTING WISDOT APPROVED CLASS 1 TYPE B
 - EXISTING CONTOUR
 - PROPOSED CONTOUR
 - UTILITY REMOVAL
 - CURB REMOVAL
 - STRUCTURE REMOVAL
 - PAVEMENT REMOVAL


- GENERAL NOTES:**
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 - WORK TO BE COMPLETED IS INDICATED IN BOLD TYPE LINES AND EXISTING CONDITIONS ARE INDICATED BY LIGHT TYPE LINES.
 - ELECTRONIC CIVIL FILES ARE AVAILABLE UPON WRITTEN REQUEST. DO NOT USE ELECTRONIC CIVIL FILES TO LAYOUT FOUNDATIONS, COLUMN LINES, LIGHT POLES, OR OTHER NON CIVIL SITE WORK. REFER TO ARCHITECTURAL DRAWINGS FOR DIMENSIONS OF BUILDING AND ARCHITECTURAL FEATURES.
 - SEE SHEET C401 FOR A COMPLETE LIST OF EROSION CONTROL NOTES AND DETAILS. EROSION CONTROL MEASURES SHALL BE INSTALLED PRIOR TO START OF LAND DISTURBING ACTIVITIES.
 - DO NOT BEGIN LAND DISTURBING ACTIVITIES UNTIL AN EROSION CONTROL PERMIT IS OBTAINED FROM LOCAL JURISDICTION.

114TH AND BLUEMOUND
11430 - 11400 BLUEMOUND ROAD
WAUWATOSA, WISCONSIN

EROSION CONTROL PLAN

PRELIMINARY
NOT FOR
CONSTRUCTION

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Milwaukee, WI 53233
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CALL DIGGERS HOTLINE
1-800-242-8511
TOLL FREE
MS STATUTE 182.07(2)(1974)
REQUIRE MIN. 3 WORK DAYS
NOTICE BEFORE YOU EXCAVATE
MILW. AREA 259-1181

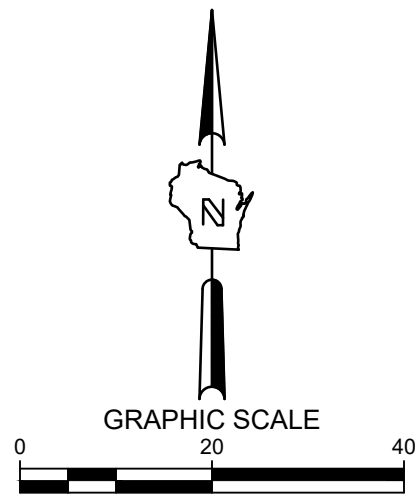
THE UNDERGROUND UTILITY INFORMATION SHOWN ON THIS MAP IS BASED ON FIELD MARKINGS AND INFORMATION FURNISHED BY UTILITY COMPANIES AND THE LOCAL MUNICIPALITY. WHILE THIS INFORMATION IS BELIEVED TO BE RELIABLE, ITS ACCURACY AND COMPLETENESS CANNOT BE GUARANTEED.

SCALE:	1"=20'
PROJECT NO:	21393
DESIGN DATE:	----
PLOT DATE:	2023.01.31
DRAWN BY:	----
CHECKED BY:	----
APPROVED BY:	----
SHEET NO:	C002



CALL DIGGERS HOTLINE
1-800-242-8511
TOLL FREE
WIS STATUTE 182.07(2)(197A)
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SITE INFORMATION			
SITE AREA	34783	0.799 AC	
SITE DISTURBED AREA	34783	0.799 AC	
EXISTING IMPERVIOUS AREA	26310	0.604 AC	75.6 %
PROPOSED IMPERVIOUS AREA	30065	0.690 AC	86.4 %
TOTAL OUTDOOR PARKING SPACES	28		
OUTDOOR ADA PARKING SPACES	2		
TOTAL UNDERGROUND PARKING SPACES	39		
UNDERGROUND ADA PARKING SPACES	2		
TOTAL PARKING PROVIDED	71		

B

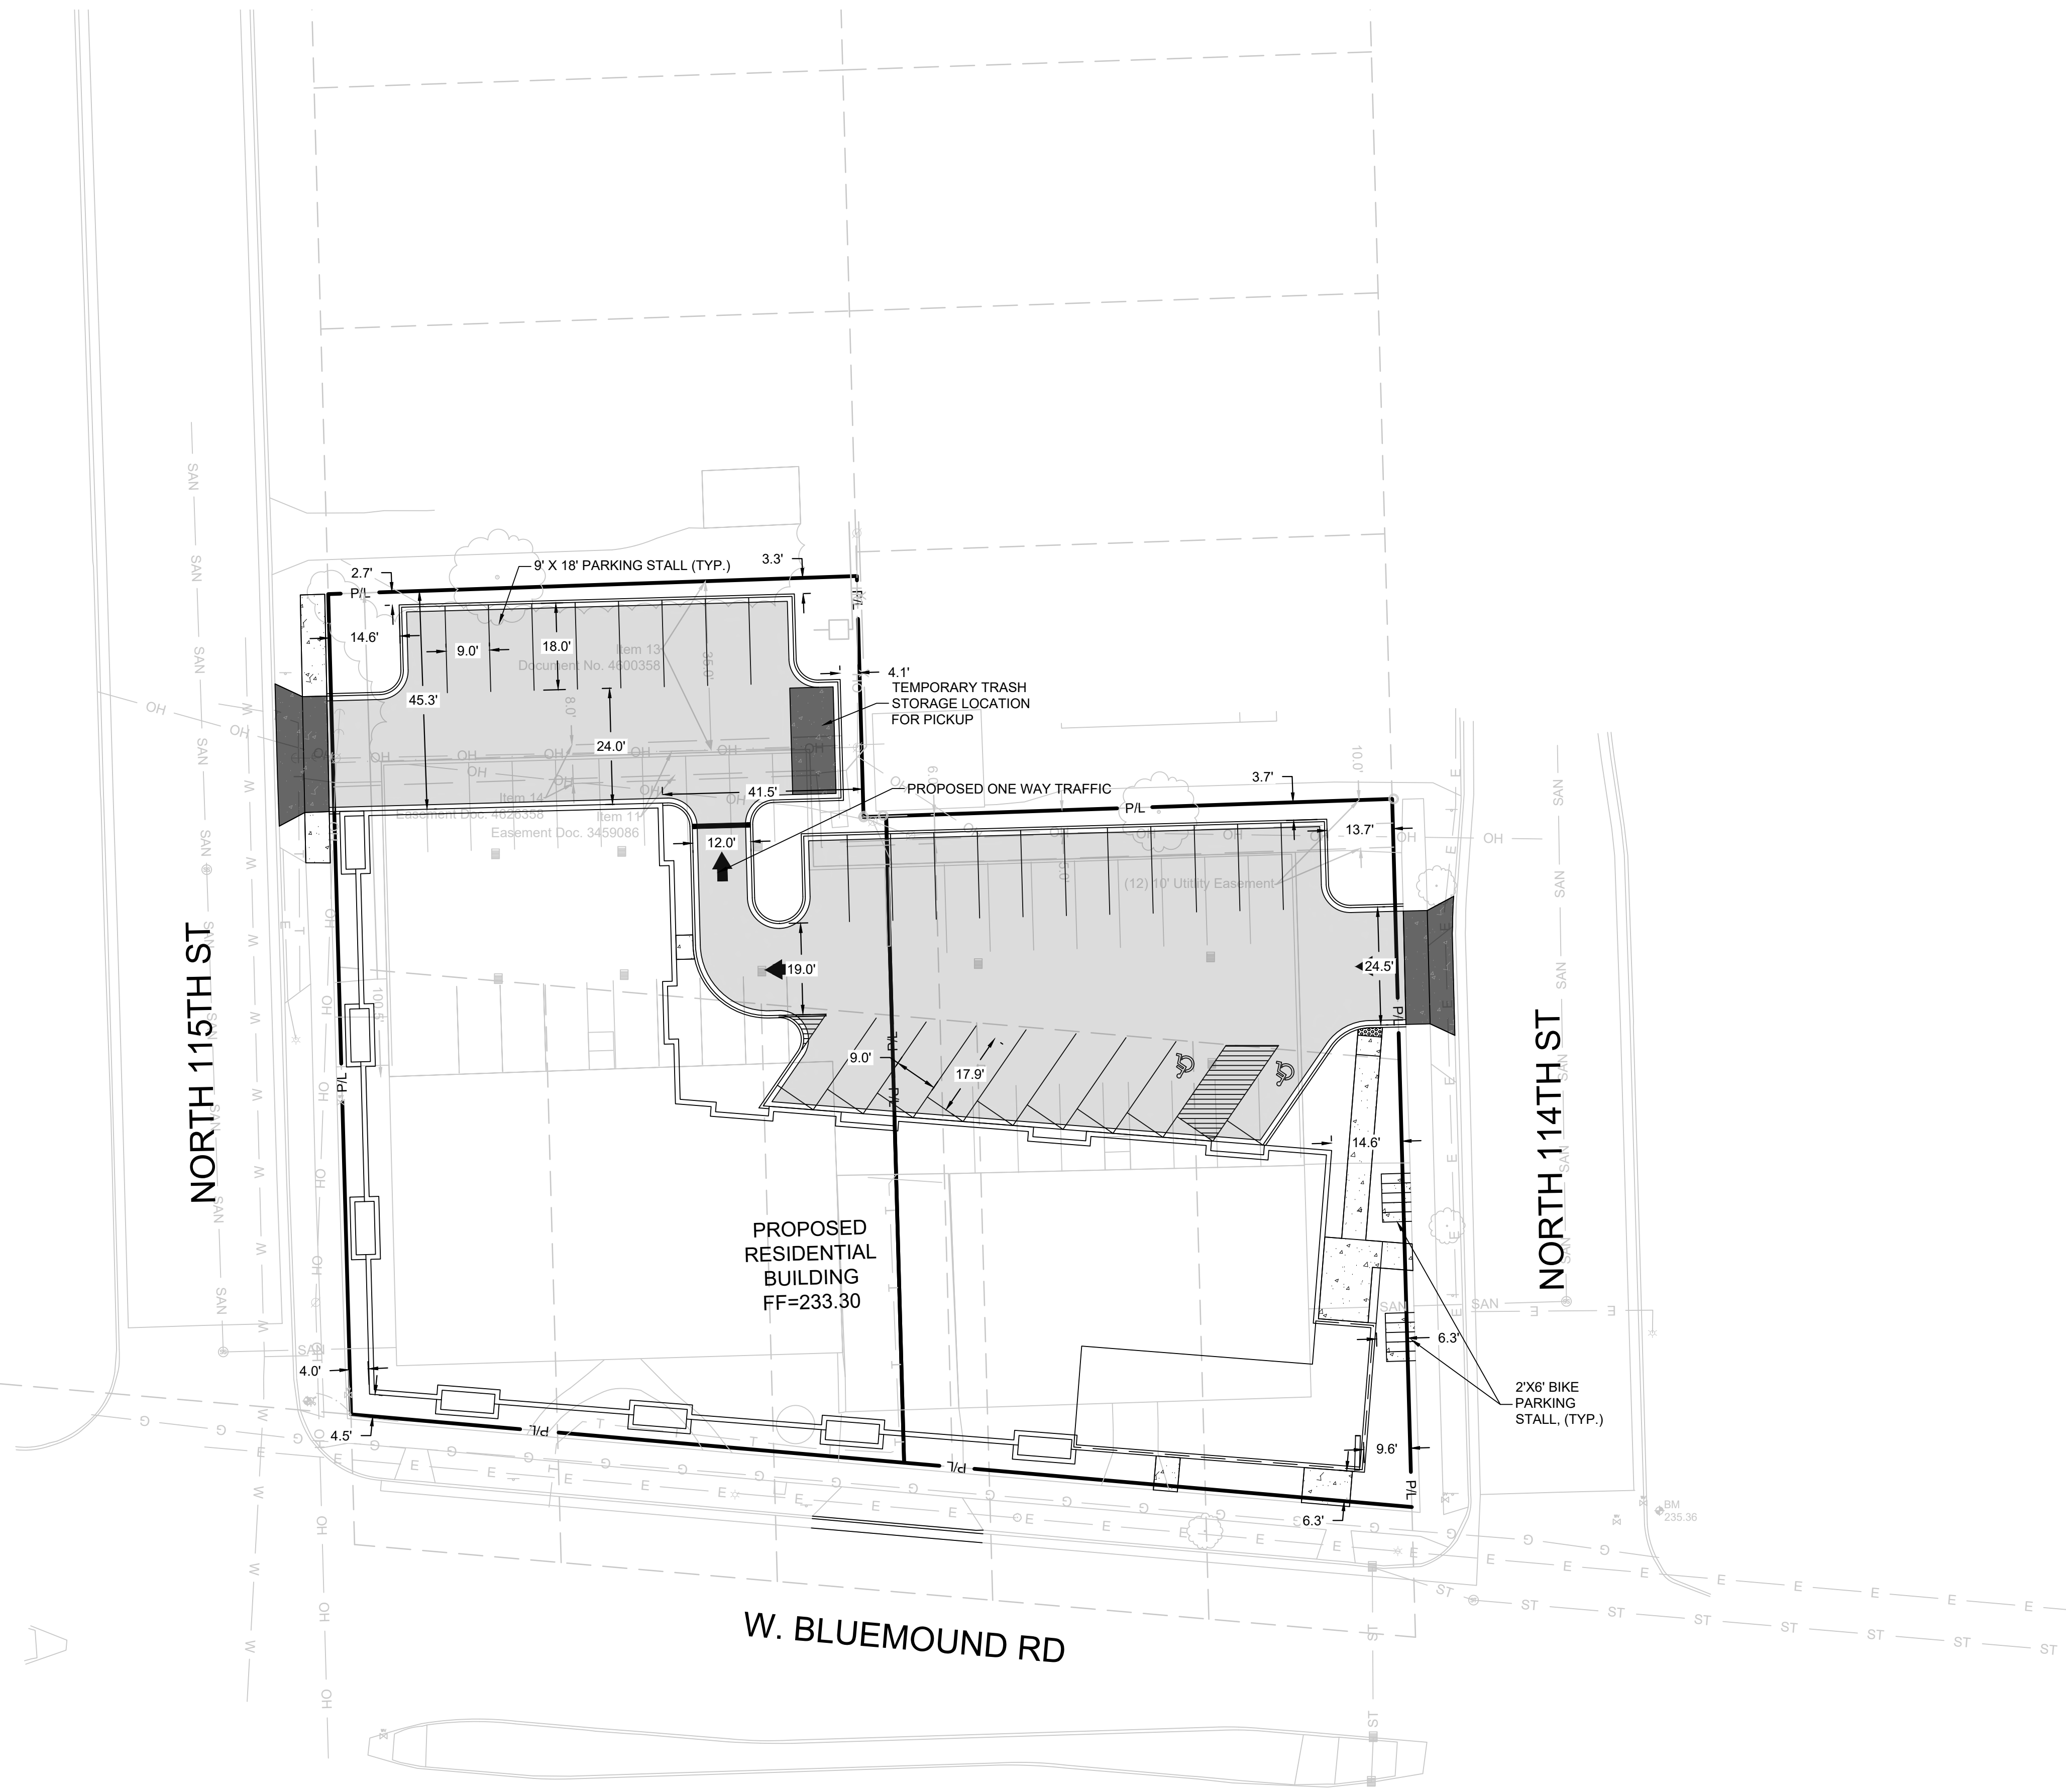C401

C

C401

D

C401

5" THICK CONCRETE WALK

HEAVY DUTY CONCRETE PAVEMENT

ASPHALT SURFACE

A

C401

A

C401

CURB & GUTTER (ACCEPT)

CURB & GUTTER (REJECT)

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3. WORK TO BE COMPLETED IS INDICATED IN BOLD TYPE LINES AND EXISTING CONDITIONS ARE INDICATED BY LIGHT TYPE LINES.

4. ELECTRONIC CIVIL FILES ARE AVAILABLE UPON WRITTEN REQUEST. DO NOT USE ELECTRONIC CIVIL FILES TO LAYOUT FOUNDATIONS, COLUMN LINES, LIGHT POLES, OR OTHER NON CIVIL SITE WORK. REFER TO ARCHITECTURAL DRAWINGS FOR DIMENSIONS OF BUILDING AND ARCHITECTURAL FEATURES.

5. DIMENSIONS ARE FROM FACE OF CURB OR EDGE OF PAVEMENT.

6. WORK WITHIN THE PUBLIC RIGHT OF WAY, INCLUDING BUT NOT LIMITED TO DRIVEWAY OPENINGS, SIDEWALK AND RAMPS, PAVING, AND CURB AND GUTTER SHALL BE COMPLETED PER MUNICIPAL AND/OR COUNTY REQUIREMENTS AND STANDARDS.

7. EARTHWORK SHALL BE IN ACCORDANCE WITH GEOTECHNICAL ENGINEER'S RECOMMENDATIONS.

THESIGMA GROUP

Single Source. Sound Solutions.

www.thesigmagroup.com

1300 West Canal Street

Milwaukee, WI 53233

Phone: 414-643-4200

Fax: 414-643-4210

N

GRAPHIC SCALE

0 20 40

114TH AND BLUEMOUND

11430 - 11400 BLUEMOUND ROAD

WAUWATOSA, WISCONSIN

SITE PLAN

PRELIMINARY

NOT FOR

CONSTRUCTION

SCALE: 1"=20'

PROJECT NO: 21393

DESIGN DATE: ----

PLOT DATE: 1/31/2023

DRAWN BY: ----

CHECKED BY: ----

APPROVED BY: ----

SHEET NO: C100

I:\Altius Building\21393 - 114th and Bluemound\060 CAD\030_Production Sheets\100_Civil\C100 Site Plan.dwg

WEST 1/4 COR.
SEC. 30-7-21

W. LINE OF SW 1/4 SEC. 30-7-21



CALL DIGGERS HOTLINE
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- LEGEND:**
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- GENERAL NOTES:**
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GRAPHIC SCALE
0 20 40

114TH AND BLUEMOUND
11430 - 11400 BLUEMOUND ROAD
WAUWATOSA, WISCONSIN

GRADING PLAN

PRELIMINARY
NOT FOR
CONSTRUCTION

SCALE:	1"=20'
PROJECT NO:	21393
DESIGN DATE:	----
PLOT DATE:	1/31/2023
DRAWN BY:	----
CHECKED BY:	----
APPROVED BY:	----
SHEET NO:	C200

WEST 1/4 COR.
SEC. 30-7-21

W. LINE OF SW 1/4 SEC. 30-7-21



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TOLL FREE

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- LEGEND:**
- W— PROPOSED WATER SERVICE
 - SAN— PROPOSED SANITARY SERVICE
 - ST— PROPOSED STORM SEWER
 - PROPOSED STORM INLET
 - PROPOSED STORM MANHOLE

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 - ALL UTILITIES WITHIN 5 FEET OF PAVED AREAS SHALL REQUIRE GRANULAR BACKFILL. SLURRY BACKFILL IS REQUIRED FOR ALL WORK IN PUBLIC RIGHT OF WAY.
 - PRIVATE STORM INLETS IN PAVEMENT SHALL REQUIRE DRAIN TILE STUBS OF 10 FEET IN TWO DIRECTIONS FOR SUBDRAINAGE. RIM GRADE FOR STORM INLETS IN CURB AND GUTTER ARE FLOW LINE GRADES.
 - WORK IN PUBLIC RIGHT OF WAY SHALL FOLLOW MATERIAL AND INSTALLATION REQUIREMENTS PER MUNICIPAL AND/OR COUNTY.
 - PRIVATE STORM SEWER 12-INCH DIAMETER OR LARGER SHALL BE HDPE. BELOW 12-INCH DIAMETER SHALL BE PVC SDR-35 ASTM D3034. PRIVATE WATER MAIN SHALL BE CLASS 235 DR 18 PVC CONFORMING TO AWWA C-900. PRIVATE SANITARY SEWER SHALL BE PVC SDR-35 ASTM D3034.
 - COORDINATE FINAL LOCATION AND DESIGN OF PRIVATE UTILITY SERVICES (ELECTRIC, GAS, PHONE, CABLE) WITH UTILITY COMPANIES.
 - IF PROJECT IS DESIGN BUILD MEP, THE GENERAL CONTRACTOR IS REQUIRED TO PROVIDE FINAL SEWER AND WATER DESIGN SHOWING LOCATION, INVERTS AND SIZES TO THE ENGINEER FOR FINAL REVIEW AND VERIFICATION PRIOR TO STARTING UNDERGROUND UTILITY CONSTRUCTION.
 - WATER MAIN CONNECTION: TAP WATER MAIN WITH SIZE AND LOCATION INDICATED ON PLAN IN ACCORDANCE WITH LOCAL WATER UTILITY REQUIREMENTS. COORDINATE CONNECTION WITH LOCAL WATER UTILITY. ALL JOINTS SHALL BE RESTRAINED FROM CONNECTION OF WATER MAIN TO BUILDING WALL. SUBMIT JOINT RESTRAINT DETAILS FOR ALL JOINT TYPES INCLUDING PUSH-ON AND MECHANICAL CONNECTIONS. INSTALL MEGA-LUG OR APPROVED EQUAL TIGHT TO WALL FOR RESTRAINT FOR ALL BUILDING WALL PENETRATIONS AS APPROVED BY LOCAL PLUMBING INSPECTOR AND WATER UTILITY. INSTALL THRUST BLOCKING AND MEGA-LUG AT BEND BELOW FLOOR FOR ALL FLOOR PENETRATIONS.
 - INSTALL JOINT RESTRAINT AND CONCRETE THRUST BLOCKS AT ALL OFFSET FITTINGS (TEES, BENDS, DEAD ENDS, VALVES, REDUCERS) USING MEGA-LUG OR APPROVED EQUAL. CONCRETE THRUST BLOCKS SHALL BE INSTALLED PER FILE NO'S:44,45,46 FROM THE STANDARD SPECIFICATIONS FOR SEWER AND WATER CONSTRUCTION IN WISCONSIN. SEE DETAIL FOR MINIMUM LENGTH OF RESTRAINED JOINT REQUIRED. SUBMIT JOINT RESTRAINT DETAILS FOR ALL JOINT TYPES INCLUDING PUSH-ON AND MECHANICAL CONNECTIONS.

114TH AND BLUEMOUND
11430 - 11400 BLUEMOUND ROAD
WAUWATOSA, WISCONSIN

UTILITY PLAN

PRELIMINARY
NOT FOR
CONSTRUCTION


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PROJECT NO:	21393
DESIGN DATE:	----
PLOT DATE:	1/31/2023
DRAWN BY:	----
CHECKED BY:	----
APPROVED BY:	----
SHEET NO:	C300

11:22


JRICHO

C401


21393

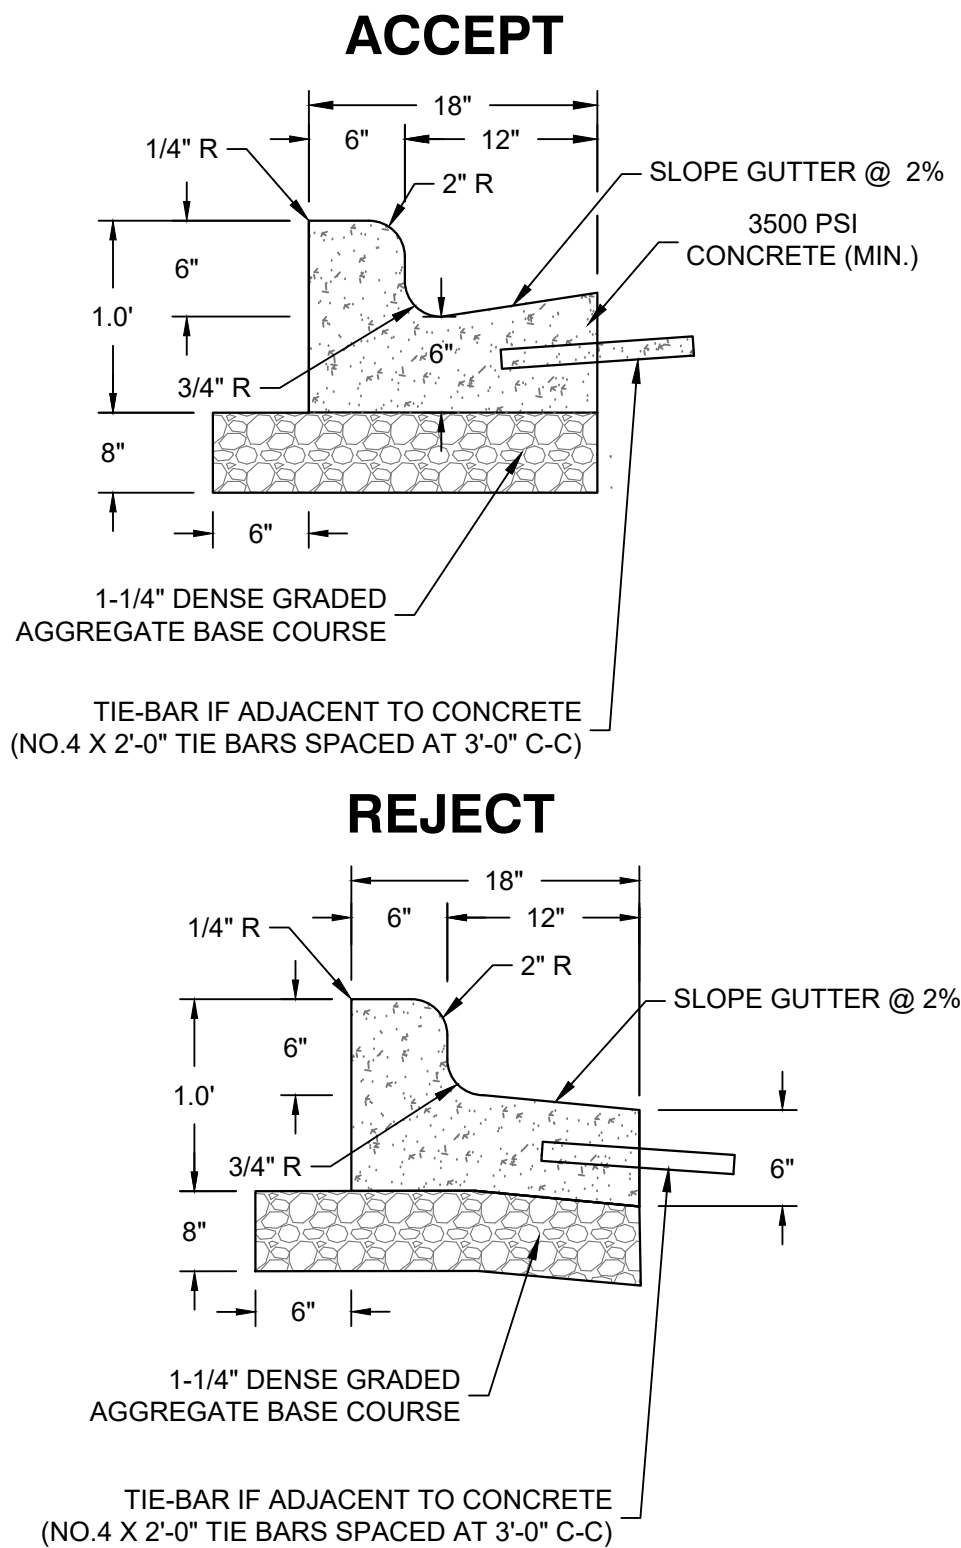


A 18 INCH CONCRETE CURB AND GUTTER
SCALE: NTS

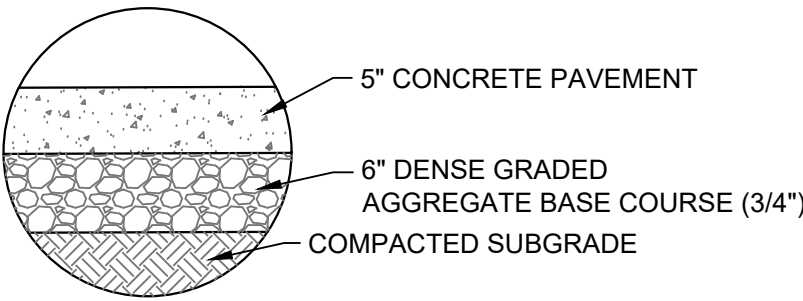


B CONCRETE SIDEWALK SECTION
SCALE: NTS

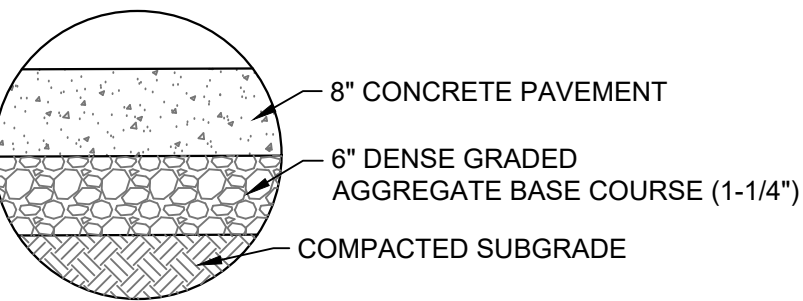


C CONCRETE PAVEMENT SECTION
SCALE: NTS

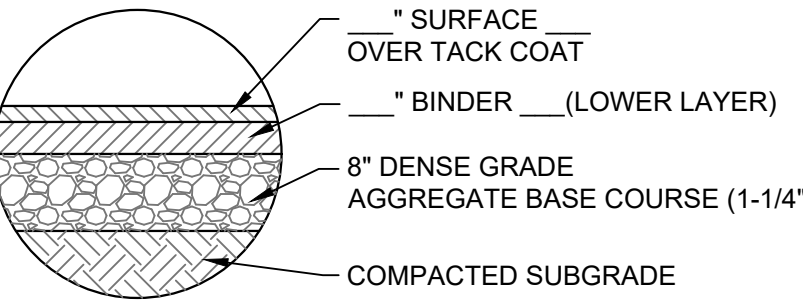



D ASPHALT PAVEMENT SECTION
SCALE: NTS

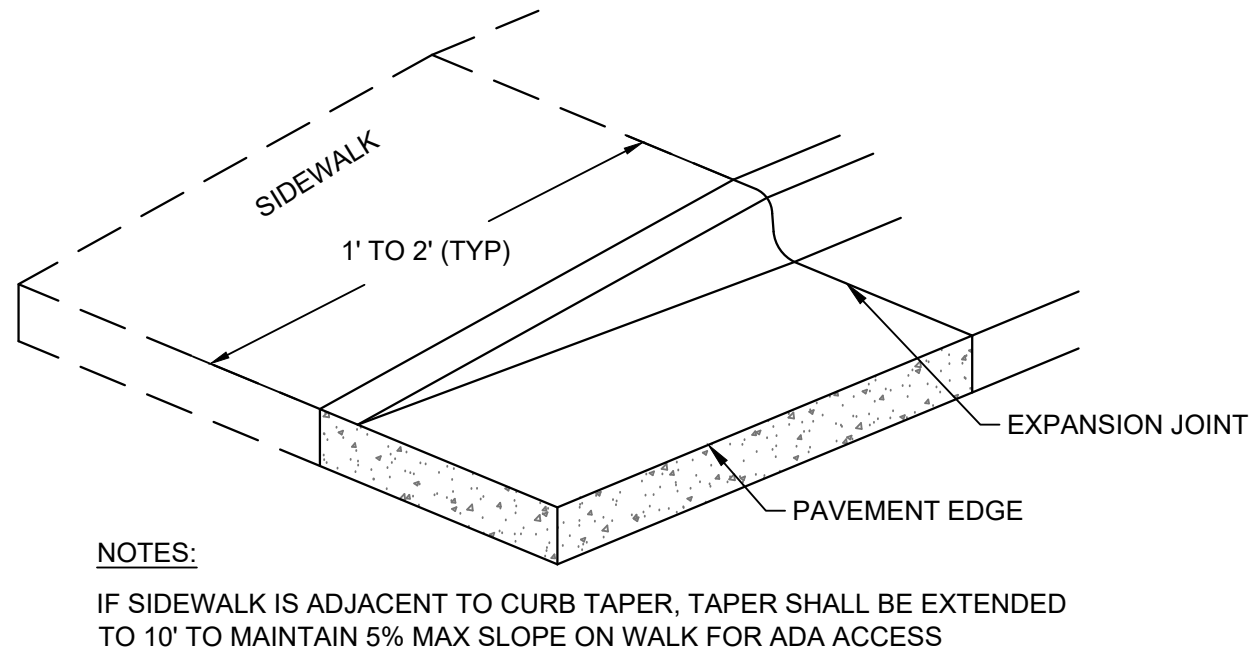

E CURB TAPER
SCALE: NTS

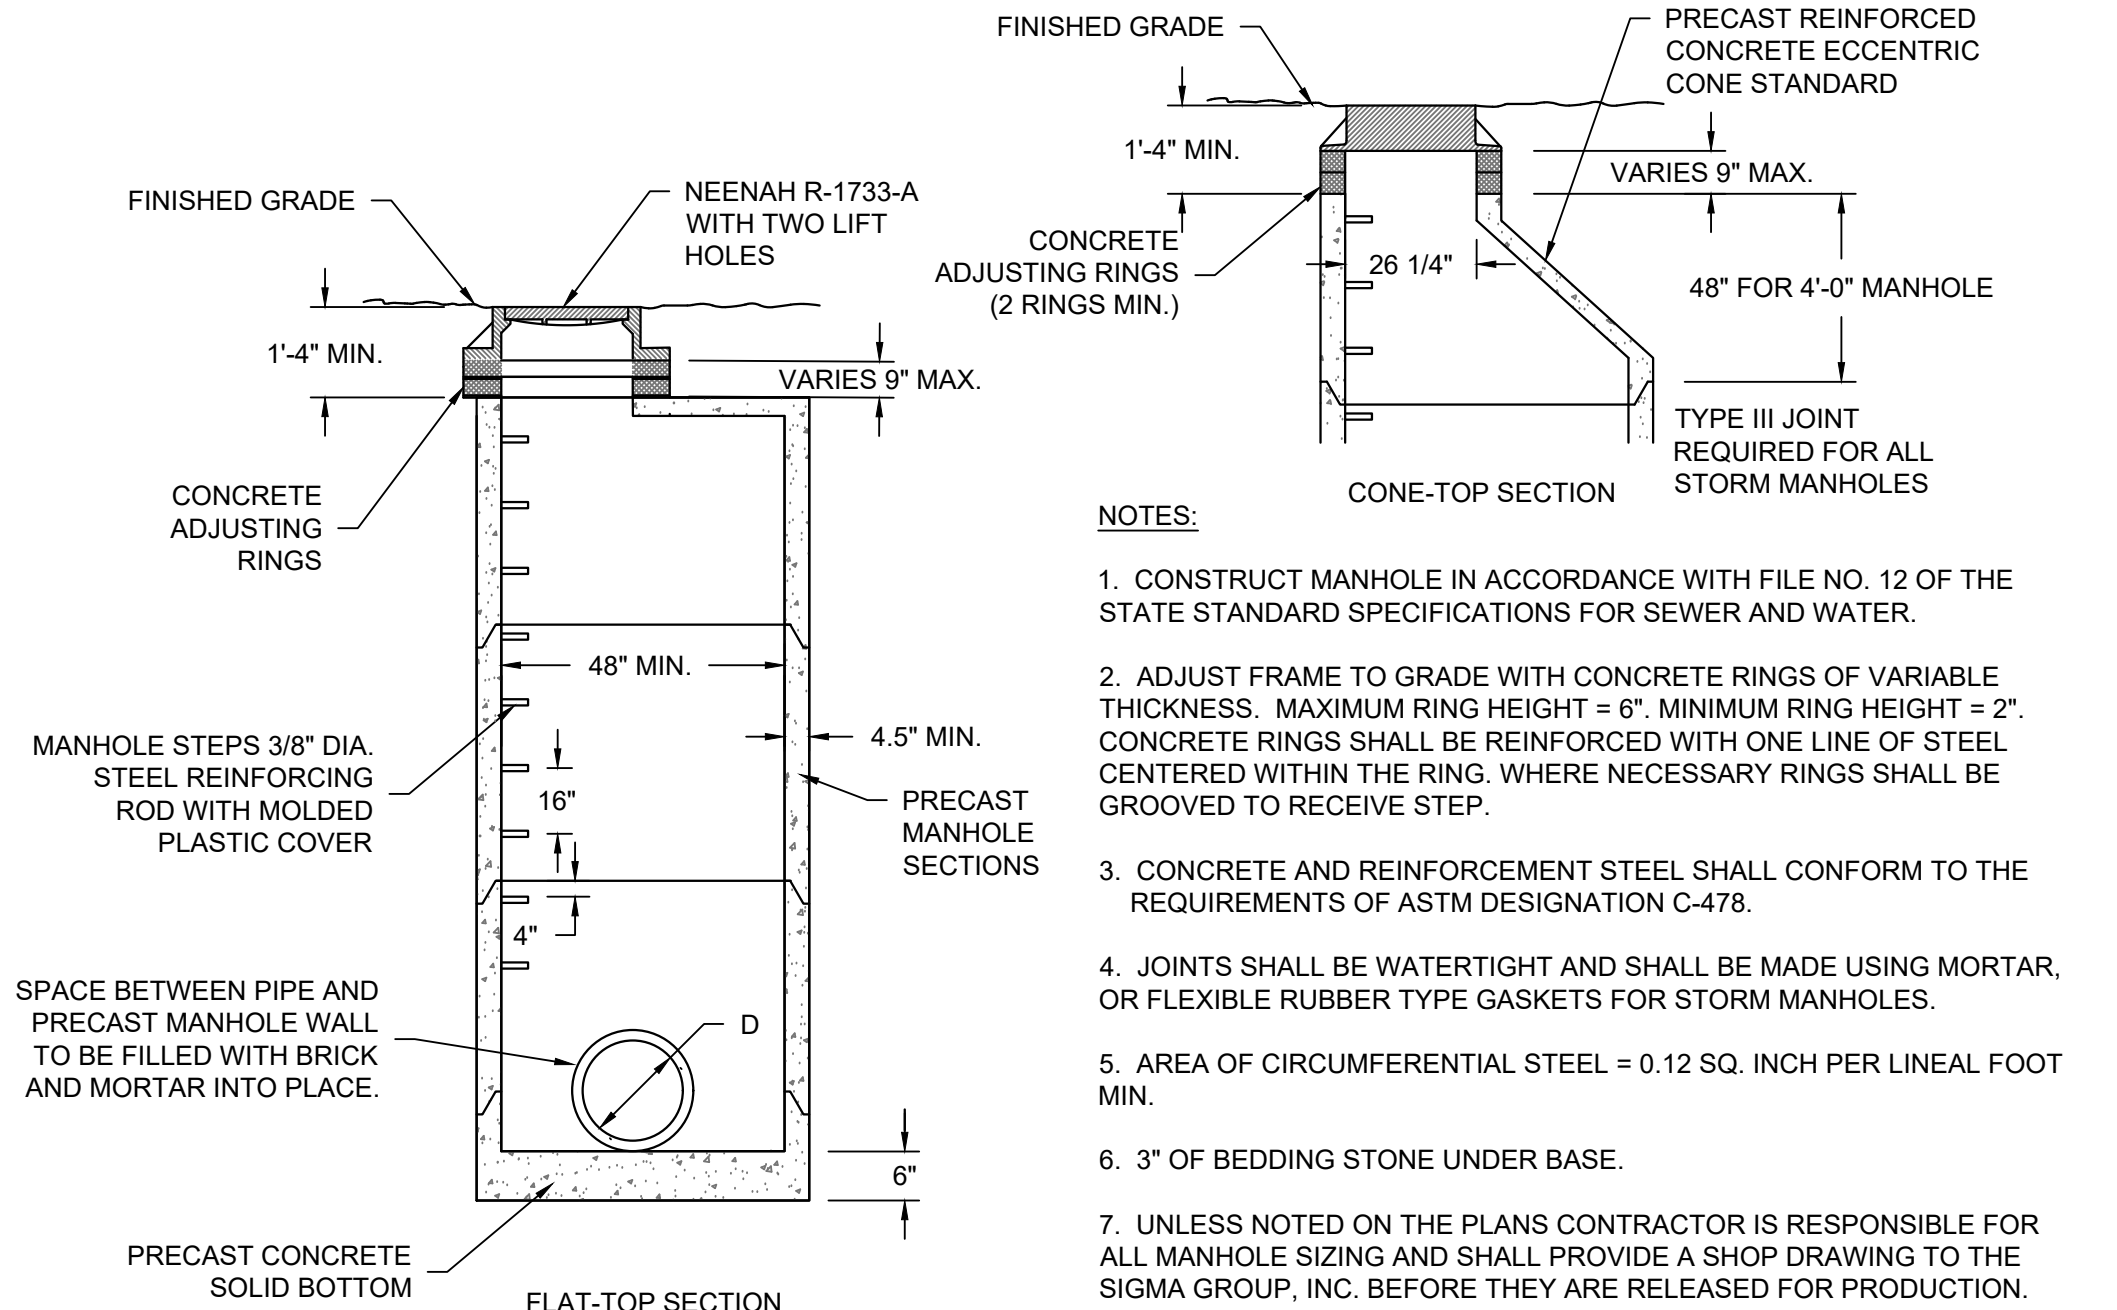


G PRECAST STORM MANHOLE
SCALE: NTS

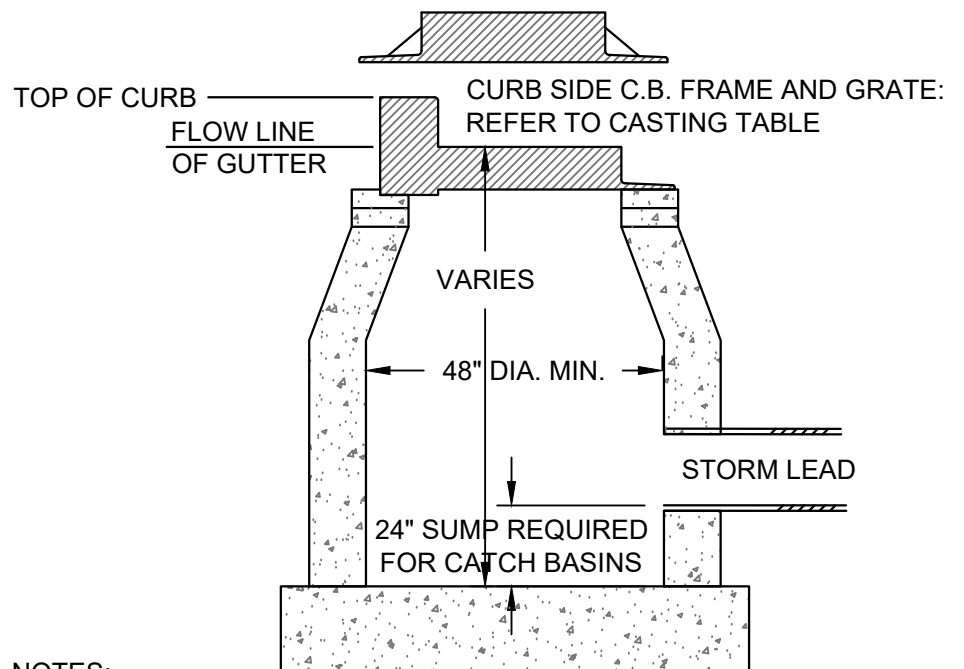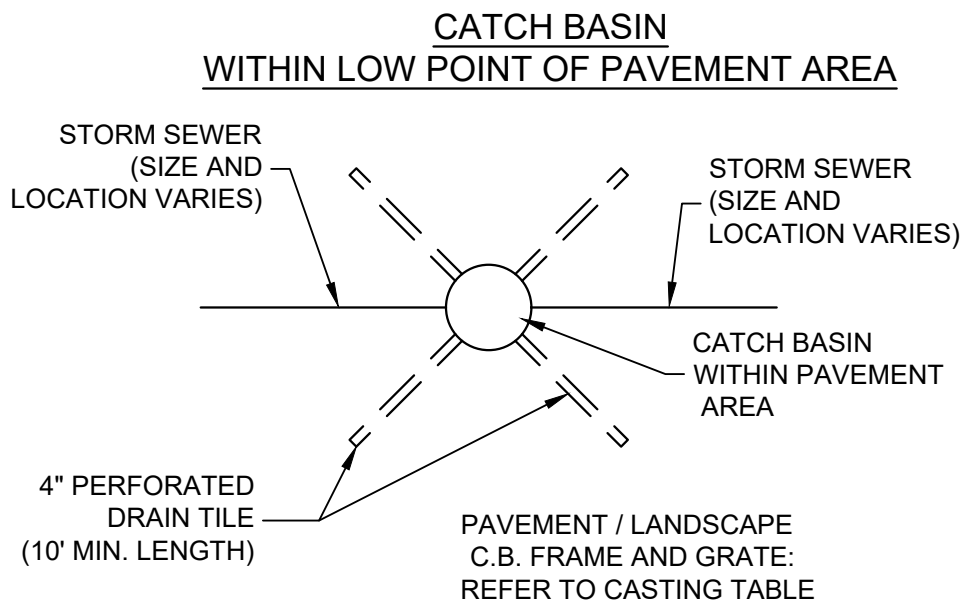



- NOTES:
1. ADJUST FRAME TO GRADE WITH CONCRETE RINGS OF VARIABLE THICKNESS. MAXIMUM RING HEIGHT = 6". MINIMUM RING HEIGHT = 2". CONCRETE RINGS SHALL BE REINFORCED WITH ONE LINE OF STEEL CENTERED WITHIN THE RING.
 2. CONCRETE AND REINFORCEMENT STEEL SHALL CONFORM TO THE REQUIREMENTS OF ASTM DESIGNATION C-478.
 3. 3" BEDDING OF STONE UNDER BASE REQUIRED ON WET SUB-GRADE.
 4. UNLESS NOTED ON THE PLANS CONTRACTOR IS RESPONSIBLE FOR ALL CATCH BASIN SIZING AND SHALL PROVIDE A SHOP DRAWING TO THE SIGMA GROUP, INC. BEFORE THEY ARE RELEASED FOR PRODUCTION.

F INLET AND CATCH BASIN
SCALE: NTS

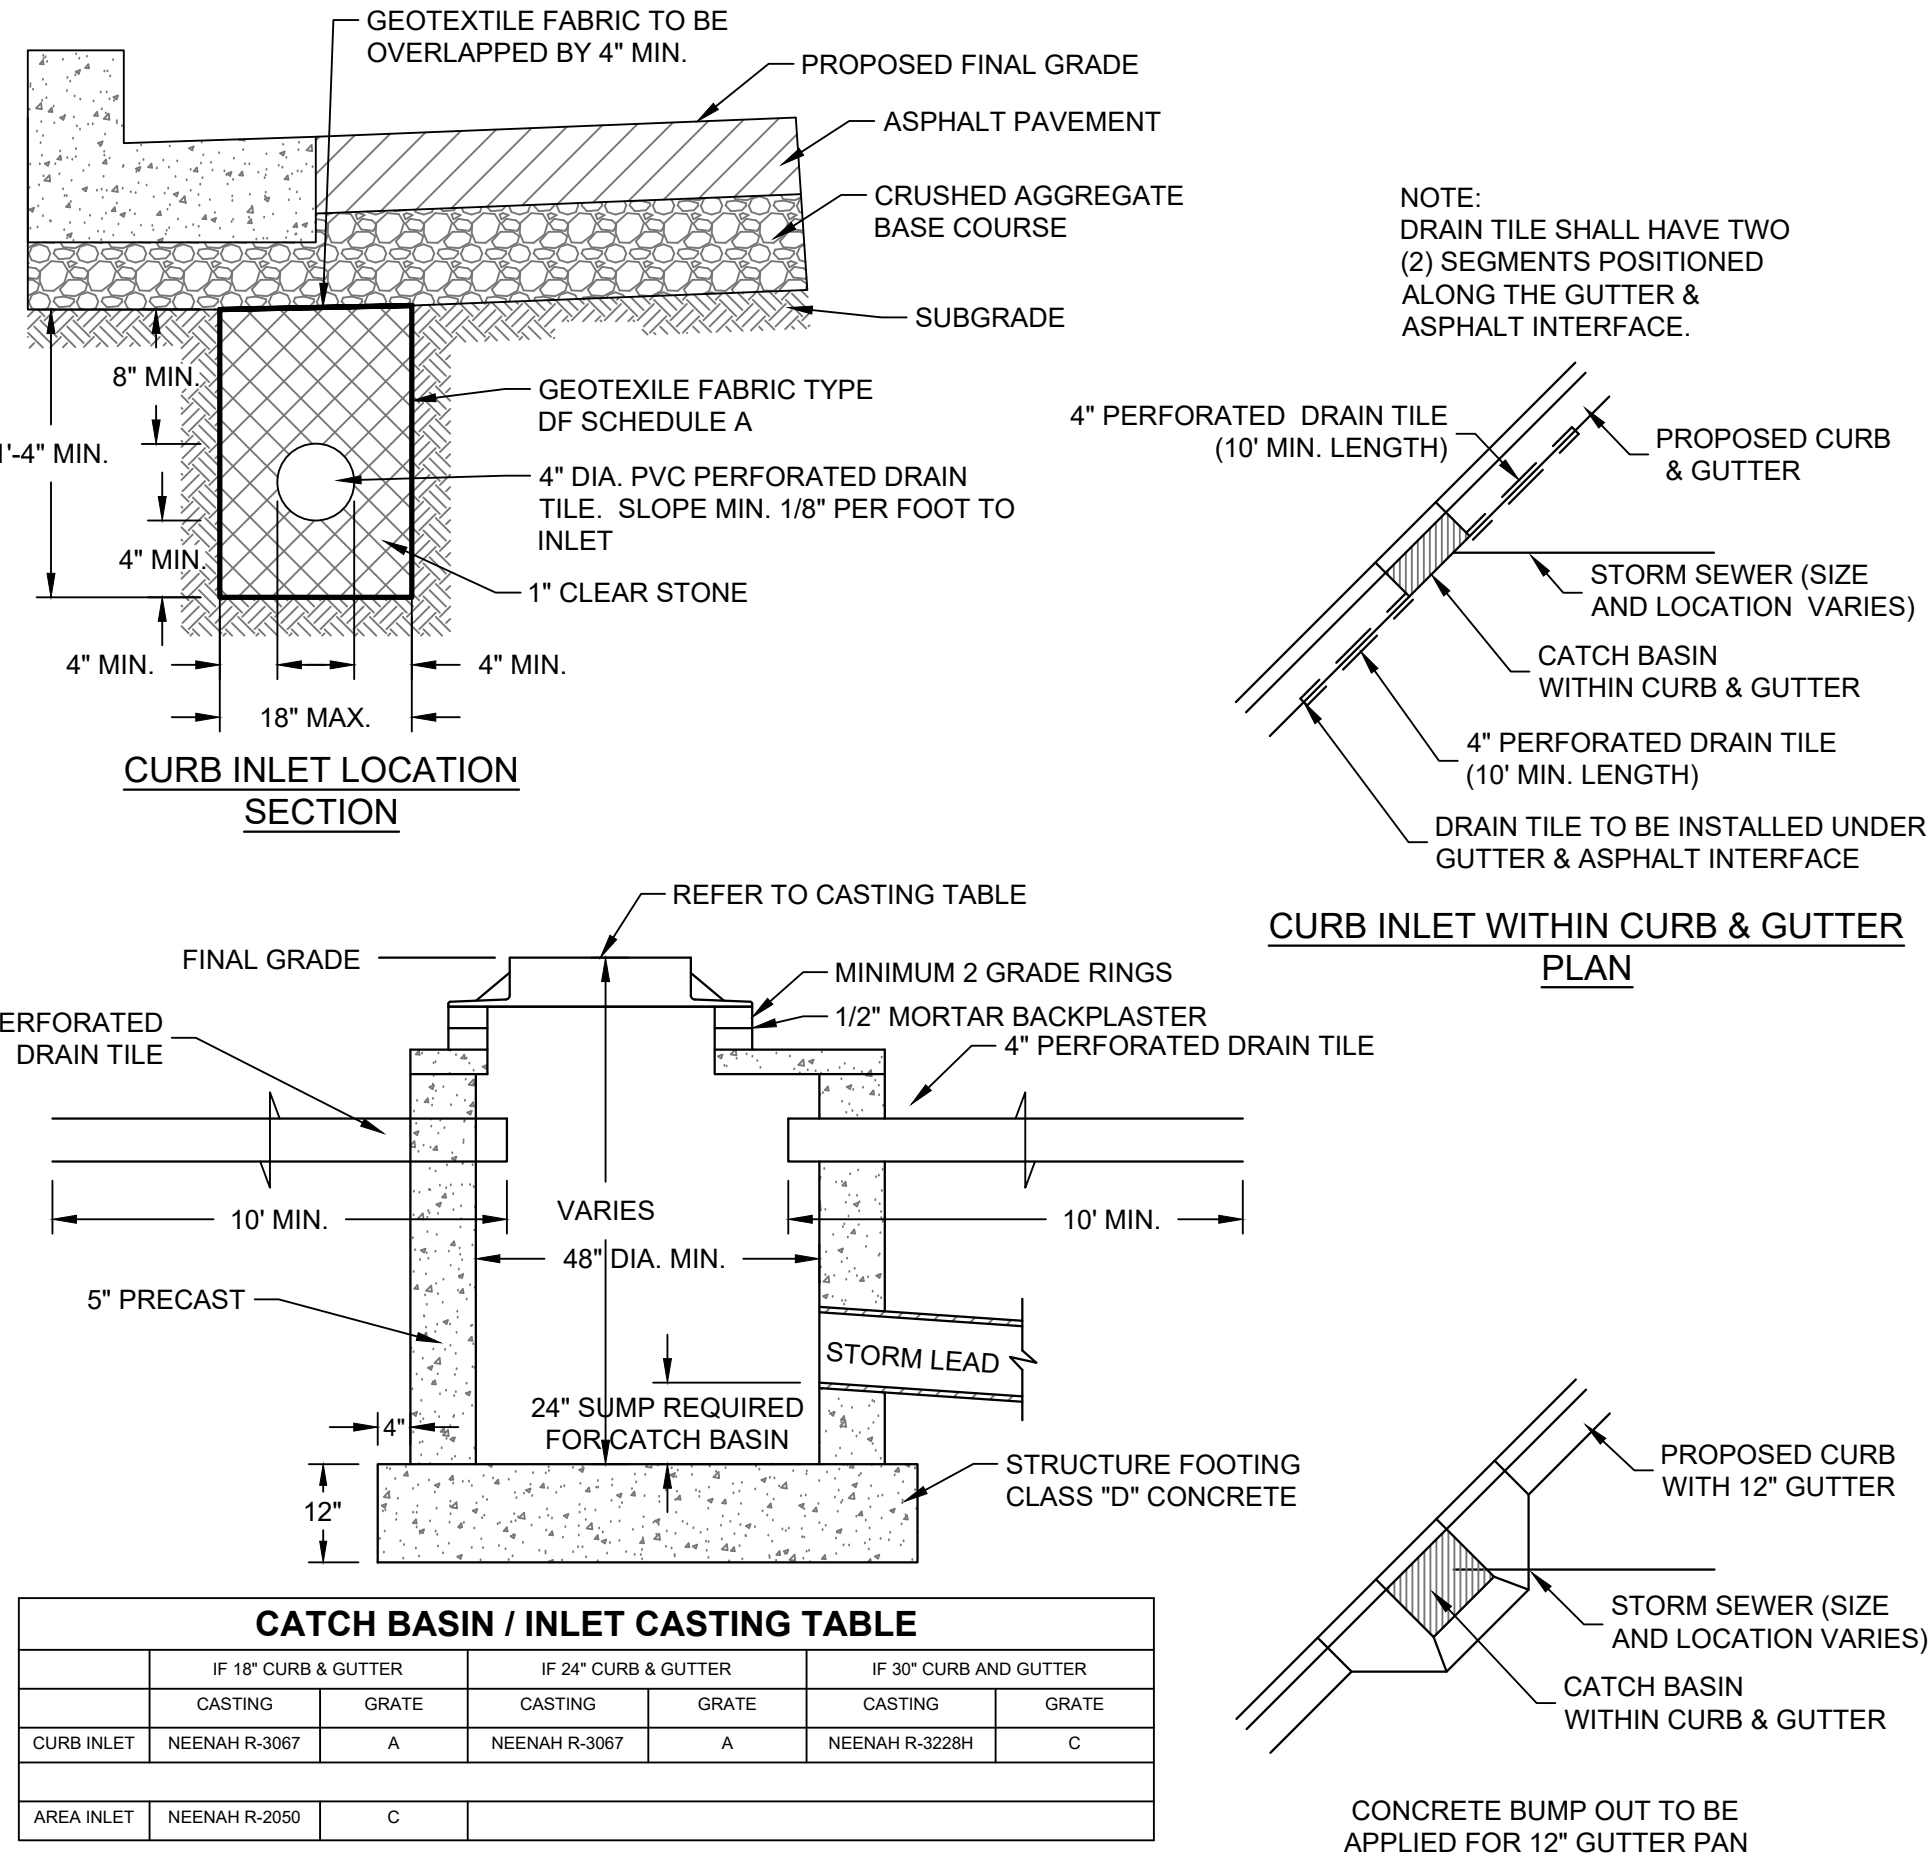


CATCH BASIN / INLET CASTING TABLE						
IF 18" CURB & GUTTER			IF 24" CURB & GUTTER		IF 30" CURB AND GUTTER	
CASTING		GRATE	CASTING		GRATE	
CASTING		GRATE	CASTING		GRATE	
CURB INLET	NEENAH R-3067	A	NEENAH R-3067	A	NEENAH R-3228H	C
AREA INLET	NEENAH R-2050	C				

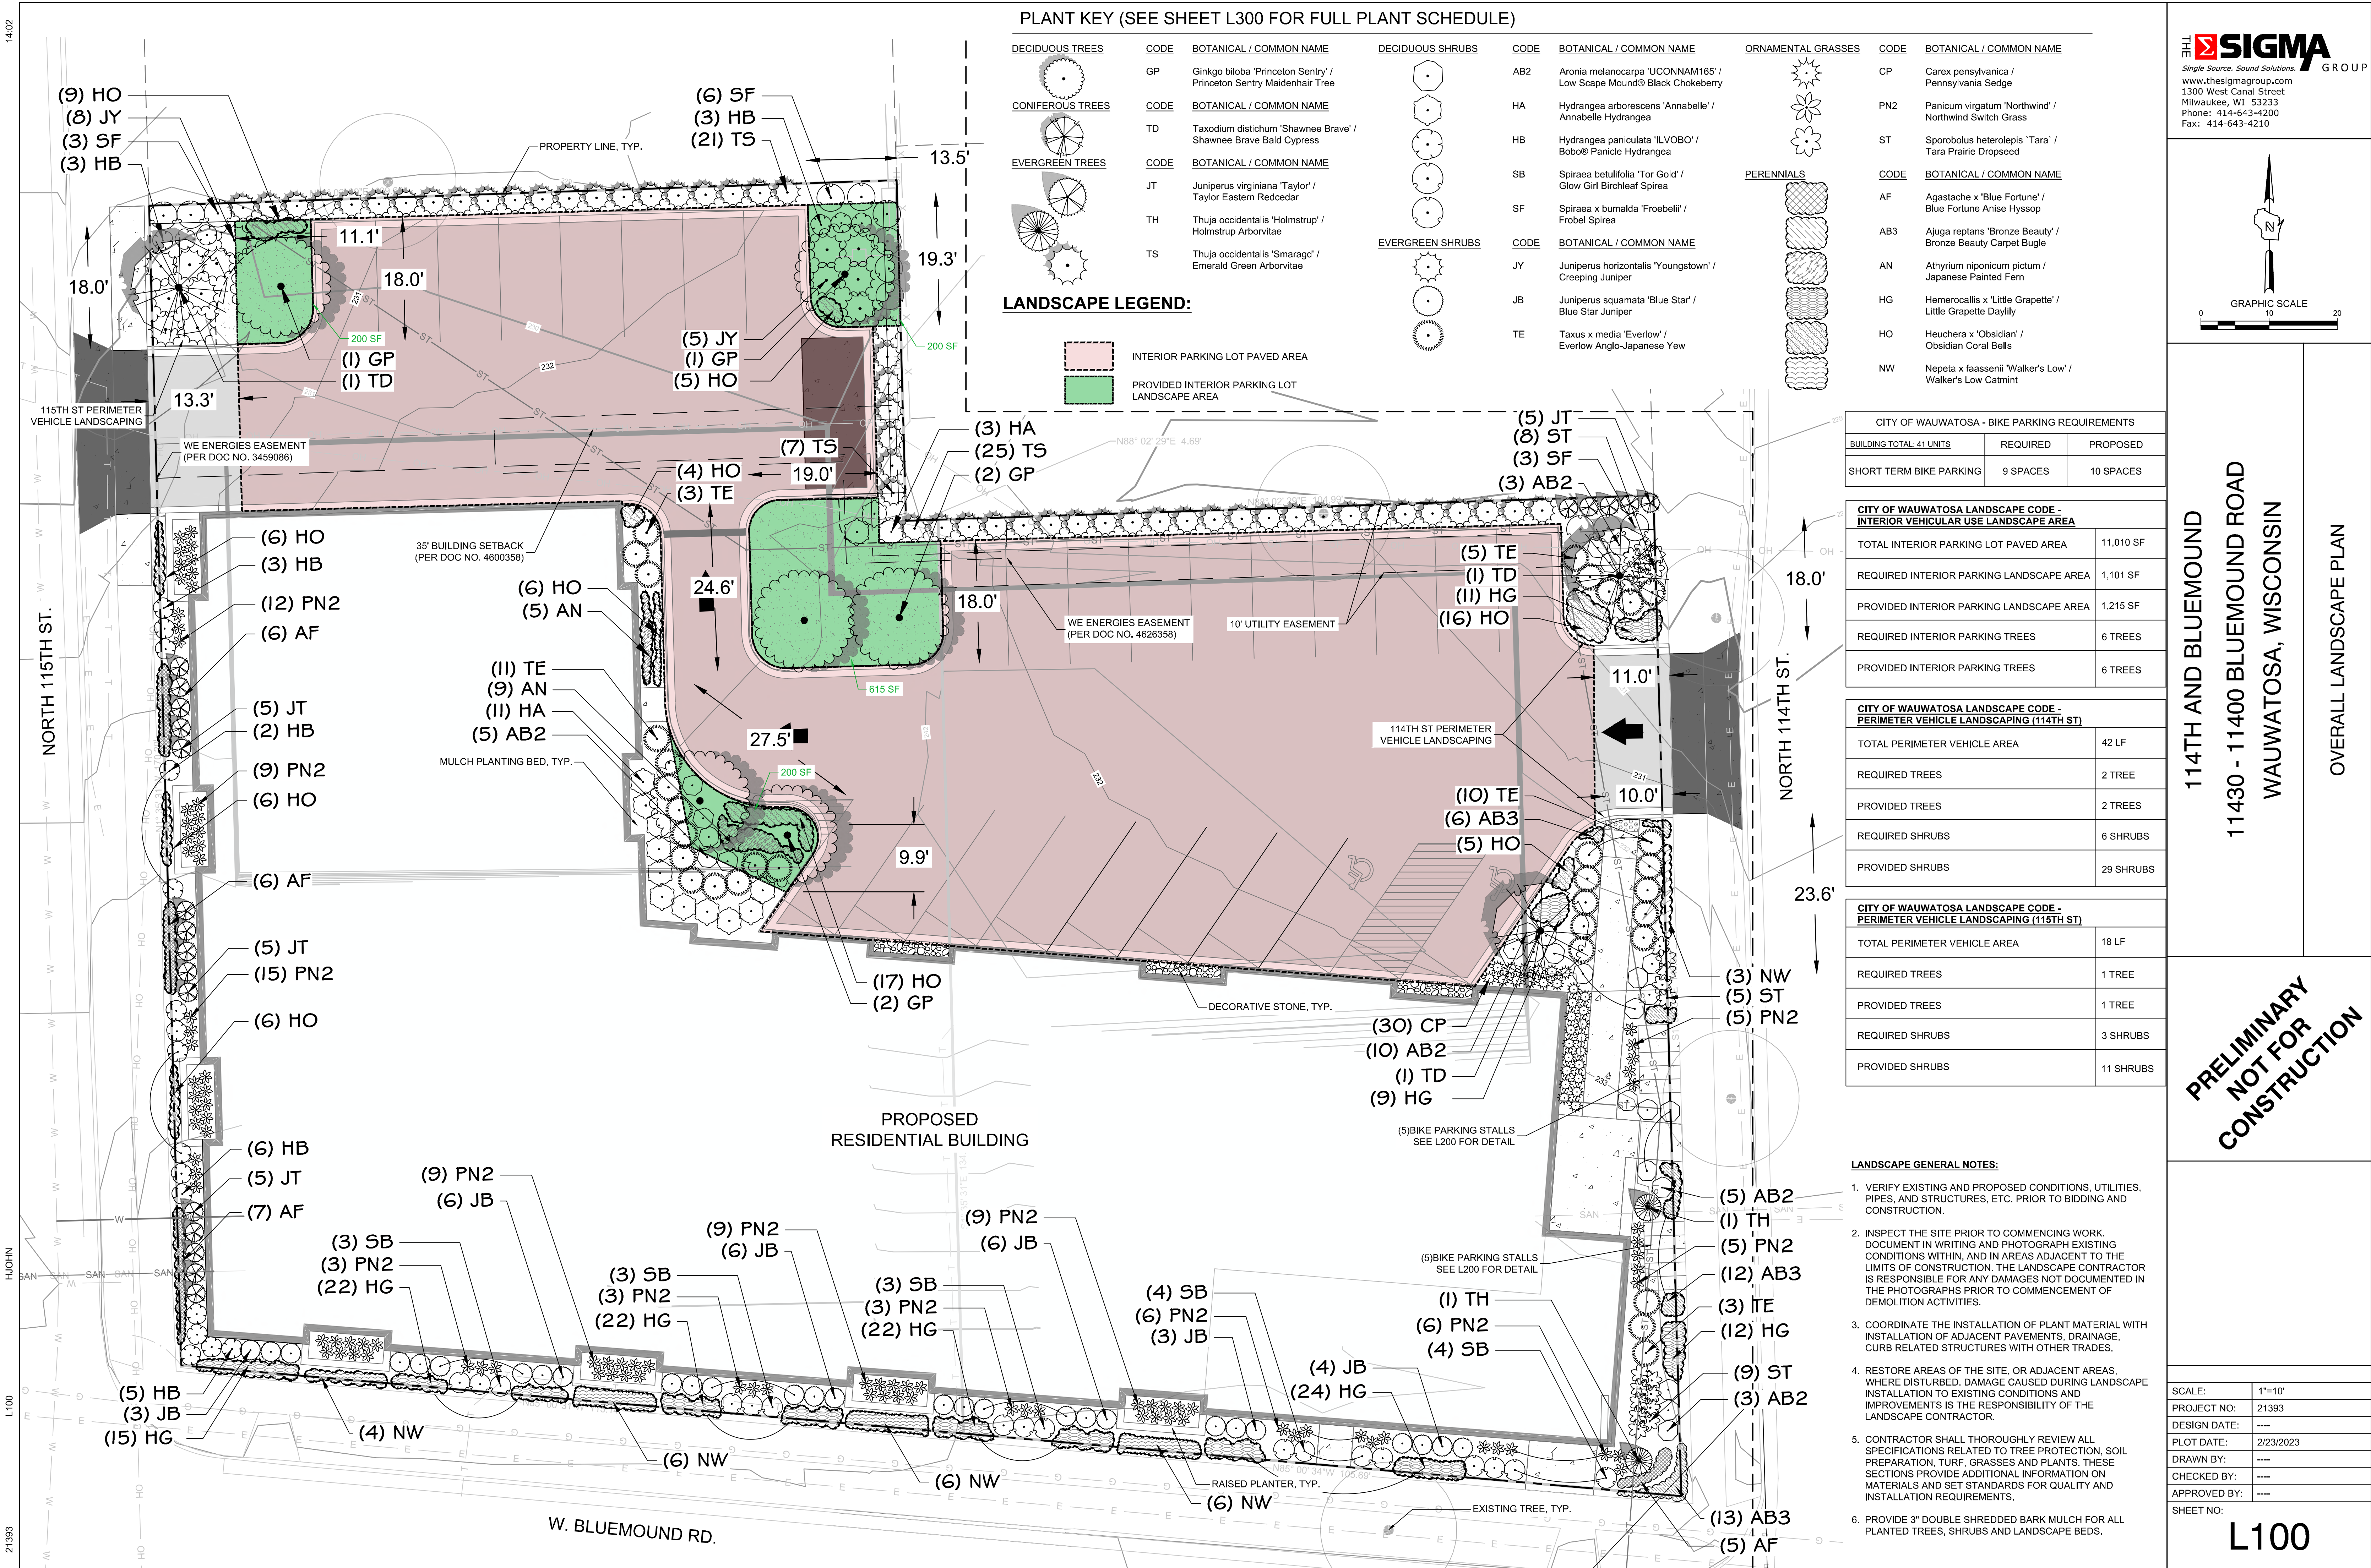


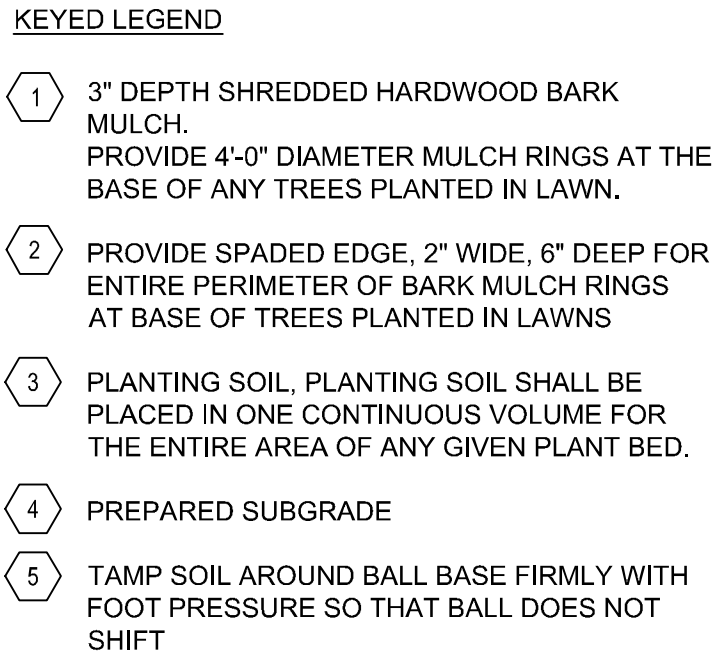

SCALE: 1"= 1'-0"

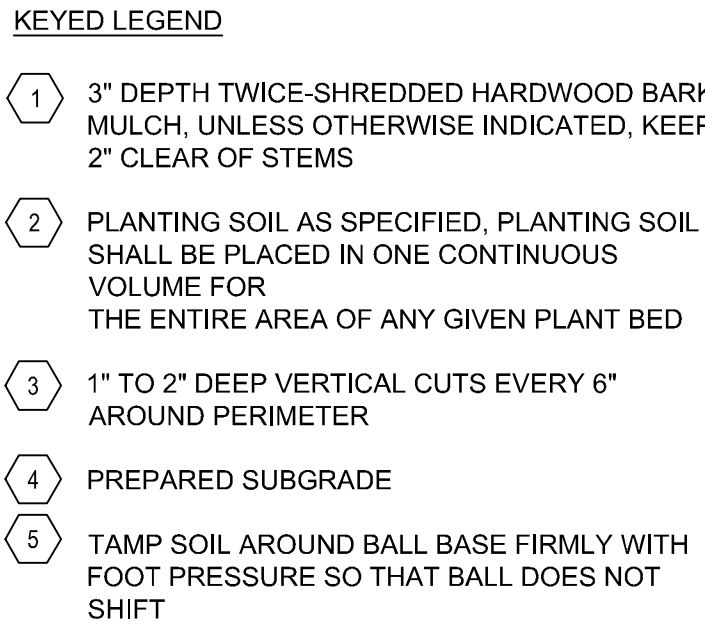



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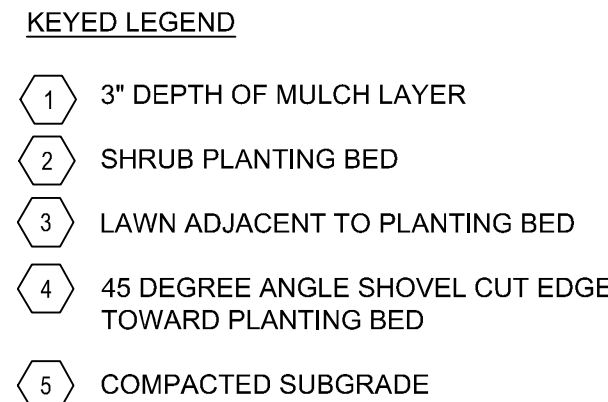
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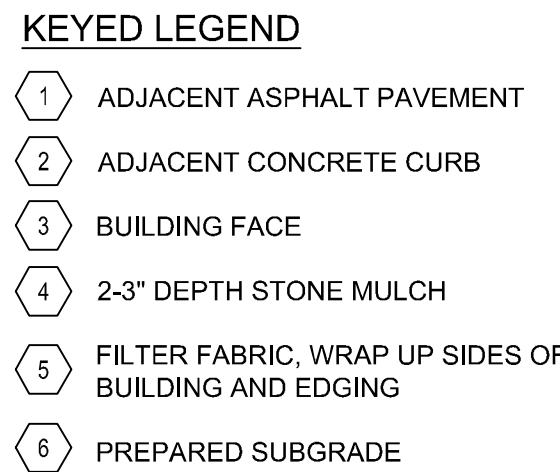
SCALE: 1"= 1'-0'

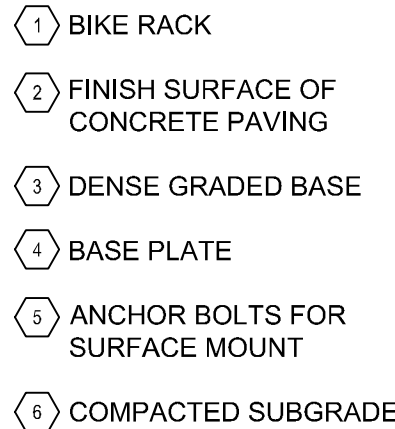

SCALE: 1"= 1'-0'



SCALE: 1"= 1'-0'

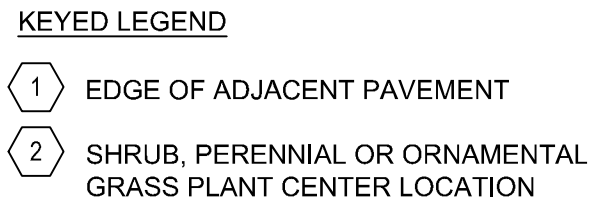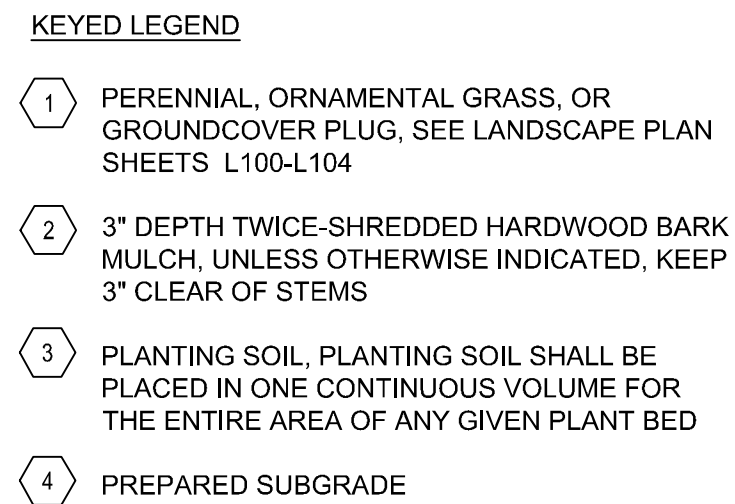

SCALE: 1" = 1'-0"



SCALE:	
PROJECT NO:	21393
DESIGN DATE:	----
PLOT DATE:	2/23/2023
DRAWN BY:	----
CHECKED BY:	----
APPROVED BY:	----
SHEET NO:	

L200

PLANTING QUALITY ASSURANCE

1.

PLANTS ARE TO BE INSPECTED UPON DELIVERY TO PROJECT SITE AND THE LANDSCAPE ARCHITECT OR OWNER'S PROJECT REPRESENTATIVE MAY REJECT ANY SPECIMENS NO LONGER MEETING THE SPECIFIED STANDARDS OR THAT HAVE BEEN DAMAGED IN TRANSIT.
2.

ALL PLANT MATERIAL SHALL BE TRUE TO SPECIES AND VARIETY/HYBRID/CULTIVAR SPECIFIED, AND NURSERY GROWN IN ACCORDANCE WITH GOOD HORTICULTURAL PRACTICES, AND UNDER CLIMATIC CONDITIONS SIMILAR TO THOSE OF THE SITE LOCATION. SPECIMENS NURSERY-DUG TO BE REPLANTED SHALL HAVE BEEN FRESHLY DUG AND PROPERLY PREPARED FOR PLANTING.
3.

TREES:
- 3.1.

SHALL BE TRAINED IN DEVELOPMENT AND APPEARANCE AS TO BE SUPERIOR IN FORM, COMPACTNESS AND SYMMETRY. TREES WITH MULTIPLE LEADERS, UNLESS SPECIFIED OTHERWISE, AND SHRUBS WITH DAMAGED OR CUT MAINSTEM(S), WILL BE REJECTED.
- 3.2.

WITH A DAMAGED, CUT OR CROOKED LEADER, ABRASION OF BARK, SUNSCALD, FROST CRACK, DISFIGURING KNOTS, INSECTS (INCLUDING EGGS AND LARVAE) OR INSECT DAMAGE, CANKERS/CANKEROUS LESIONS OR FUNGAL MATS, MOLD, PREMATURELY-OPENED BUDS, OR CUTS OF LIMBS OVER ¼" DIAMETER THAT ARE NOT COMPLETELY CALLUSED WILL BE REJECTED.
- 3.3.

SHALL HAVE HEALTHY, WELL-DEVELOPED ROOT SYSTEMS, AND BE FREE FROM PHYSICAL DAMAGE OR OTHER HINDERANCES TO HEALTHY GROWTH.
- 3.4.

BALLED AND BURLAPPED PLANTS SHALL BE DUG WITH SOLID BALLS OF A DIAMETER NOT LESS THAN THAT RECOMMENDED BY THE AMERICAN STANDARDS FOR NURSERY STOCK, AND OF SUFFICIENT DEPTH TO INCLUDE BOTH FIBROUS AND FEEDING ROOTS. BALLS SHALL BE SECURELY WRAPPED WITH BURLAP, AND TIGHTLY BOUND WITH ROPE OR TWINE. NO PLANTS SHALL BE BOUND WITH ROPE OR WIRE IN SUCH A MANNER AS TO DAMAGE BARK OR BREAK BRANCHES. THE ROOT FLARE SHOULD BE WITHIN THE TOP 2" OF THE SOIL BALL. BALLED AND BURLAPPED PLANTS WILL NOT BE ACCEPTED IF THE BALL IS DRY, CRACKED, OR BROKEN BEFORE OR DURING PLANTING.
4.

PLANTS SHALL CONFORM TO THE MEASUREMENTS SPECIFIED WITHIN THE PLANT SCHEDULE.
5.

PER THE CITY OF WAUWATOSA CODE 'PERFORMANCE GUARANTEE'
- 5.1.

IMMEDIATELY FOLLOWING INSTALLATION
- 5.1.1.

LANDSCAPE ARCHITECT SHALL PROVIDE AN AFFIDAVIT STATING THAT THE LANDSCAPING IS INSTALLED PER THE APPROVED PLAN.
- 5.2.

ONE-YEAR OR THREE-YEARS FOLLOWING INSTALLATION
- 5.2.1.

LANDSCAPE ARCHITECT SHALL PERFORM FINAL INSPECTION AND PROVIDE AFFIDAVIT THAT THE LANDSCAPING HAS BEEN MAINTAINED AND ESTABLISHED PER APPROVED PLAN.
- 5.2.2.

FISCAL SECURITY WILL BE RELEASED FOLLOWING INSPECTION BY THE CITY LANDSCAPE ARCHITECT.

PLANTING PROJECT CONDITIONS:

1.

VERIFY SERVICE AND UTILITY LOCATIONS, AND DIMENSIONS OF CONSTRUCTION CONTIGUOUS WITH NEW PLANTINGS BY FIELD MEASUREMENTS BEFORE PROCEEDING WITH PLANTING WORK.
2.

INTERRUPTION OF EXISTING SERVICES OR UTILITIES: DO NOT INTERRUPT SERVICES OR UTILITIES UNLESS PERMITTED UNDER VARIOUS CONDITIONS AND THEN ONLY AFTER ARRANGING TO PROVIDE TEMPORARY SERVICES OR UTILITIES ACCORDING TO REQUIREMENTS INDICATED:
- 2.1.

NOTIFY OWNER'S PROJECT REPRESENTATIVE NO FEWER THAN TWO DAYS IN ADVANCE OF PROPOSED INTERRUPTION OF EACH SERVICE OR UTILITY.
- 2.2.

DO NOT PROCEED WITH INTERRUPTION OF SERVICES OR UTILITIES WITHOUT REPRESENTATIVE'S WRITTEN PERMISSION.
3.

PLANTING RESTRICTIONS: PLANTING SHALL OCCUR DURING THE FOLLOWING ACCEPTABLE INSTALLATION PERIODS:
- 3.1.

DECIDUOUS TREES AND SHRUBS - APRIL 1 TO OCTOBER 15.
4.

WEATHER LIMITATIONS: PROCEED WITH PLANTING ONLY WHEN EXISTING AND FORECASTED WEATHER CONDITIONS PERMIT PLANTING TO BE PERFORMED WHEN BENEFICIAL AND OPTIMUM RESULTS MAY BE OBTAINED. APPLY PRODUCTS DURING FAVORABLE WEATHER CONDITIONS ACCORDING TO MANUFACTURER'S WRITTEN INSTRUCTIONS AND WARRANTY REQUIREMENTS.
5.

CONTRACTOR SHALL PROTECT ALL EXISTING AND/OR NEWLY INSTALLED PLANTS, LAWNS, AND GRASS AREAS FROM DAMAGE AT ALL TIMES. DAMAGED PLANTS, LAWNS OR GRASS AREAS SHALL BE REPLACED OR TREATED AS REQUIRED TO CONFORM TO SPECIFICATIONS HEREIN FOR FRESH STOCK. WORK AREA SHALL BE KEPT CLEAN AND ORDERLY DURING THE INSTALLATION PERIOD. UNDER NO CONDITION SHALL DEBRIS FROM PLANTING ACTIVITIES RESULT IN A SAFETY HAZARD ON-SITE OR ADJACENT OFF-SITE PROPERTY. DAMAGE TO SITE IMPROVEMENTS OR ADJACENT LANDSCAPES INCURRED AS A RESULT OF PLANTING OR REPLACEMENT OPERATIONS SHALL BE REPAIRED BY THE CONTRACTOR THAT CAUSES THE DAMAGE AT NO COST TO THE OWNER.
6.

EXAMINE AREAS TO RECEIVE PLANTS FOR COMPLIANCE WITH REQUIREMENTS AND CONDITIONS AFFECTING INSTALLATION AND PERFORMANCE. PROCEED WITH INSTALLATION ONLY AFTER UNSATISFACTORY CONDITIONS HAVE BEEN CORRECTED.
- 6.1.

VERIFY THAT NO FOREIGN OR DELETERIOUS MATERIAL OR LIQUID SUCH AS PAINT, PAINT WASHOUT, CONCRETE SLURRY, CONCRETE LAYERS OR CHUNKS, CEMENT, PLASTER, OILS, GASOLINE, DIESEL FUEL, PAINT THINNER, TURPENTINE, TAR, ROOFING COMPOUND, OR ACID HAS BEEN DEPOSITED IN SOIL WITHIN PLANTING AREAS.
- 6.2.

DO NOT MIX OR PLACE SOILS IN FROZEN, WET, OR MUDDY CONDITIONS.

PLANTING DELIVERY, STORAGE, & HANDLING:

1.

BULK MATERIALS:
- 1.1.

DO NOT DUMP OR STORE BULK MATERIALS NEAR STRUCTURES, UTILITIES, WALKWAYS AND PAVEMENTS, OR ON EXISTING TURF AREAS OR PLANTS.
2.

DO NOT PRUNE TREES AND SHRUBS BEFORE DELIVERY. PROTECT BARK, BRANCHES, AND ROOT SYSTEMS FROM SUN SCALD, DRYING, WIND BURN, SWEATING, WHIPPING, AND OTHER HANDLING AND TYING DAMAGE. DO NOT BEND OR BIND TREES OR SHRUBS IN SUCH A MANNER AS TO DESTROY THEIR NATURAL SHAPE. PROVIDE PROTECTIVE COVERING OF PLANTS DURING SHIPPING AND DELIVERY. DO NOT DROP PLANTS DURING DELIVERY AND HANDLING.
3.

HANDLE PLANTING STOCK BY ROOT BALL.
4.

DELIVER PLANTS AFTER PREPARATIONS FOR PLANTING HAVE BEEN COMPLETED AND INSTALL IMMEDIATELY. IF PLANTING IS DELAYED MORE THAN SIX HOURS AFTER DELIVERY, SET PLANTS AND TREES IN SHADED LOCATION, PROTECT FROM WEATHER AND MECHANICAL DAMAGE, AND KEEP ROOTS MOIST.
- 4.1.

SET BALLED STOCK ON GROUND AND COVER BALL WITH SOIL, PEAT MOSS, SAWDUST, OR OTHER ACCEPTABLE MATERIAL.
- 4.2.

WATER ROOT SYSTEMS OF PLANTS STORED ON-SITE DEEPLY AND THOROUGHLY WITH A FINE-MIST SPRAY. WATER AS OFTEN AS NECESSARY TO MAINTAIN ROOT SYSTEMS IN A MOIST, BUT NOT OVERLY WET CONDITION.

EXCAVATION FOR TREES & SHRUBS

1.

EXCAVATE CIRCULAR PLANTING PITS AS INDICATED IN DRAWINGS, TRIM PERIMETER OF BOTTOM LEAVING CENTER AREA OF BOTTOM RAISED SLIGHTLY TO SUPPORT ROOT BALL AND ASSIST IN DRAINAGE AWAY FROM CENTER, DO NOT FURTHER DISTURB BASE. ENSURE THAT ROOT BALL WILL SIT ON UNDISTURBED BASE SOIL TO PREVENT SETTLING. SCARPED SIDES OF PLANTING PIT SMOOTHED DURING EXCAVATION.
- 1.1.

EXCAVATE APPROXIMATELY THREE TIMES AS WIDE AS BALL DIAMETER FOR BALLED AND BURLAPPED STOCK.
- 1.2.

DO NOT EXCAVATE DEEPER THAN DEPTH OF THE ROOT BALL, MEASURED FROM THE ROOT FLARE TO THE BOTTOM OF THE ROOT BALL.
- 1.3.

IF AREA UNDER THE PLANT WAS INITIALLY DUG TOO DEEP, ADD SOIL TO RAISE IT TO CORRECT LEVEL AND THOROUGHLY TAMP THE ADDED SOIL TO PREVENT SETTLING.
- 1.4.

MAINTAIN REQUIRED ANGLES OF REPOSE OF ADJACENT MATERIALS AS SHOWN IN DRAWINGS. DO NOT EXCAVATE SUBGRADES OF ADJACENT PAVING, STRUCTURES, HARDSCAPES, OR OTHER NEW OR EXISTING IMPROVEMENTS.
- 1.5.

MAINTAIN SUPERVISION OF EXCAVATIONS DURING WORKING HOURS.
- 1.6.

KEEP EXCAVATIONS COVERED OR OTHERWISE PROTECTED WHEN UNATTENDED BY INSTALLER'S PERSONNEL.
2.

SUBSOIL AND TOPSOIL REMOVED FROM EXCAVATIONS MAY BE USED AS PLANTING SOIL IF IT IS USED AS PART OF THE ENVIRONMENTAL CAP MATERIAL PLACED AS PART OF CIVIL SITE CONSTRUCTION (SEE DETAIL D ON C402). ANY SUBSOIL OR TOPSOIL REMOVED FROM EXCAVATIONS WHICH IS NOT A PART OF THE ENVIRONMENTAL CAP, SHALL BE HANDLED IN ACCORDANCE WITH THE SITE SOIL MANAGEMENT PLAN.
3.

NOTIFY OWNER'S PROJECT REPRESENTATIVE IF UNEXPECTED ROCK OR OBSTRUCTIONS DETRIMENTAL TO TREES OR SHRUBS ARE ENCOUNTERED IN EXCAVATIONS.
4.

NOTIFY OWNER'S PROJECT REPRESENTATIVE IF SUBSOIL CONDITIONS EVIDENCE UNEXPECTED WATER SEEPAGE OR RETENTION IN TREE OR SHRUB PLANTING PITS.

TREE & SHRUB PLANTING

1.

BEFORE PLANTING VERIFY THAT ROOT FLARE IS VISIBLE AT TOP OF ROOT BALL. IF ROOT FLARE IS NOT VISIBLE, REMOVE SOIL IN A LEVEL MANNER FROM THE ROOT BALL TO WHERE THE TOP-MOST ROOT EMERGES FROM THE TRUNK. AFTER SOIL REMOVAL TO EXPOSE ROOT FLARE, VERIFY THAT ROOT BALL STILL MEETS SIZE REQUIREMENTS. PLANT MATERIAL WITHOUT ROOT FLARE VISIBLE OR PLANTED TOO LOW WILL BE RE-PLANTED AT THE REQUEST OF THE LANDSCAPE ARCHITECT AT NO ADDITIONAL COST TO THE OWNER.
2.

PLANTS FOUND TO HAVE STEM GIRDLING ROOTS AND/OR KINKED ROOTS AT THE TIME OF PLANTING WILL BE REJECTED AND REPLACEMENTS SHALL BE PROVIDED AT NO ADDITIONAL COST TO THE OWNER.
3.

REMOVE ALL TWINE, STRING, WIRE, AND ALL OTHER NON-BIODEGRADABLE MATERIAL ENTIRELY FROM ROOT BALL AREA.
4.

REMOVE ONLY DEAD, DYING, OR BROKEN BRANCHES. DO NOT PRUNE FOR SHAPE. DO CUT TREE LEADERS.
5.

SET BALLED AND BURLAPPED STOCK PLUMB AND IN CENTER OF PLANTING PIT OR TRENCH WITH ROOT FLARE 2 INCHES ABOVE ADJACENT FINISH GRADES.
- 5.1.

USE SOIL MATERIALS FROM EXCAVATION FOR BACKFILL.
- 5.2.

CAREFULLY CUT AND REMOVE BURLAP, ROPE, AND WIRE BASKETS FROM THE ENTIRE ROOT BALL. REMOVE PALLETES, IF ANY, BEFORE SETTING. DO NOT USE PLANTING STOCK IF ROOT BALL IS CRACKED OR BROKEN BEFORE OR DURING PLANTING OPERATION.
- 5.3.

BACKFILL AROUND ROOT BALL IN LAYERS, TAMPING TO SETTLE SOIL AND ELIMINATE VOIDS AND AIR POCKETS. WHEN PLANTING PIT IS APPROXIMATELY ONE-HALF FILLED, WATER THOROUGHLY BEFORE PLACING REMAINDER OF BACKFILL. REPEAT WATERING UNTIL NO MORE WATER IS ABSORBED.
- 5.4.

CONTINUE BACKFILLING PROCESS. WATER AGAIN AFTER PLACING AND TAMPING FINAL LAYER OF SOIL.

TREE & SHRUB MATERIAL:

1.

GENERAL: FURNISH NURSERY-GROWN PLANTS TRUE TO GENUS, SPECIES, VARIETY, CULTIVAR, STEM FORM, SHEARING, AND OTHER FEATURES INDICATED IN PLANT SCHEDULE, SHOWN AND DRAWINGS; AND WITH HEALTHY ROOT SYSTEMS DEVELOPED BY TRANSPLANTING OR ROOT PRUNING. PROVIDE WELL-SHAPED, FULLY BRANCHED, HEALTHY, VIGOROUS STOCK, DENSELY FOLIATED WHEN IN LEAF AND FREE OF DISEASE, PESTS, EGGS, LARVAE, AND DEFECTS SUCH AS KNOTS, SUN SCALD, INJURIES, ABRASIONS, AND DISFIGUREMENT.
- 1.1.

TREES WITH DAMAGED, CROOKED, OR MULTIPLE LEADERS: TIGHT VERTICAL BRANCHES WHERE BARK IS SQUEEZED BETWEEN TWO BRANCHES OR BETWEEN BRANCH AND TRUNK ("INCLUDED BARK"); CROSSING TRUNKS; CUT-OFF LIMBS MORE THAN ¾" IN DIAMETER; OR WITH STEM GIRDLING ROOTS WILL BE REJECTED.
- 1.2.

COLLECTED STOCK: DO NOT USE PLANTS HARVESTED FROM THE WILD, FROM NATIVE STANDS, FROM AN ESTABLISHED LANDSCAPE PLANTING, OR NOT GROWN IN A STATE CERTIFIED NURSERY.
- 1.3.

PLANT MATERIAL SHALL BE PROVIDED IN THE CONTAINER TYPE INDICATED IN THE DRAWINGS (B&B, CONTAINER, BARE ROOT, ETC.), UNLESS THE CONTRACTOR RECEIVES WRITTEN APPROVAL FROM THE LANDSCAPE ARCHITECT THAT SUBSTITUTION OF CONTAINER TYPE IS ACCEPTABLE.
2.

FURNISH TREES WITH ROOT BALLS MEASURED FROM TOP OF ROOT BALL. ROOT FLARE SHALL BE VISIBLE BEFORE PLANTING.
3.

SELECT STOCK FOR UNIFORM HEIGHT AND SPREAD.

PLANTING SOIL:

- SOIL

1.

PLANTING SOIL SHALL BE PLACED IN ONE CONTINUOUS VOLUME FOR THE ENTIRE WIDTH OF LANDSCAPE AREAS.
2.

CONTRACTOR SHALL PROVIDE HIGH-QUALITY TOPSOIL FOR ALL NEW TURFGRASS LAWN AND PLANTING BED AREAS IN THE FOLLOWING DEPTHS:
- 2.1.

FOR SEEDED LAWNS: 4-INCHES MINIMUM; 8-INCHES IN AREAS WHERE HIGH BEDROCK IS PRESENT
- 2.2.

FOR PLANTING BEDS: 4-INCHES MINIMUM
- 2.3.

FOR TREE PITS AND/OR TREES PLANTED IN PLANTING BEDS: 24-INCHES OR THE DEPTH OF THE ROOTBALL, WHICHEVER IS GREATER.
- 2.4.

NO TOPSOIL IS REQUIRED UNDER ANY AREAS THAT ARE EXCLUSIVELY STONE COBBLES/STONE MATERIALS.
- 2.5.

TOPSOIL SHALL BE LOAM TO SANDY LOAM AND FREE OF ROCKS, GRAVEL, WOOD, DEBRIS, LITTER, AND OF NOXIOUS WEEDS AND THEIR SEEDS. IT SHALL BE CLEANED, SALVAGED OR IMPORTED MATERIAL CAPABLE OF PASSING THE 1" SIEVE.
3.

DO NOT APPLY PLANTING SOIL TO SATURATED OR FROZEN SUBGRADES.

4.

PLANTING SOIL SHALL BE A MIX OF 6-PARTS TOPSOIL, 1-PART COMPOST (APPROVED FOR USE ON THE PROJECT), THOROUGHLY BLEND PLANTING SOIL OFF-SITE BEFORE SPREADING.
- 4.1.

THE PROJECT WILL ACCEPT ONLY CLEAN, SALVAGED OR IMPORTED TOPSOIL CAPABLE OF PASSING THE 1" SIEVE, FREE OF ROCKS, DEBRIS, AND OF NOXIOUS WEEDS.
- 4.2.

STRIPPED, SALVAGED, OR MINED TOPSOIL MUST BE TAKEN FROM THE TOP 6-INCHES OF THE A-HORIZON, HAVING A DARK BROWN TO BLACK COLOR WITH A GRANULAR STRUCTURE AND CLAY CONTENT OF LESS THAN 25%, VERIFIED WITH A RIBBON TEST THAT YIELDS NO MORE THAN 1-INCH.
5.

ALL TOPSOIL SHALL BE VERIFIED BY FIELD REVIEW AT THE LOCATION OF THE TOPSOIL STOCKPILE PRIOR TO DELIVERY OR SPREADING ON THE SITE. FIELD REVIEW MAY CONSIST OF VISUAL INSPECTION, HAND TEST FOR CLAY, ETC., EACH DIFFERENT SOIL SOURCE (STOCKPILED FROM EXISTING SITE, IMPORTED, STOCKPILED OFF-SITE, ETC.) IS SUBJECT TO A SEPARATE INSPECTION AND APPROVAL.
6.

REFER TO CIVIL PLANS FOR SUBTERRANEAN BIORETENTION SOIL, MATERIALS AND CONSTRUCTION.
7.

FINISH GRADE TOPSOIL SURFACES TO THE FOLLOWING TOLERANCES: WHERE TOPSOILED AREA(S) MEETS ADJACENT PAVEMENTS:
- 7.1.

FOR SEEDED LAWNS: HOLD TOPSOIL 1/2-INCH BELOW TOP SURFACE OF ADJACENT PAVEMENT.
- 7.2.

FOR PLANTING BEDS: HOLD TOPSOIL 2-INCHES BELOW TOP SURFACE OF ADJACENT PAVEMENT AND TAPER BARK MULCH DOWN SO THAT TOP SURFACE OF BARK MULCH IS HELD EVEN OR SLIGHTLY BELOW TOP SURFACE OF ADJACENT PAVEMENT.

BARK MULCH MATERIAL & INSTALLATION

1.

TWICE-SHREDDED HARDWOOD BARK MULCH TO BE PROVIDED AS TOP-DRESSING FOR AT-GRADE PLANTING BEDS IN LOCATIONS INDICATED ON DETAILED PLANTING PLANS.
- 1.1.

SIZE RANGE: MAXIMUM 2.5" TO 3"
- 1.2.

COLOR: NATURAL, UN-DYED
- 1.3.

PROVIDE 3" DEPTH MULCH FOR ALL PLANTING BEDS INDICATED AS BARK MULCH PLANTING BED.
2.

KEEP BARK MULCH 2" CLEAR OF ALL STEMS OF PLANT MATERIAL.

CLEAN-UP AND PROTECTION

1.

DURING PLANTING, KEEP ADJACENT PAVING AND CONSTRUCTION CLEAN AND WORK AREA IN AN ORDERLY CONDITION.
2.

PROTECT PLANTS FROM DAMAGE DUE TO LANDSCAPE OPERATIONS AND OPERATIONS OF OTHER CONTRACTORS AND TRADES. MAINTAIN PROTECTION DURING INSTALLATION. TREAT, REPAIR, OR REPLACE DAMAGED PLANTINGS.
3.

AFTER INSTALLATION REMOVE ALL NURSERY TAGS, NURSERY STAKES, TIE TAPE, LABELS, WIRE, STRING, AND OTHER DEBRIS FROM PLANT MATERIAL, PLANTING AREAS, AND PROJECT SITE.

STONE MULCH EDGE MATERIAL & INSTALLATION:

1.

SHALL BE HARD, DURABLE, STONE, WASHED FREE OF LOAM, SAND, CLAY, AND OTHER FOREIGN SUBSTANCES, OF THE FOLLOWING TYPE, SIZE RANGE, AND COLOR:
- 1.1.1.

TYPE: STONE MULCH EDGE
- 1.1.2.

MATERIAL: ROUNDED WASHED STONE
- 1.1.3.

SIZE: 1-1/2"
- 1.1.4.

DEPTH: 3" MINIMUM IN (2) LIFTS
- 1.1.5.

COLOR RANGE: BLEND OF TAN, GREY & RED TONES
- 1.1.6.

BASIS OF DESIGN: 1-1/2" 'AMERICAN HERITAGE' AGGREGATE BY COUNTY MATERIALS
2.

COMPACT AREAS TO RECEIVE STONE MULCH IN (2) LIFTS MINIMUM
3.

INSTALL WEED BARRIER FABRIC IN ACCORDANCE WITH MANUFACTURER'S WRITTEN INSTRUCTIONS; COMPLETELY COVER AREA TO BE MULCHED, OVERLAPPING EDGES OF FABRIC LENGTHS A MINIMUM OF 6-INCHES AND SECURING SEAMS WITH GALVANIZED PINS. WEED BARRIER FABRIC SHALL BE WRAPPED VERTICALLY UP THE OUTSIDE EDGES OF SURROUNDING CONCRETE FLATWORK OR CURB AND SECURED IN PLACE. HOLD FABRIC 2" CLEAR OF TOP OF ADJACENT CURB AND CONCRETE FLATWORK SO IT IS NOT VISIBLE FROM SURFACE.
4.

PLACE AND FINISH STONE MULCH AS INDICATED IN DRAWINGS, ENSURING A SMOOTH, LEVEL TOP SURFACE FOR ALL STONE MULCH AREAS HELD APPROXIMATELY 1/2" BELOW THE TOP SURFACE OF ADJACENT PAVED AREAS OR ALUMINUM EDGING.

TURF SEEDING:

1.

DELIVERY:
- 1.1.

DELIVER PACKAGED SEED MATERIALS IN ORIGINAL, UNOPENED CONTAINERS LABELED AS TO NAME AND ADDRESS OF SUPPLIER; SPECIFIC BLEND OF SEED; AND INDICATION OF CONFORMANCE WITH STATE AND FEDERAL LAWS, AS APPLICABLE.
2.

PROJECT CONDITIONS:
- 2.1.

SEED DURING ONE OF THE FOLLOWING PERIODS:
- 2.1.1.

SPRING SEEDING SEASON: APRIL 1 TO JUNE 15.
- 2.1.2.

FALL SEEDING SEASON: AUGUST 15 TO OCTOBER 1.
3.

PRODUCTS
- 3.0.1.

PROVIDE THE FOLLOWING FOR TURFGRASS SEED BASIS OF DESIGN: REINDEERS DELUXE 50 SEED MIX OR APPROVED EQUAL
- 3.0.2.

TURFGRASS SEED MIX TO BE FERTILIZED WITH 'SCOTT'S STARTER FERTILIZER' BY THE 'SCOTTS MIRACLE-CRO COMPANY' OR APPROVED EQUAL
4.

PROCEED WITH INSTALLATION ONLY AFTER UNSATISFACTORY CONDITIONS HAVE BEEN MET.
5.

REMOVE ANY AND ALL UNDESIRABLE VEGETATION THAT HAS GERMINATED IN THE AREAS TO BE SEEDED OR SODDED. CONTRACTOR SHALL EVALUATE THE USE OF A BROAD SPECTRUM, NON-PERSISTENT GLYPHOSPHATE-BASED HERBICIDE BASED ON SITE CONDITIONS.
- 5.1.




DO NOT APPLY SEED UNTIL FIVE TO SEVEN DAYS AFTER LAST HERBICIDE TREATMENT.
6.

FINISH GRADING: GRADE AREAS TO A SMOOTH, UNIFORM SURFACE PLANE WITH LOOSE, UNIFORMLY FINE TEXTURE. GRADE TO WITHIN PLUS OR MINUS ½ INCH OF FINISH ELEVATION. ROLL AND RAKE, REMOVE RIDGES, AND FILL DEPRESSIONS TO MEET FINISH GRADES. LIMIT FINISH GRADING TO AREAS THAT CAN BE IMMEDIATELY SEEDED AND STABILIZED WITH EROSION CONTROL MATERIAL
7.


MOISTEN PREPARED AREA BEFORE SEEDING IF SOIL IS DRY. WATER THOROUGHLY AND ALLOW SURFACE DRY BEFORE SEEDING OR SODDING. DO NOT CREATE MUDDY SOIL
8.

NO SEEDING SHALL OCCUR ON FROZEN GROUND OR AT TEMPERATURES LOWER THAN 32 DEGREES FAHRENHEIT OR IN THE FOLLOWING 5 DAYS AFTER PLANNED SEEDING OR SODDING.
9.

SEEDING RATES TO BE PERFORMED IN ACCORDANCE WITH SEED SUPPLIER RECOMMENDATIONS.

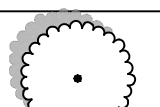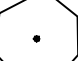PLANT SCHEDULE					
DECIDUOUS TREES	CODE	BOTANICAL / COMMON NAME	SIZE	CONTAINER	QTY
	GP	Ginkgo biloba 'Princeton Sentry' / Princeton Sentry Maidenhair Tree	4" Cal.	B&B	6
CONIFEROUS TREES	CODE	BOTANICAL / COMMON NAME	SIZE	CONTAINER	QTY
	TD	Taxodium distichum 'Shawnee Brave' / Shawnee Brave Bald Cypress	2" Cal.	B&B	3
EVERGREEN TREES	CODE	BOTANICAL / COMMON NAME	SIZE	CONTAINER	QTY
	JT	Juniperus virginiana 'Taylor' / Taylor Eastern Redcedar	#15	Cont.	20
	TH	Thuja occidentalis 'Holmstrup' / Holmstrup Arborvitae	#7	Cont.	2
	TS	Thuja occidentalis 'Smaragd' / Emerald Green Arborvitae	5' Ht.	B&B	52
DECIDUOUS SHRUBS	CODE	BOTANICAL / COMMON NAME	SIZE	CONTAINER	QTY
	AB2	Aronia melanocarpa 'UCONNAM165' / Low Scape Mound® Black Chokeberry	2 gal.	Cont.	26
	HA	Hydrangea arborescens 'Annabelle' / Annabelle Hydrangea	2 gal.	Cont.	14
	HB	Hydrangea paniculata 'ILVOBO' / Bobo® Panicle Hydrangea	2 gal.	Cont.	22
	SB	Spiraea betulifolia 'Tor Gold' / Glow Girl Birchleaf Spirea	2 gal.	Cont.	17
	SF	Spiraea x bumalda 'Froebeli' / Frobel Spirea	2 gal.	Cont.	12
EVERGREEN SHRUBS	CODE	BOTANICAL / COMMON NAME	SIZE	CONTAINER	QTY
	JY	Juniperus horizontalis 'Youngstown' / Creeping Juniper	5 gal.	Cont.	13
	JB	Juniperus squamata 'Blue Star' / Blue Star Juniper	5 gal.	Cont.	28
	TE	Taxus x media 'Evertow' / Evertow Anglo-Japanese Yew	5 gal.	Cont.	32
ORNAMENTAL GRASSES	CODE	BOTANICAL / COMMON NAME	SIZE	CONTAINER	QTY
	CP	Carex pensylvanica / Pennsylvania Sedge	1 gal.	Cont.	30
	PN2	Panicum virgatum 'Northwind' / Northwind Switch Grass	1 gal.	Cont.	103
	ST	Sporobolus heterolepis 'Tara' / Tara Prairie Dropseed	1 gal.	Cont.	22
SHRUB AREAS	CODE	BOTANICAL / COMMON NAME	SIZE	CONTAINER	QTY
	AF	Agastache x 'Blue Fortune' / Blue Fortune Anise Hyssop	4.5"	Pot	24
	AB3	Ajuga reptans 'Bronze Beauty' / Bronze Beauty Carpet Bugle	4.5"	Pot	36
	AN	Athyrium niponicum pictum / Japanese Painted Fern	4.5"	Pot	14
	HG	Hemerocallis x 'Little Grapette' / Little Grapette Daylily	4.5"	Pot	129
	HO	Heuchera x 'Obsidian' / Obsidian Coral Bells	4.5"	Pot	80
	NW	Nepeta x faassenii 'Walker's Low' / Walker's Low Catmint	4.5"	Pot	25
GROUND COVERS	CODE	BOTANICAL / COMMON NAME	SIZE	CONTAINER	QTY
	TH3	Turf Seed / Drought Tolerant Fescue Blend			

THE



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Phone: 414-643-4200

Fax: 414-643-4210

114TH AND BLUEMOUND

11430 - 11400 BLUEMOUND ROAD

WAUWATOSA, WISCONSIN

LANDSCAPE SPECIFICATIONS

PRELIMINARY

NOT FOR

CONSTRUCTION

SCALE:

PROJECT NO: 21393

DESIGN DATE: ---

PLOT DATE: 2/23/2023

DRAWN BY: ---


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APPROVED BY: ---

SHEET NO:

L300

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**Haydin
Thacker
Architecture**

131 W SEEBOTH ST. SUITE 230
MILWAUKEE, WI 53204
1/414-526-7359
HAYDINTHACKER.COM

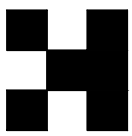

PROJECT NAME
BLUEMOUND ROAD
MULTI-FAMILY DEVELOPMENT
WAUWATOSA, WISCONSIN

DRAWING REVISION HISTORY

SHEET TITLE
CONCEPTUAL ARCHITECTURAL DRAWINGS



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22008
DRAWING DATE
02-01-2023
SET AND SUBMITTAL TYPE
WAUWATOSA PUD SUBMITTAL

SHEET NUMBER



A200

UNIT MATRIX						
UNIT TYPE	UNITS PER FLOOR					TOTALS
	1ST	2ND	3RD	4TH		
ONE BEDROOM	-	5	5	5		15
ONE BEDROOM + DEN	-	2	2	2		6
TWO BEDROOM	-	5	6	6		17
THREE BEDROOM	-	1	1	1		3
TOTAL		13	14	14		41



BUILDING AREAS	
FLOOR	AREA (GSF)
GROUND FLOOR	16,916
SECOND FLOOR	16,340
THIRD FLOOR	16,340
FOURTH FLOOR	16,340
TOTAL	65,936

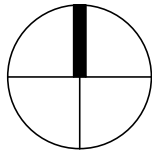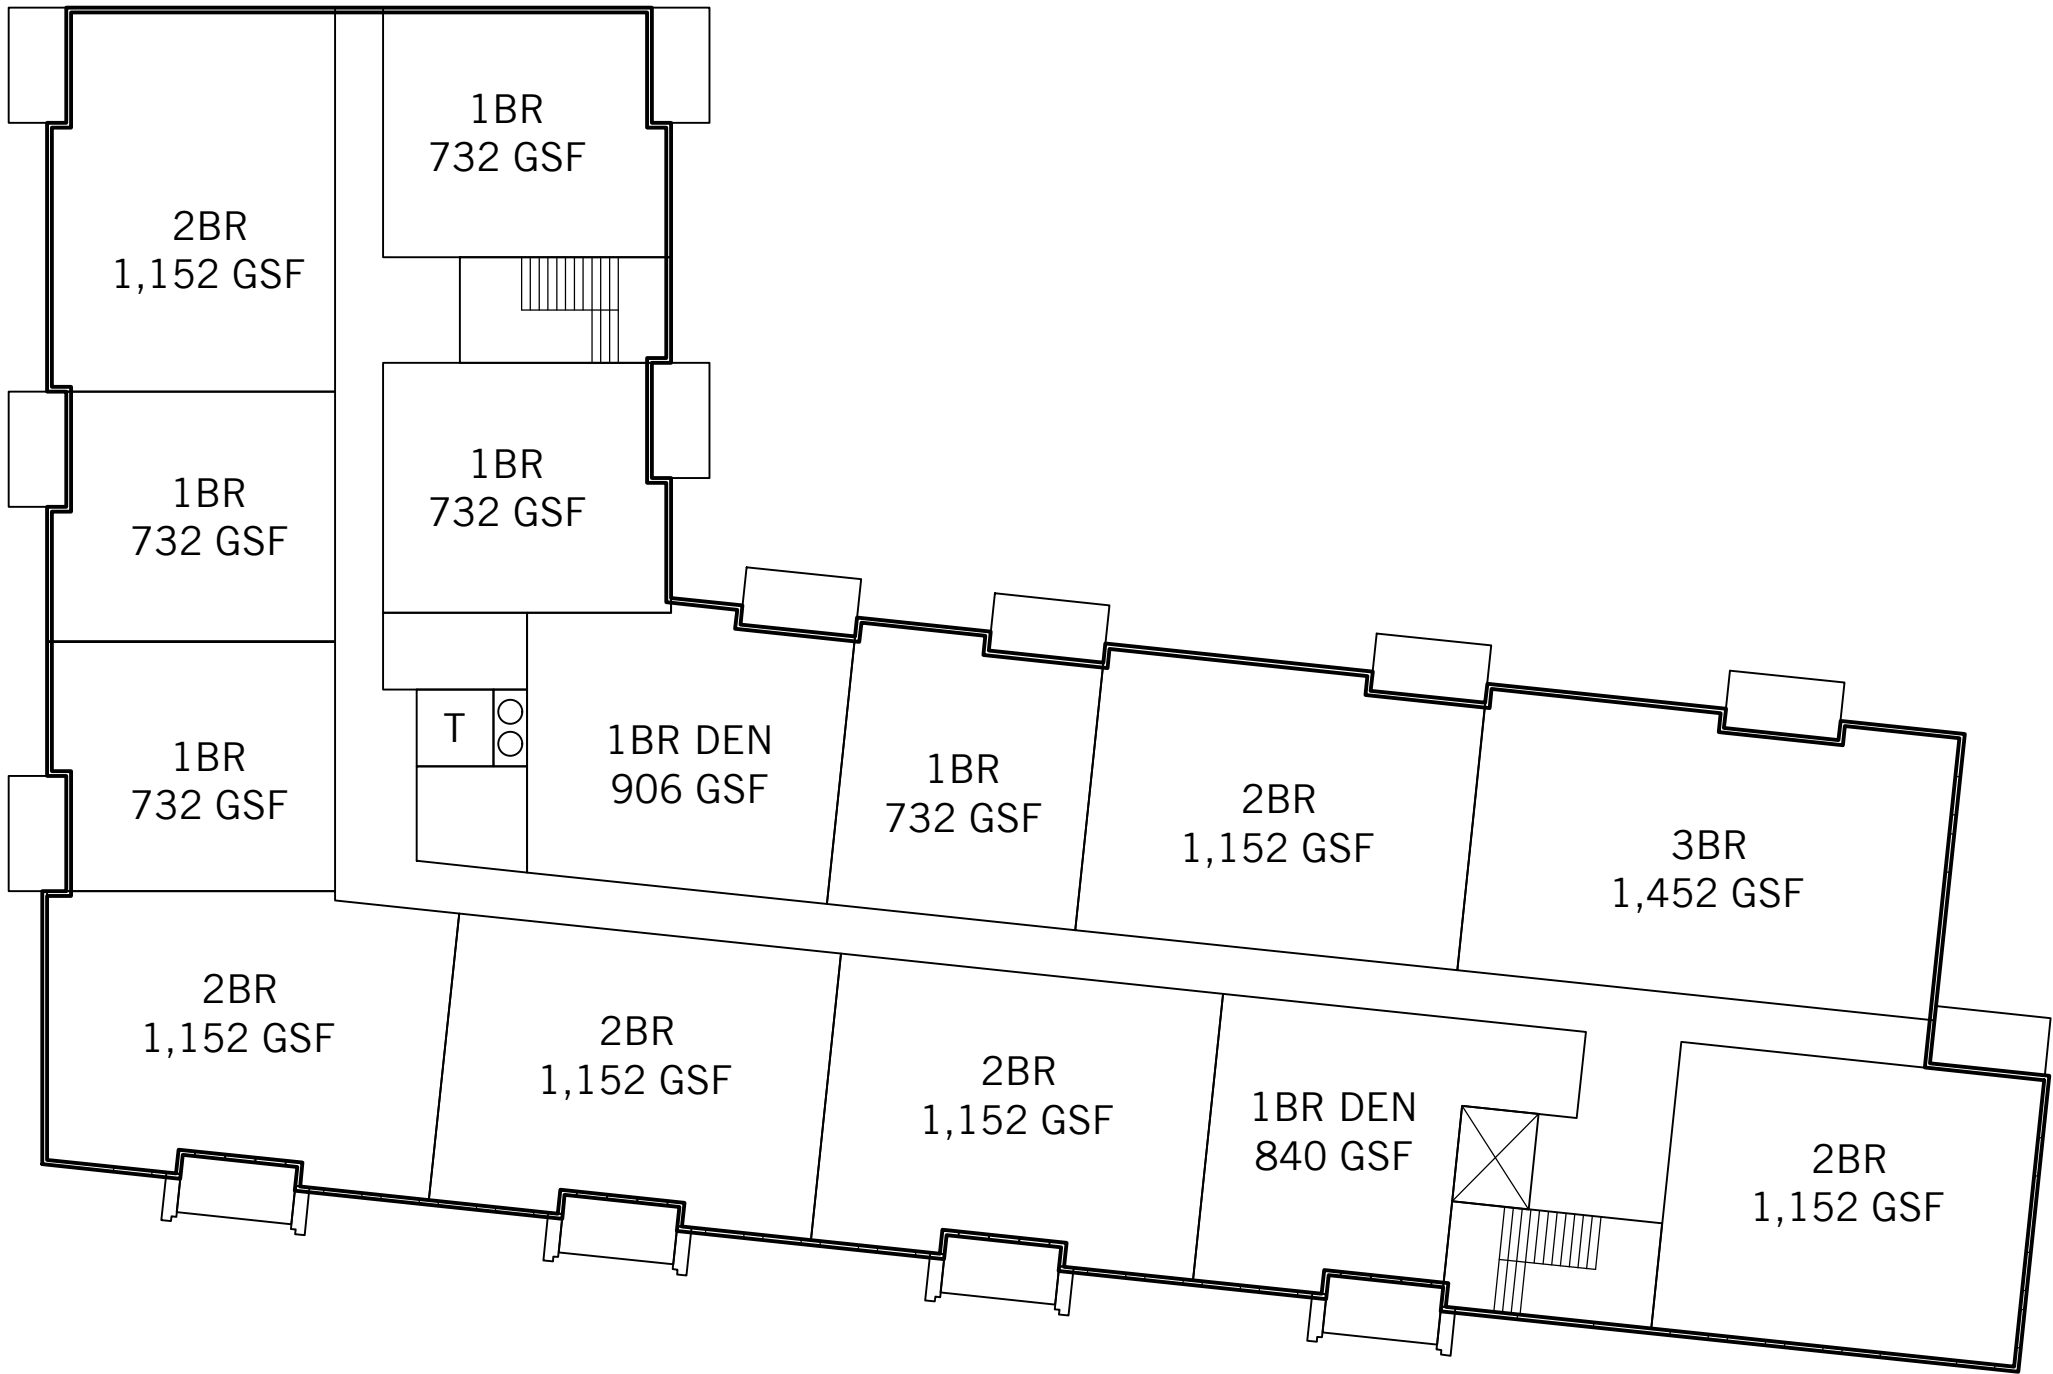



FOURTH FLOOR PLAN

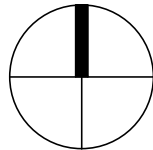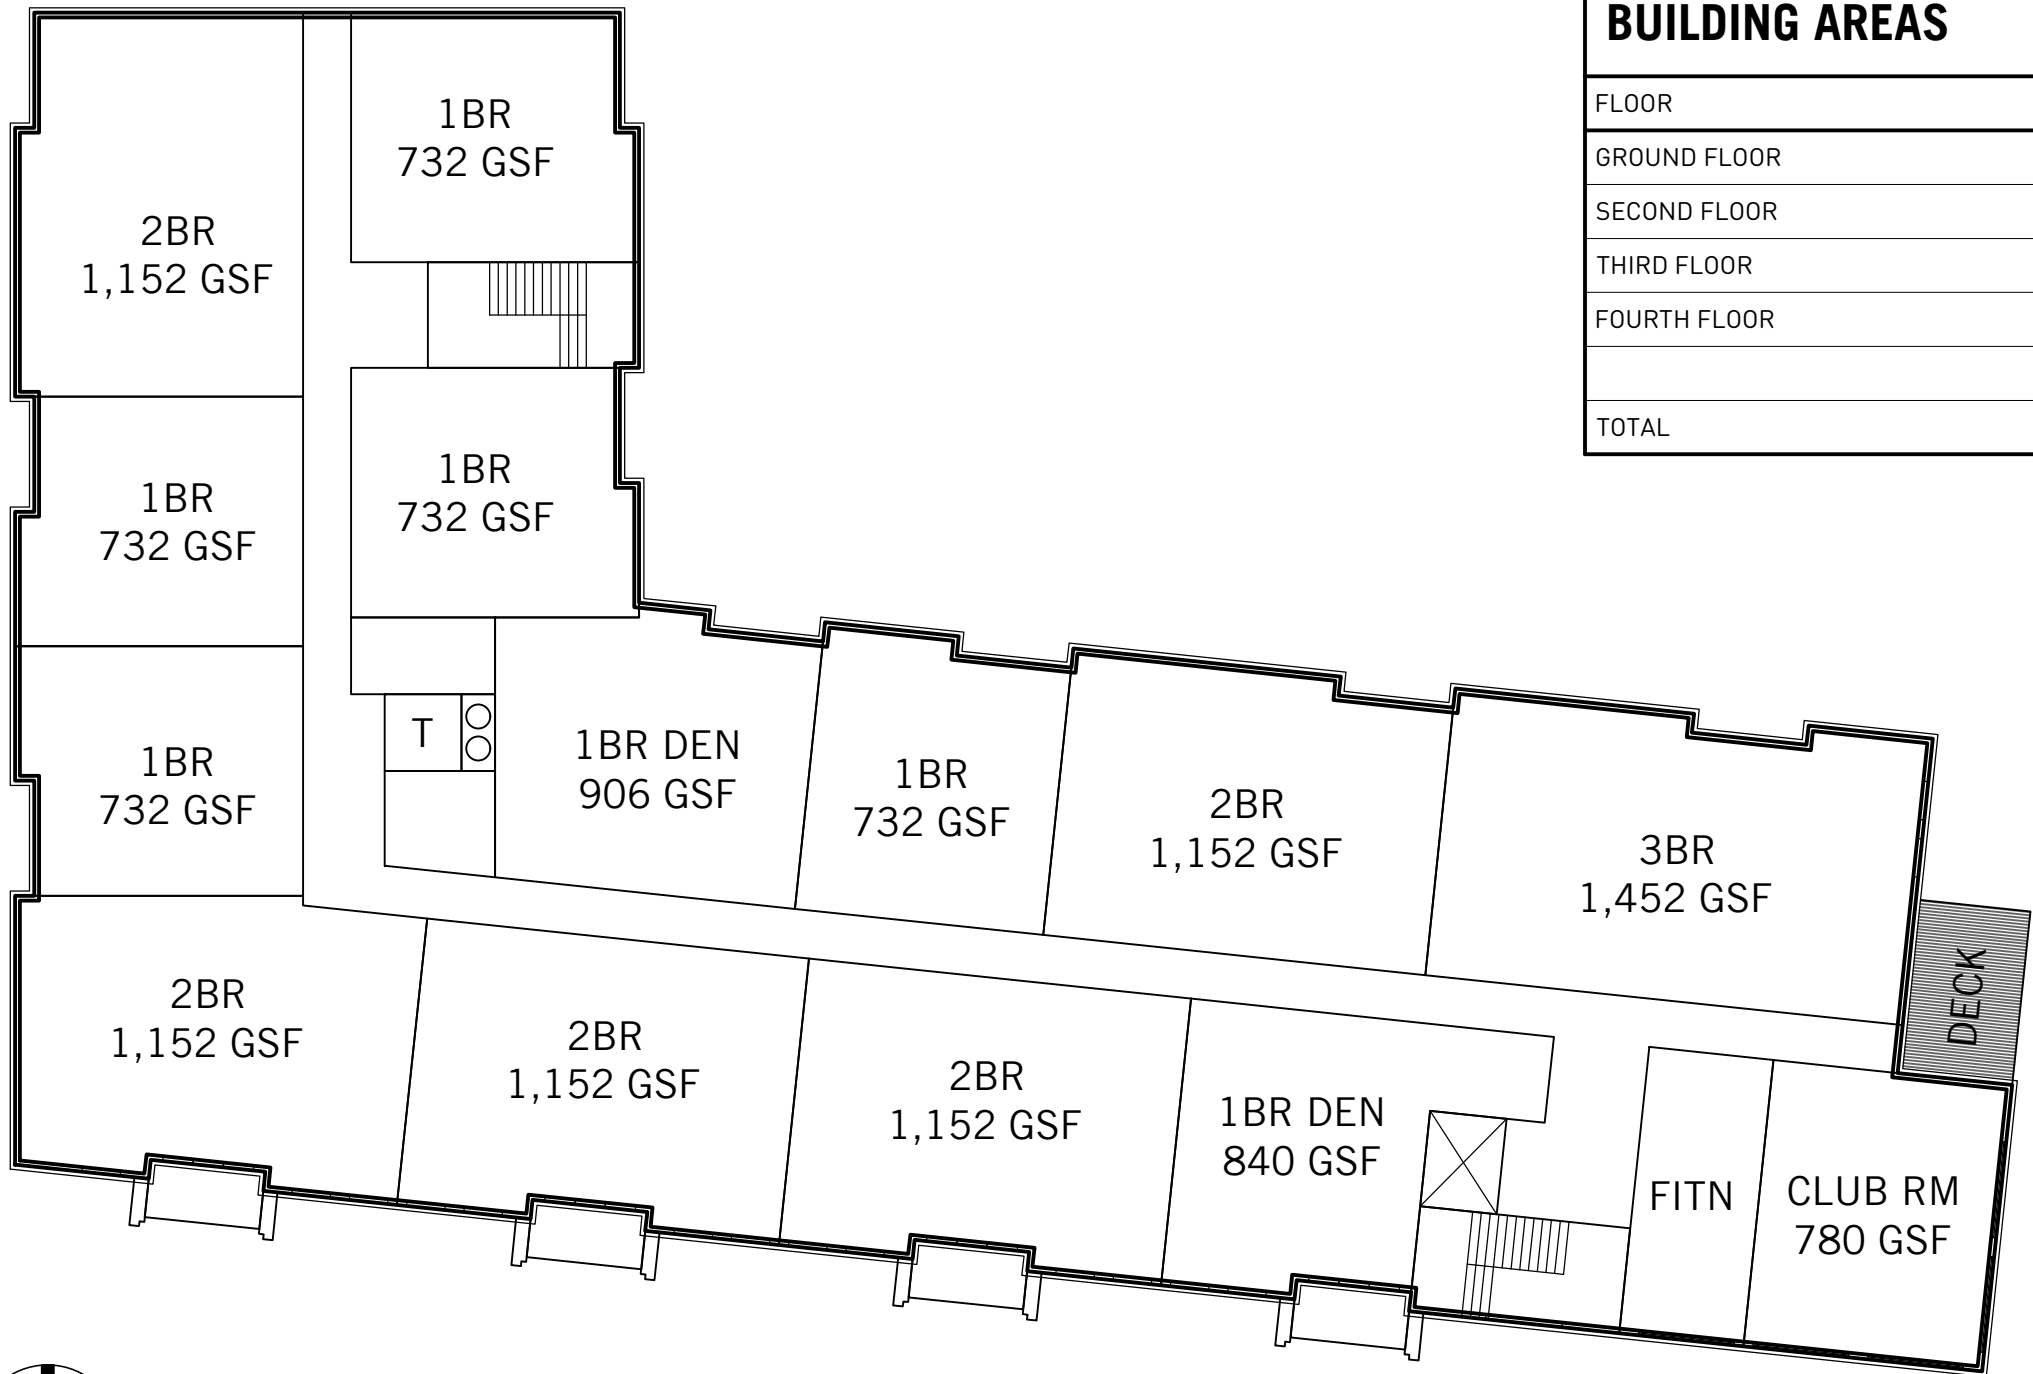

SECOND FLOOR PLAN

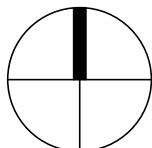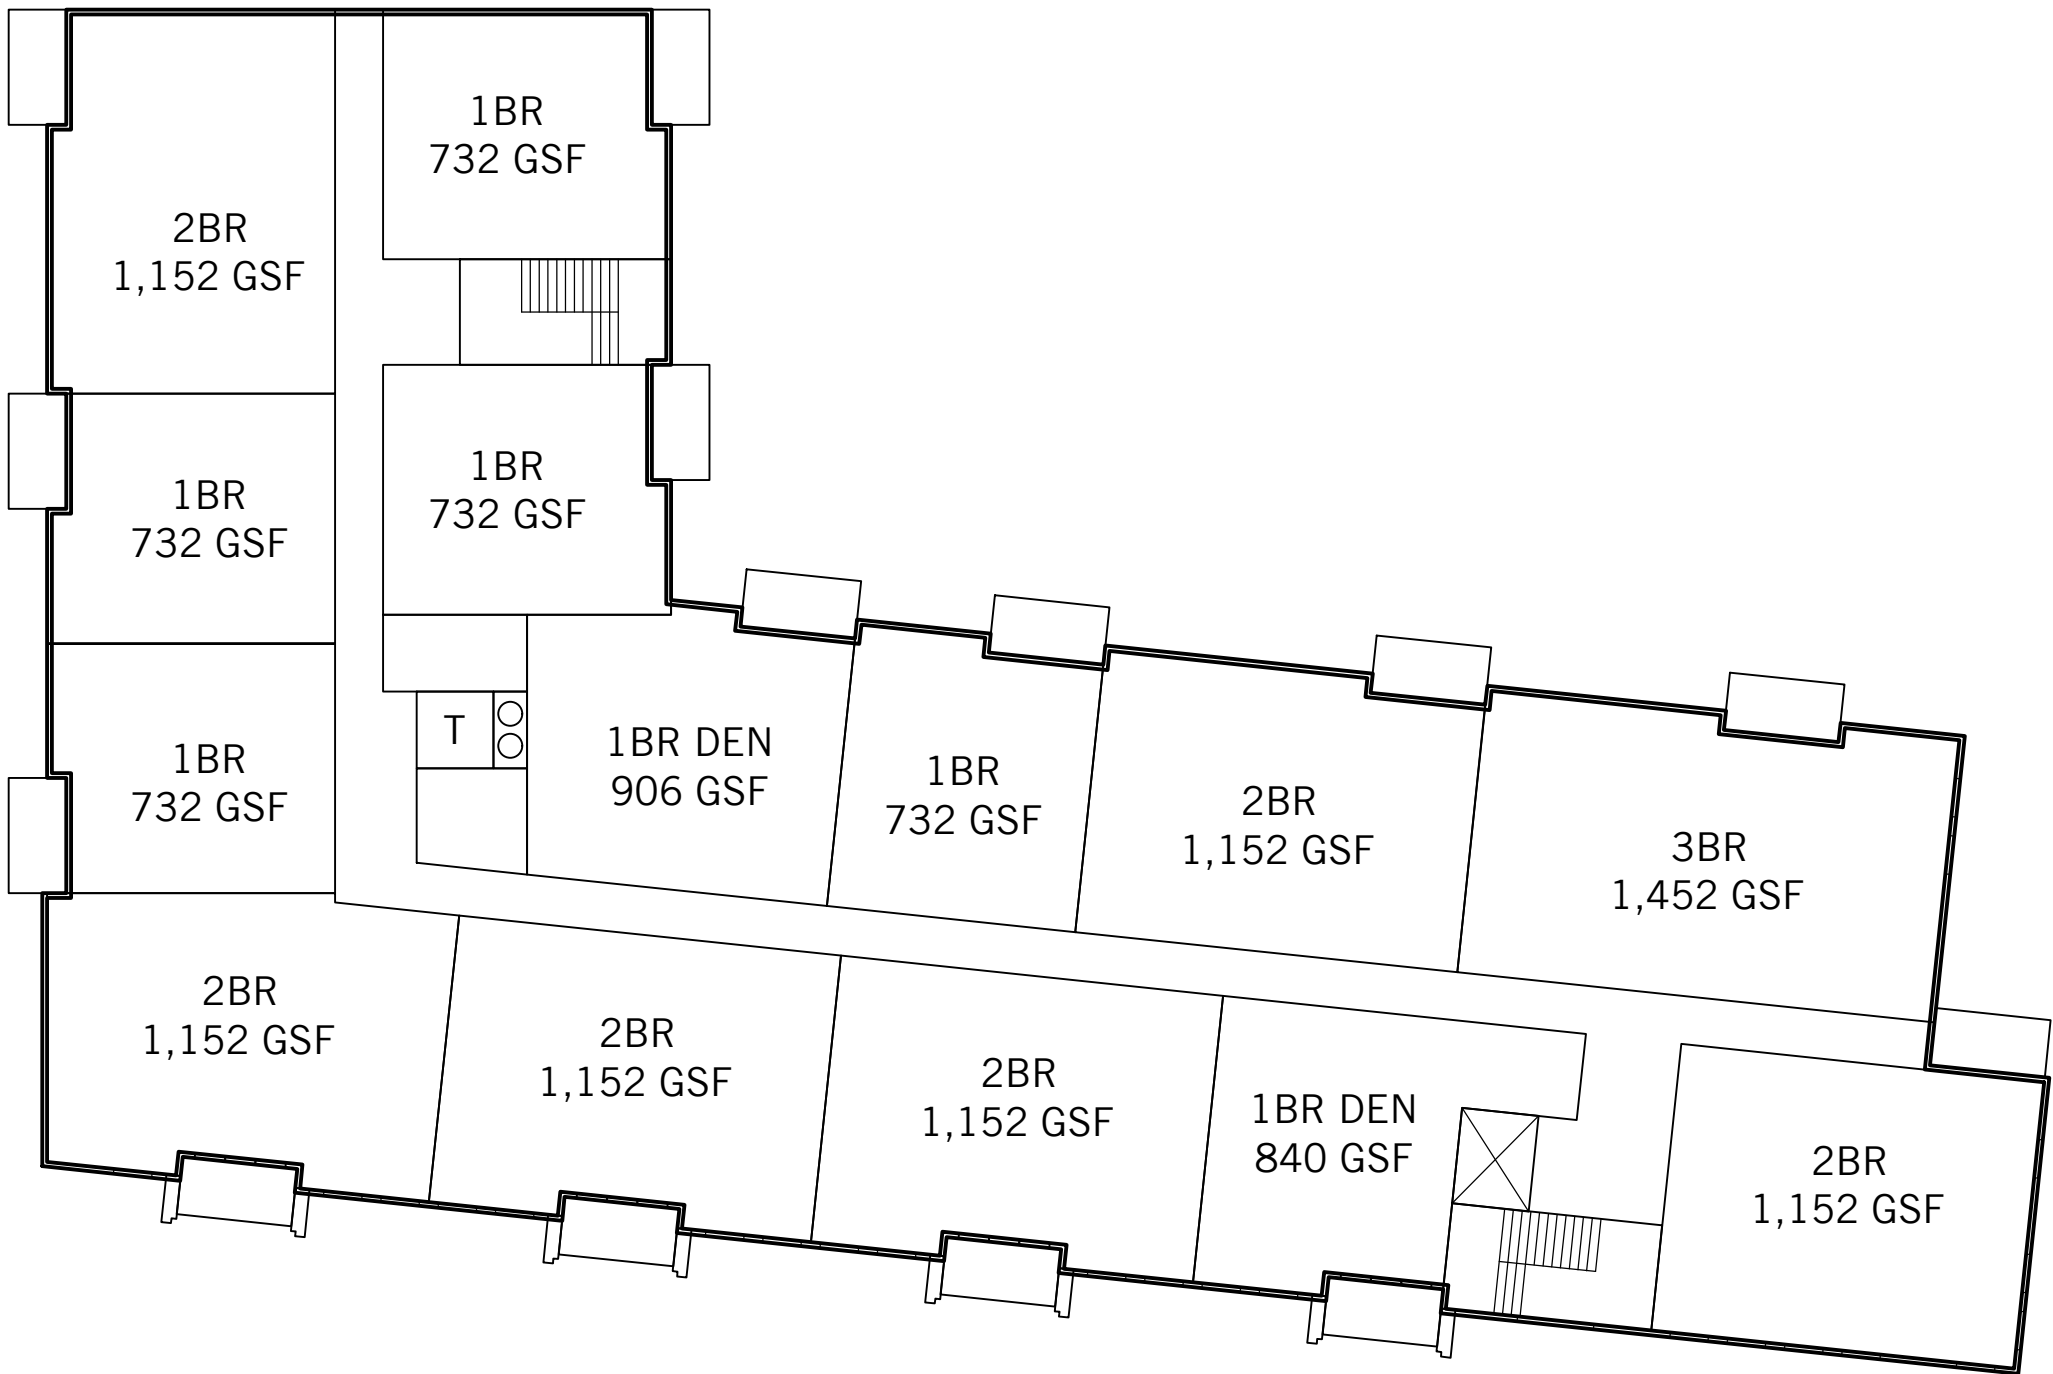

THIRD FLOOR PLAN

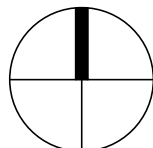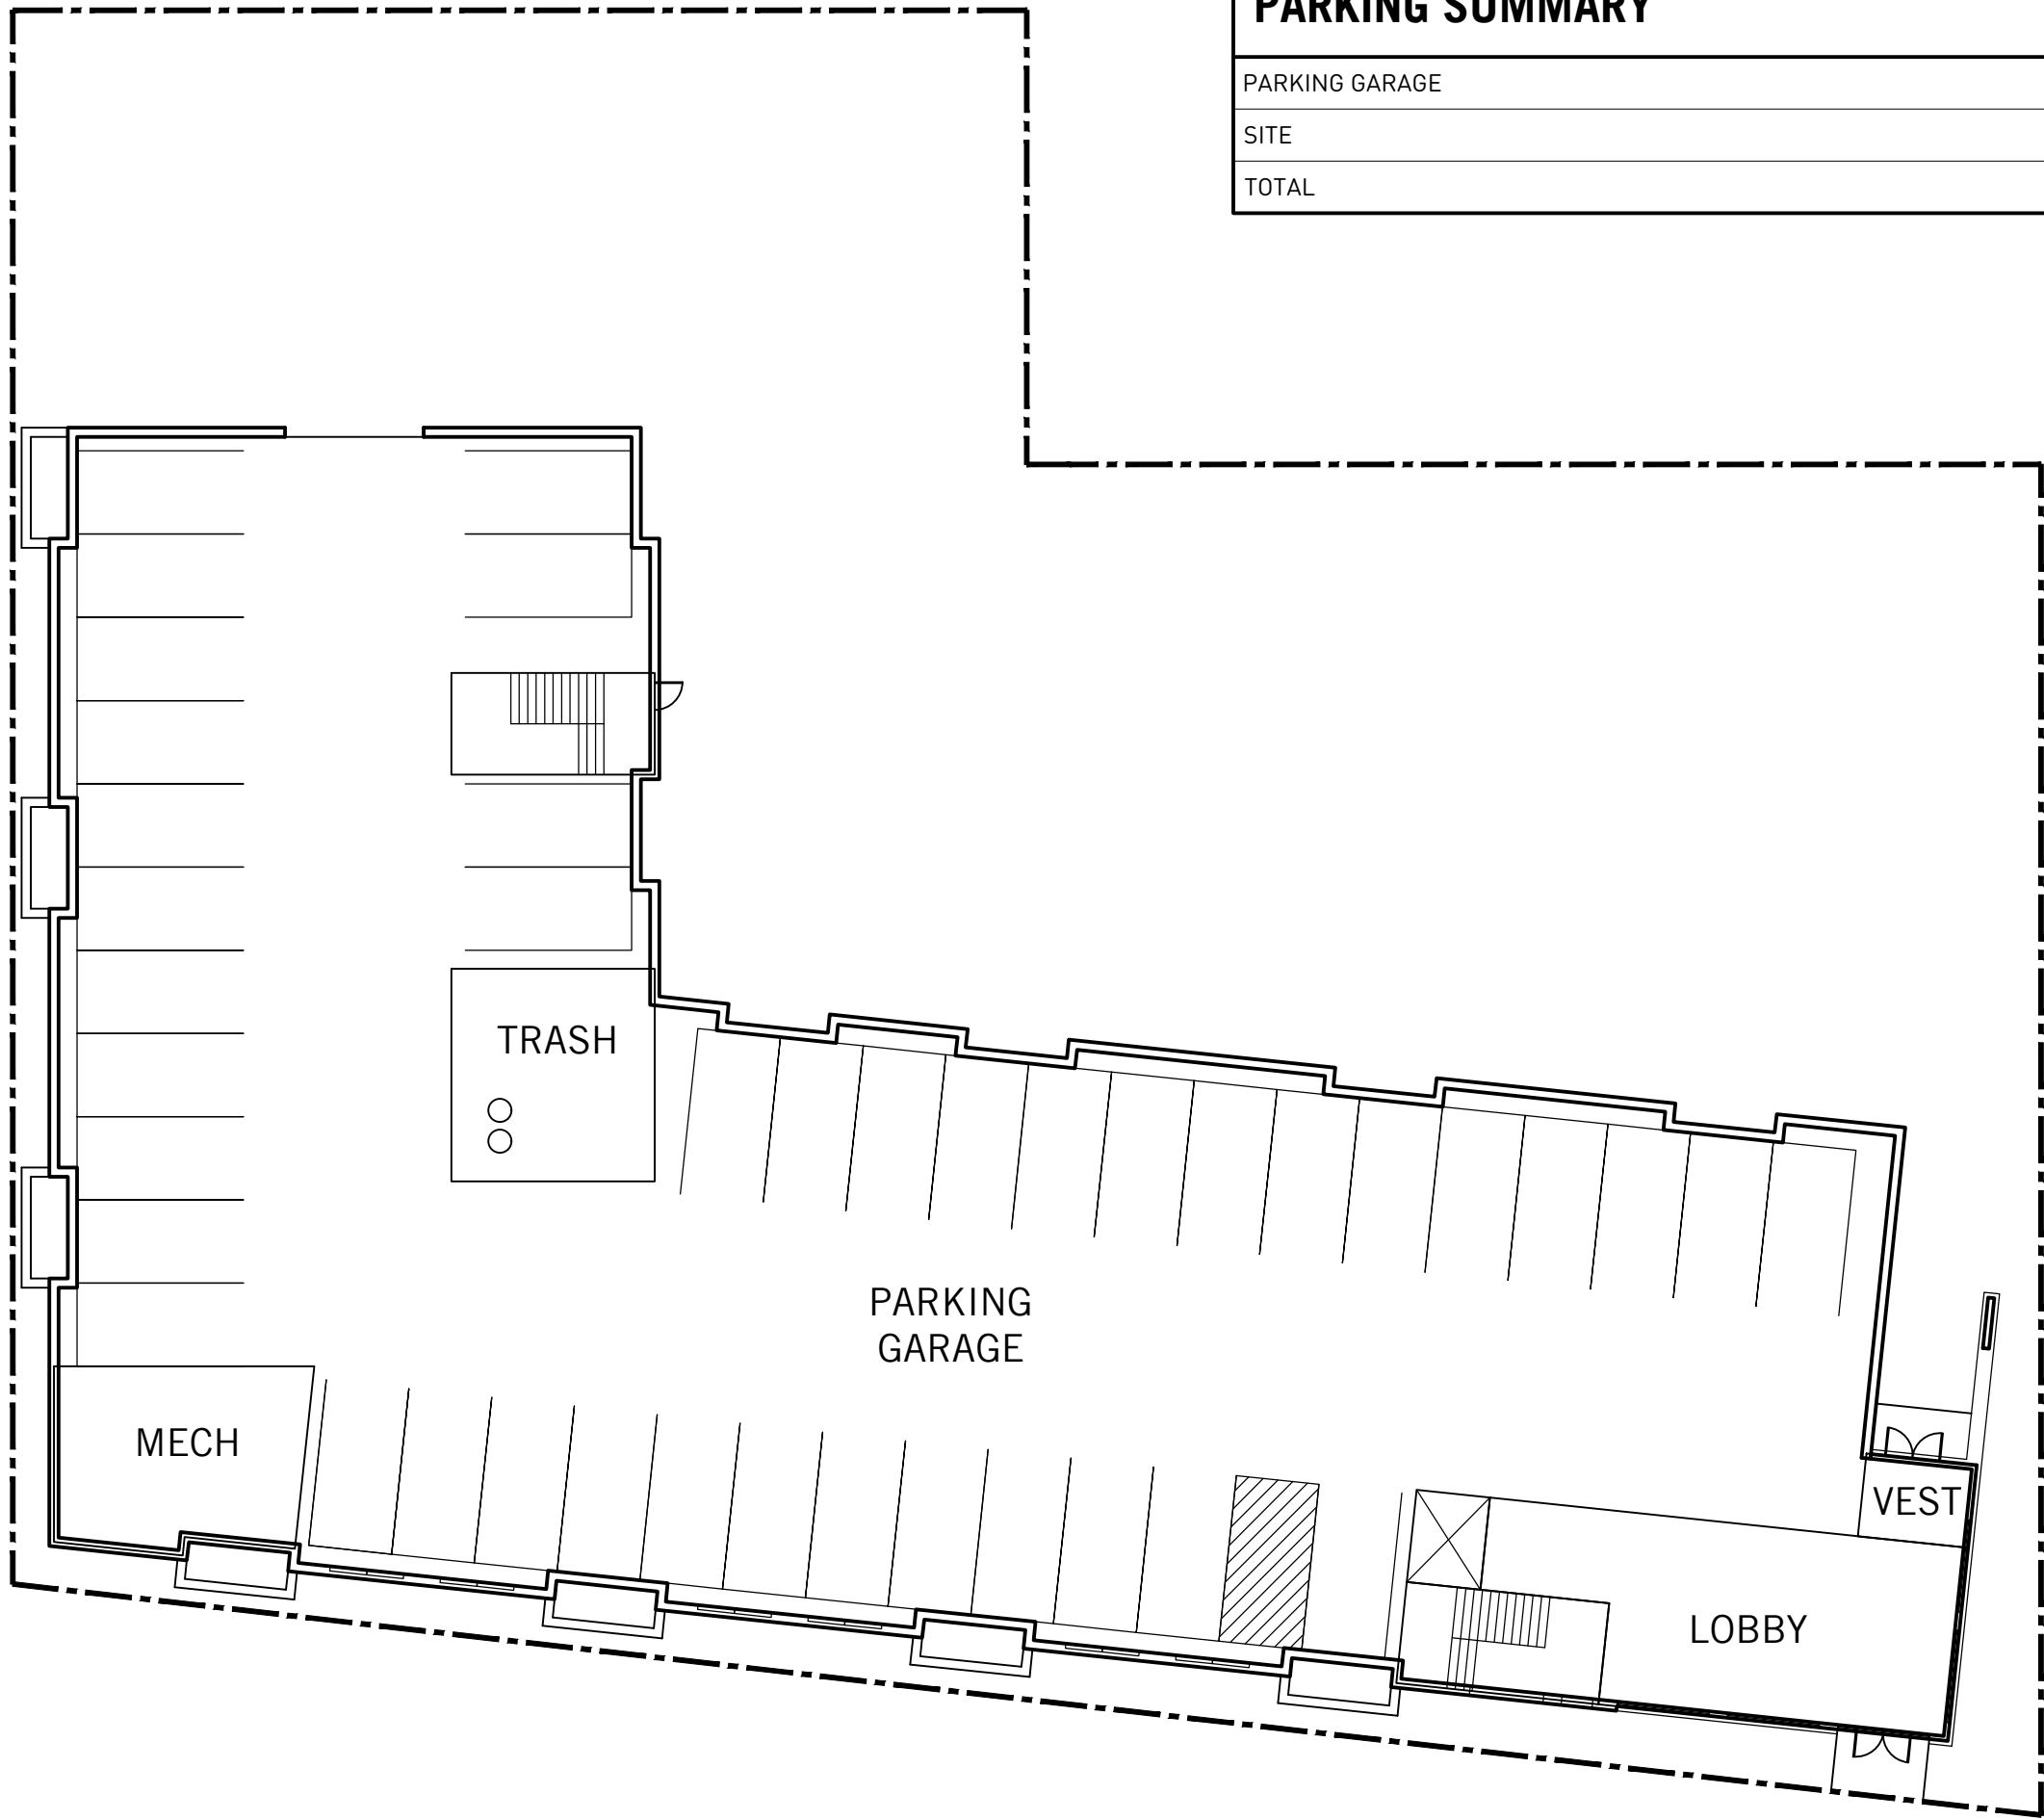

GROUND FLOOR PLAN

PARKING SUMMARY	
PARKING GARAGE	41
SITE	30
TOTAL	71




VIEW OF NEW BUILDING FROM BLUE MOUND ROAD



VIEW OF NEW BUILDING FROM INTERSECTION OF 114TH AND BLUE MOUND ROAD



VIEW OF EXISTING BUILDING FROM INTERSECTION OF 114TH AND BLUE MOUND ROAD

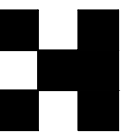

Haydin
Thacker
Architecture

131 W SEEBOTH ST. SUITE 230
MILWAUKEE, WI 53204
1/414-526-7359
HAYDINTHACKER.COM



PROJECT NAME
BLUEMOUND ROAD
MULTI-FAMILY DEVELOPMENT
WAUWATOSA, WISCONSIN


DRAWING REVISION HISTORY

SHEET TITLE
CONCEPTUAL ARCHITECTURAL DRAWINGS


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22008
DRAWING DATE
02-01-2023
SET AND SUBMITTAL TYPE
WAUWATOSA PUD SUBMITTAL

SHEET NUMBER


A400

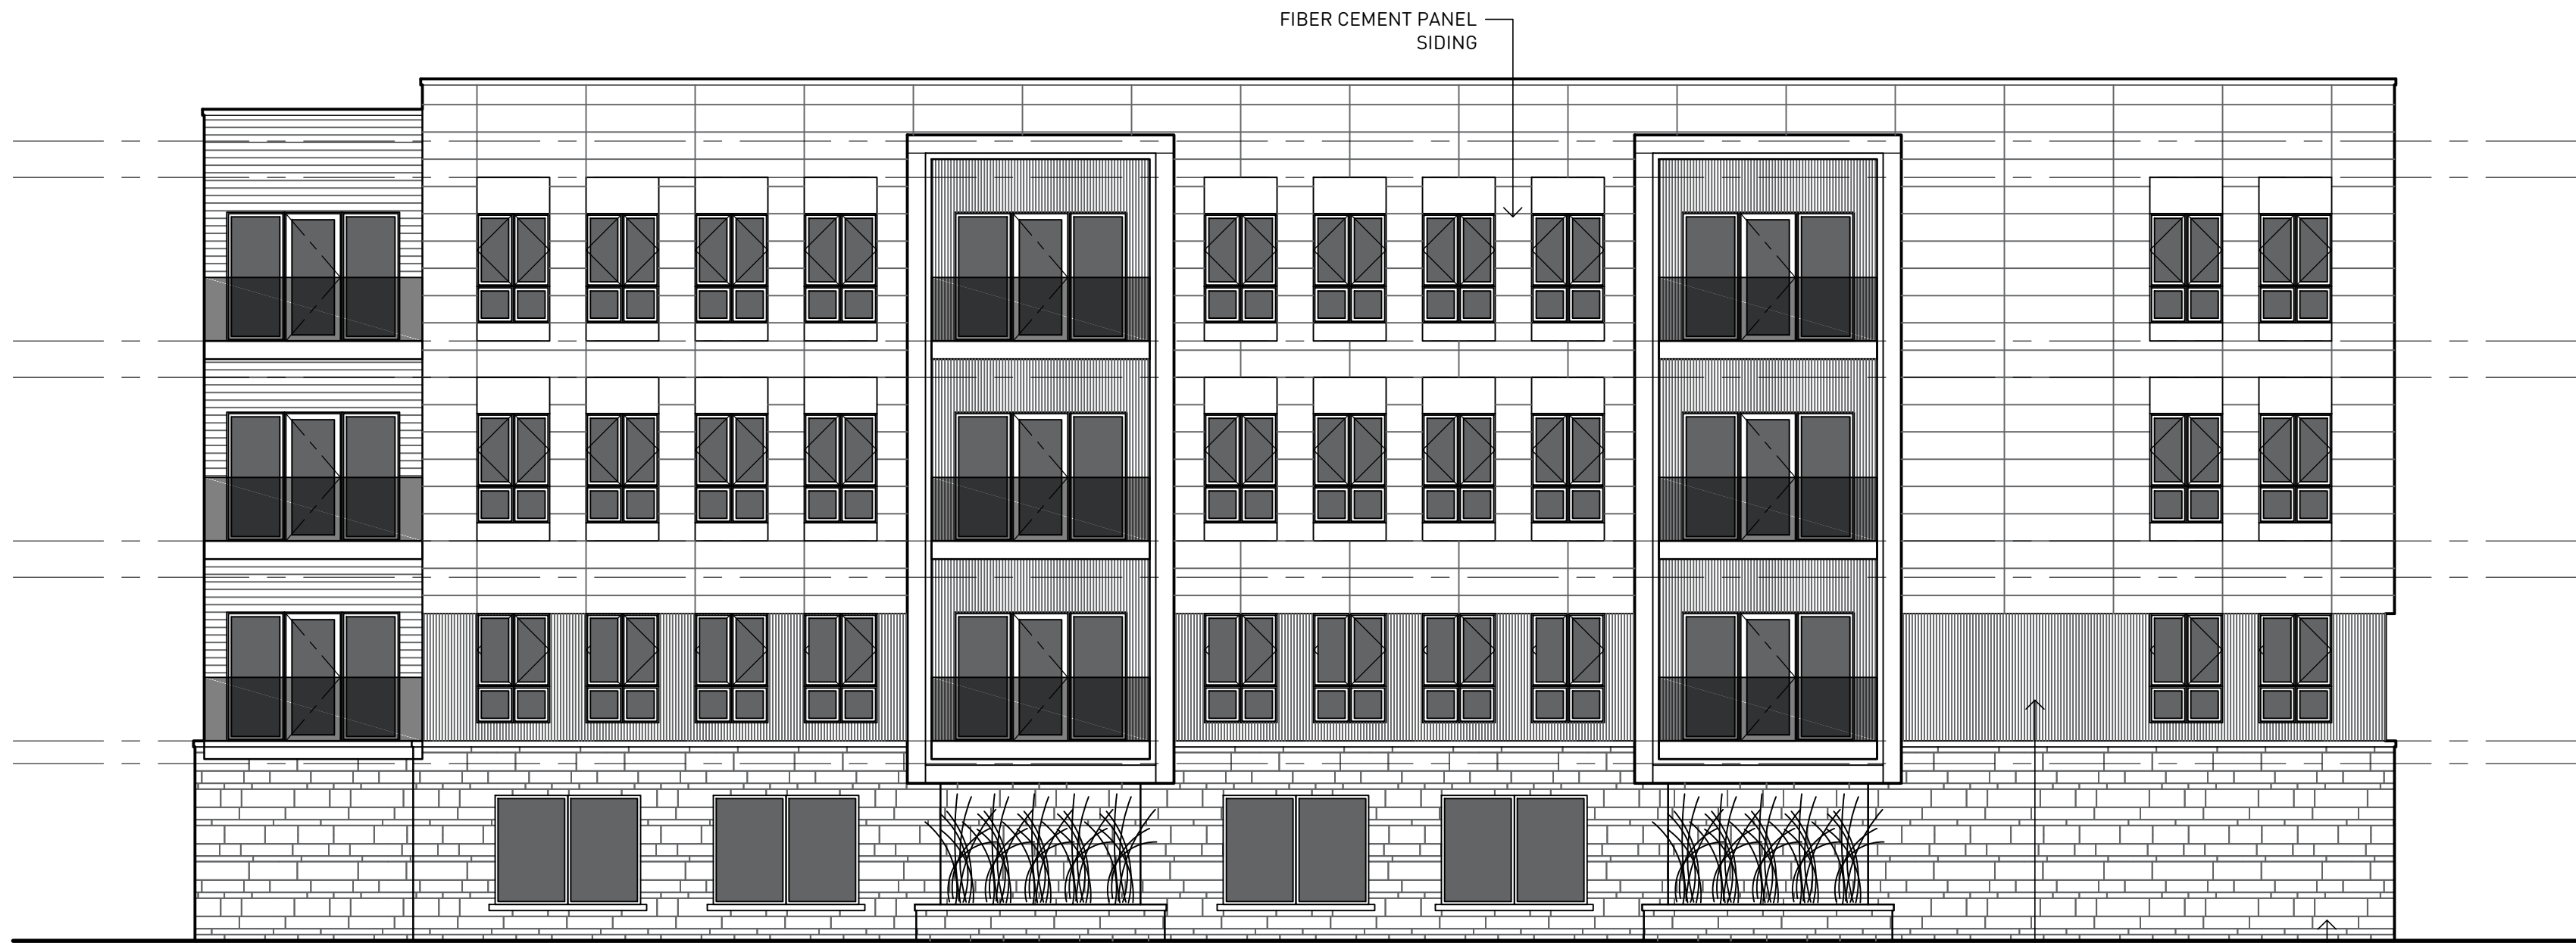


WEST ELEVATION
1/8" = 1'-0"

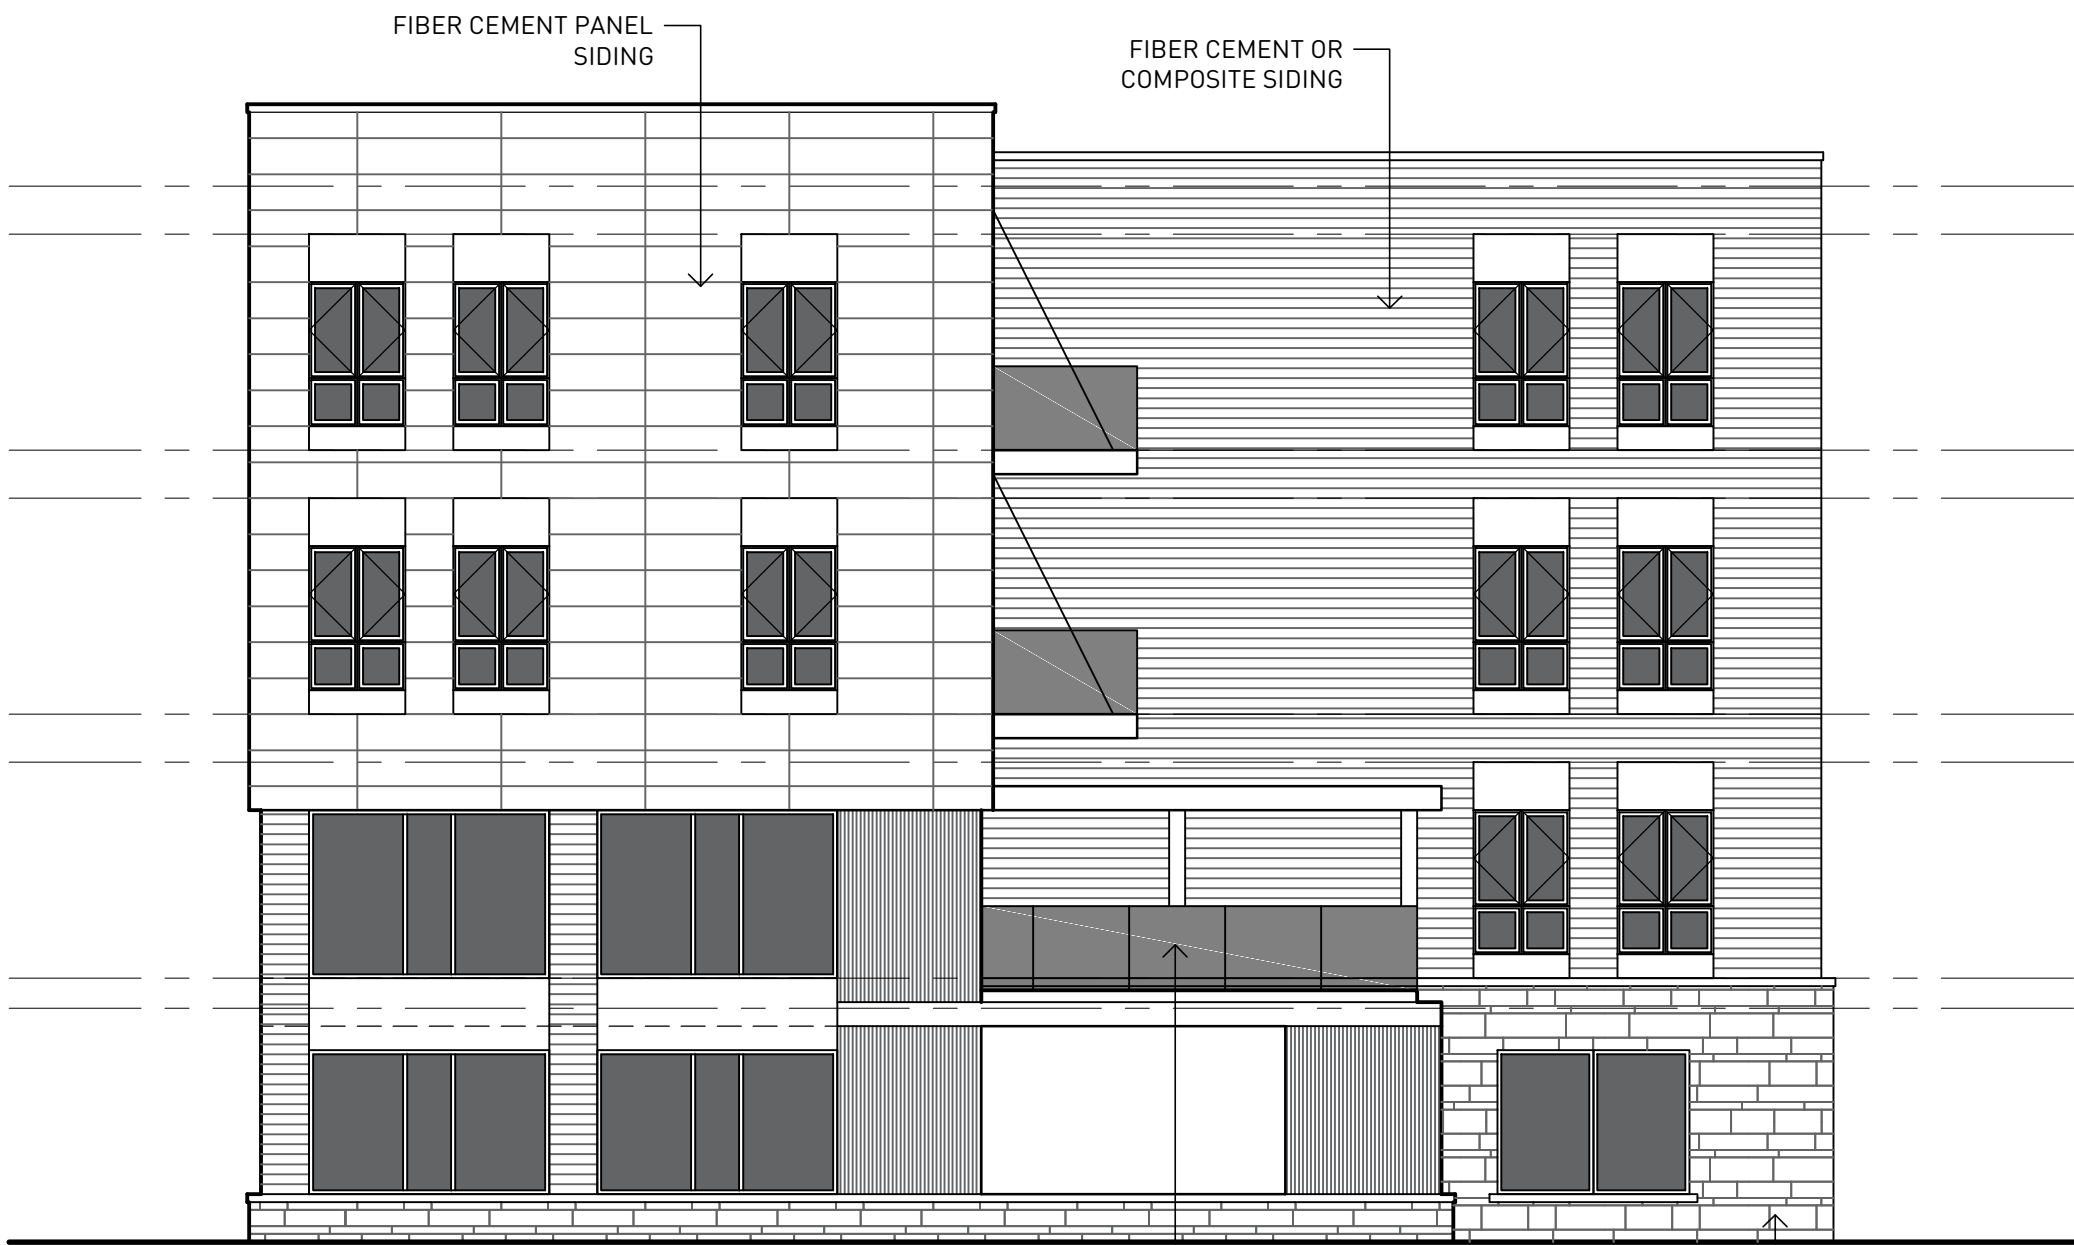

EAST ELEVATION
1/8" = 1'-0"

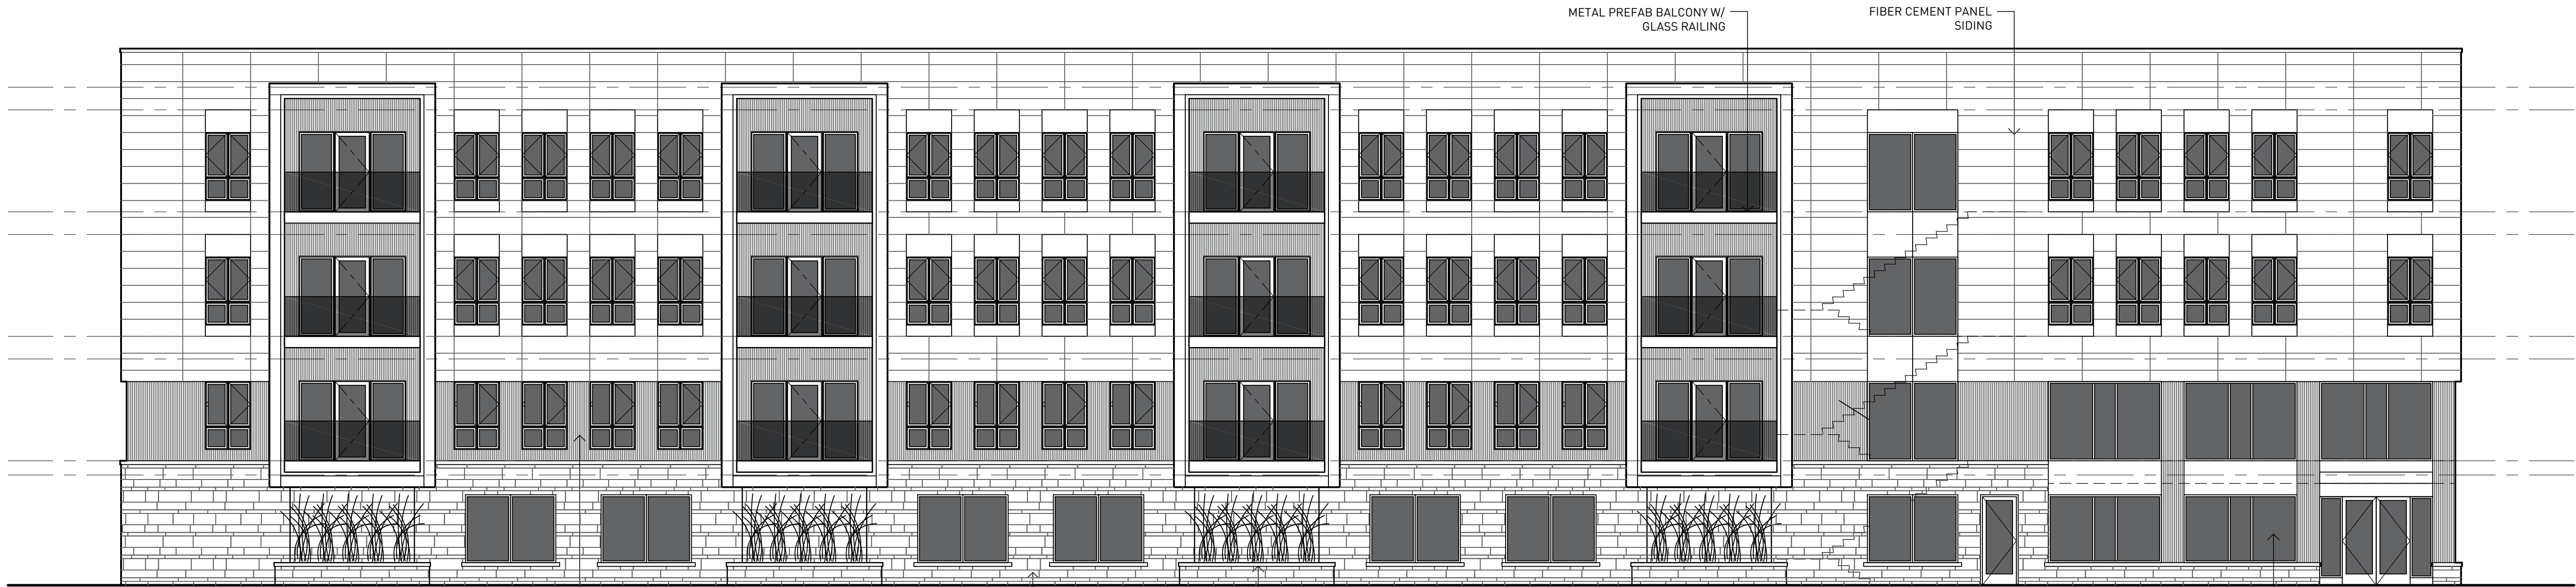

SOUTH ELEVATION (BLUEMOUND ROAD)
1/8" = 1'-0"

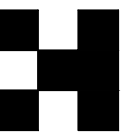

Haydin
Thacker
Architecture

131 W SEEBOTH ST. SUITE 230
MILWAUKEE, WI 53204
1/414-526-7359
HAYDINTHACKER.COM



PROJECT NAME

BLUEMOUND ROAD
MULTI-FAMILY DEVELOPMENT

WAUWATOSA, WISCONSIN

DRAWING REVISION HISTORY

SHEET TITLE
CONCEPTUAL ARCHITECTURAL DRAWINGS

PROJECT NUMBER
22008
DRAWING DATE
02-01-2023
SET AND SUBMITTAL TYPE
WAUWATOSA PUD SUBMITTAL

SHEET NUMBER

A402



NORTH ELEVATION
1/8" = 1'-0"



EAST ELEVATION
1/8" = 1'-0"



NORTH ELEVATION
1/8" = 1'-0"

Jonathan Ward

From: Christopher Carr, P.E. <ccarr@thesigmagroup.com>
Sent: Tuesday, January 31, 2023 1:39 PM
To: Jonathan Ward
Subject: 114 and Bluemound- Stormwater

Jonathon,

The proposed residential project is not disturbing more than 1 acre of land nor is it adding more than 5,000 square feet of impervious area, so it is exempt from any local or State stormwater requirements.

Thanks,

Christopher Carr, PE

Vice President

The Sigma Group, Inc.

414.643.4163

414.517.6724

[1300 W. Canal Street, Milwaukee, WI 53233](https://www.thesigmagroup.com)

www.thesigmagroup.com | ccarr@thesigmagroup.com




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CALL DIGGERS HOTLINE
1-800-242-8511
TOLL FREE
WIS. STATUTE 182.07(2)(197A)
REQUIRES MIN. 3 WORK DAYS
NOTICE BEFORE YOU EXCAVATE
MILW. AREA 259-1181

THE UNDERGROUND UTILITY INFORMATION SHOWN ON THIS MAP IS BASED ON FIELD MARKINGS AND INFORMATION FURNISHED BY UTILITY COMPANIES AND THE LOCAL MUNICIPALITY. WHILE THIS INFORMATION IS BELIEVED TO BE RELIABLE, ITS ACCURACY AND COMPLETENESS CANNOT BE GUARANTEED.



SITE INFORMATION			
SITE AREA	34804	0.799 AC	
SITE DISTURBED AREA	43036	0.988 AC	
EXISTING IMPERVIOUS AREA	26310	0.604 AC	75.6 %
PROPOSED IMPERVIOUS AREA	29688	0.682 AC	85.3 %
TOTAL PARKING SPACES	71		
ADA PARKING SPACES	2		

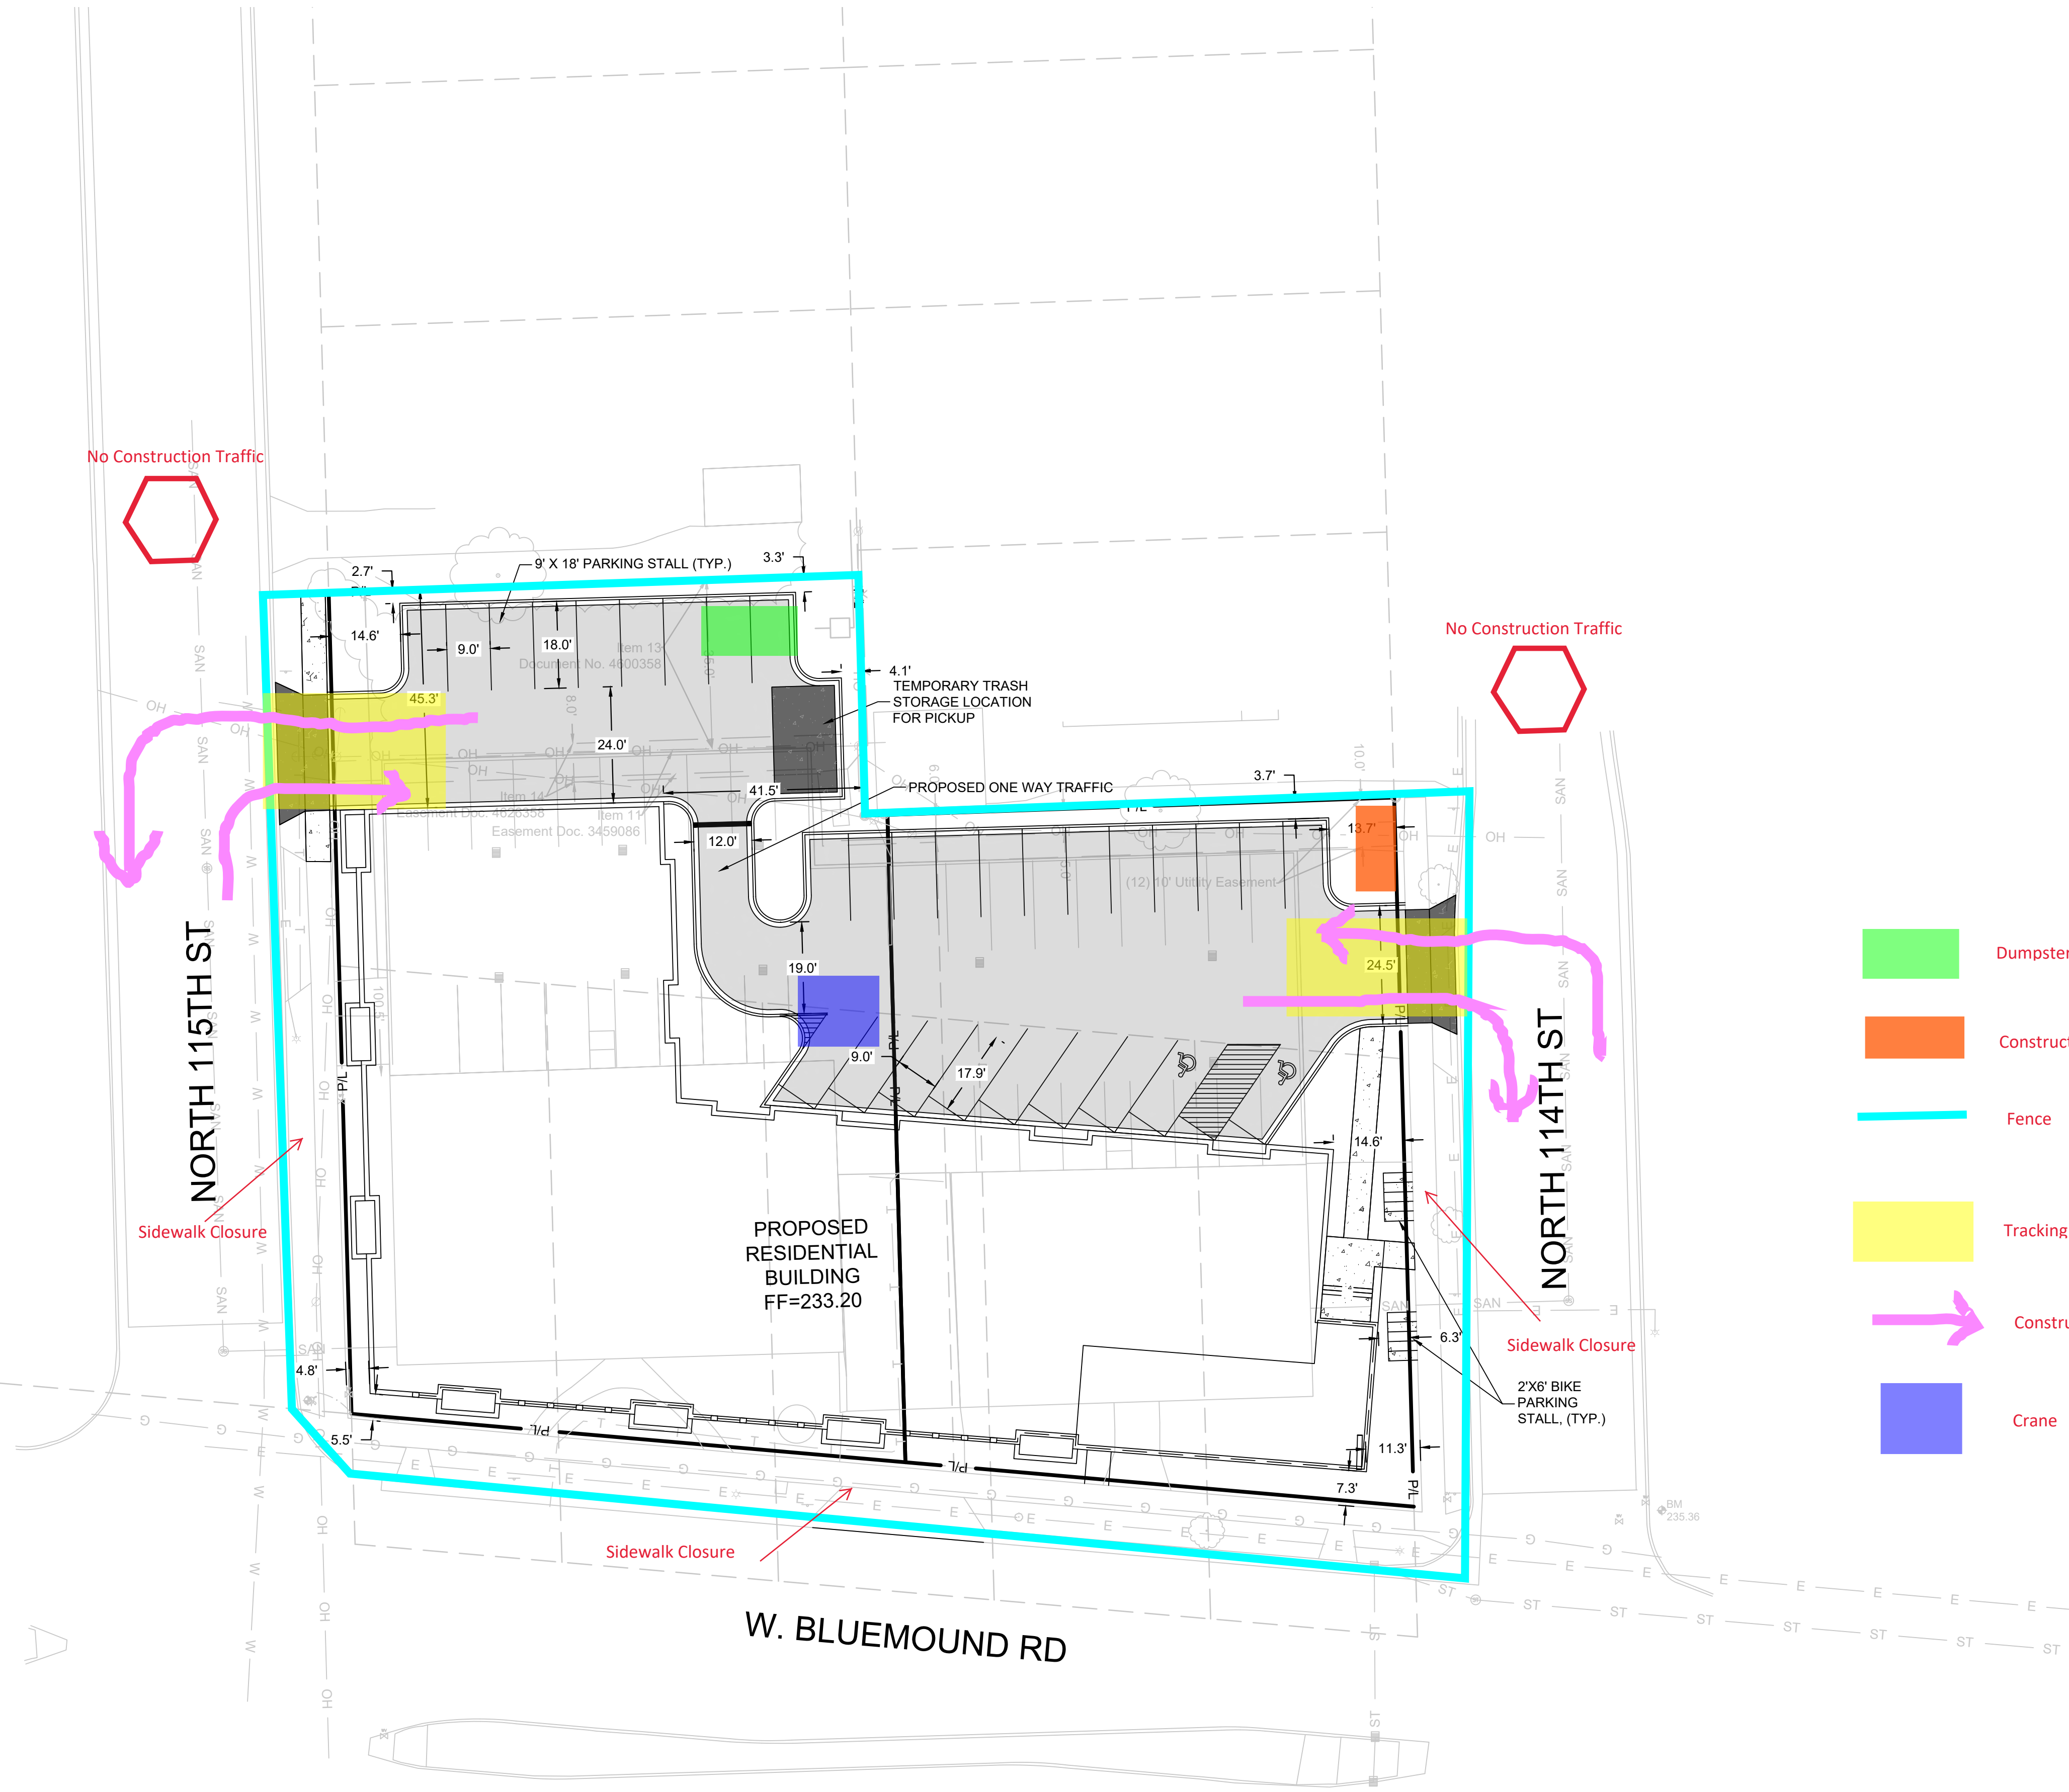LEGEND:

GENERAL NOTES:

- THE UNDERGROUND UTILITY INFORMATION SHOWN ON THIS DRAWING IS BASED ON FIELD LOCATIONS AND/OR RECORDS FURNISHED BY MUNICIPALITIES AND UTILITY COMPANIES. THE LOCATION AND ACCURACY OF WHICH CANNOT BE GUARANTEED. THERE MAY BE ADDITIONAL UNDERGROUND UTILITY INSTALLATIONS WITHIN THE PROJECT AREA THAT ARE NOT SHOWN.
- VERIFY ACTUAL LOCATIONS AND INVERTS IN THE FIELD. ANY POTENTIAL ERRORS, OMISSIONS, OR DISCREPANCIES SHALL BE BROUGHT TO THE ATTENTION OF THE ENGINEER PRIOR TO PROCEEDING WITH CONSTRUCTION.
- WORK TO BE COMPLETED IS INDICATED IN BOLD TYPE LINES AND EXISTING CONDITIONS ARE INDICATED BY LIGHT TYPE LINES.
- ELECTRONIC CIVIL FILES ARE AVAILABLE UPON WRITTEN REQUEST. DO NOT USE ELECTRONIC CIVIL FILES TO LAYOUT FOUNDATIONS, COLUMN LINES, LIGHT POLES, OR OTHER NON CIVIL SITE WORK. REFER TO ARCHITECTURAL DRAWINGS FOR DIMENSIONS OF BUILDING AND ARCHITECTURAL FEATURES.
- DIMENSIONS ARE FROM FACE OF CURB OR EDGE OF PAVEMENT.
- WORK WITHIN THE PUBLIC RIGHT OF WAY, INCLUDING BUT NOT LIMITED TO DRIVEWAY OPENINGS, SIDEWALK AND RAMPS, PAVING, AND CURB AND GUTTER SHALL BE COMPLETED PER MUNICIPAL AND/OR COUNTY REQUIREMENTS AND STANDARDS.
- EARTHWORK SHALL BE IN ACCORDANCE WITH GEOTECHNICAL ENGINEER'S RECOMMENDATIONS.

Dumpster

Construction Office


Fence

Tracking Pad

Construction Traffic

Crane

THESIGMA GROUP
Single Source. Sound Solutions.
www.thesigmagroup.com
1300 West Canal Street
Milwaukee, WI 53233
Phone: 414-643-4200
Fax: 414-643-4210

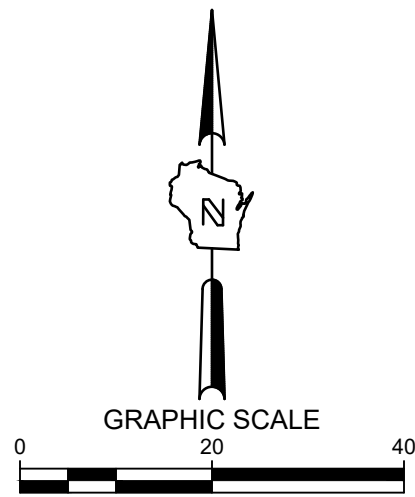

114TH AND BLUEMOUND
11430 - 11400 BLUEMOUND ROAD
WAUWATOSA, WISCONSIN

SITE PLAN

PRELIMINARY
NOT FOR
CONSTRUCTION

SCALE:	1"=20'
PROJECT NO:	21393
DESIGN DATE:	----
PLOT DATE:	1/17/2023
DRAWN BY:	----
CHECKED BY:	----
APPROVED BY:	----
SHEET NO:	C100

Wauwatosa Youth Commission

Report to the Community Affairs Committee of the City of Wauwatosa

April 25, 2023 and Budget Committee in August 2023

Mission of Wauwatosa Youth Commission

- A. To act as an advisory body to the Common Council and the Mayor of Wauwatosa and to provide comment and recommendations on proposed policies and ordinances affecting youth.
- B. To encourage, develop and implement activities and services that promote a positive environment for youth in the City of Wauwatosa.
- C. To serve and represent a broad spectrum of youth from diverse backgrounds and all geographic areas of Wauwatosa.
- D. To report annually to the Mayor and the Common Council on the interests, needs and recommendations concerning matters that affect the youth of Wauwatosa.
- E. To cooperate and coordinate with other organizations that have in common the interests of Youth.

Meetings:

The Commission meets on the second Wednesday of each month, September-May.

- Youth and Adult Members now meet at 6:15 PM -7:30 PM in the Lower Civic Center
- In March of 2020, our meetings were put on hold due to the pandemic and other circumstances occurring in the City beyond our control. Our first meeting was one year later on February 12, 2021 and it was a Zoom meeting which continued through our Commission year 2021-2022.
- This year, Commission year 2022 – 2023, was when we resumed meeting in person (initially in the Upper Civic Center and then beginning in April 2023, we moved to the Lower Level Civic Center).

2021-2022 Goals for Commission Year and Progression (As presented to the Committee on March 29, 2022)

- Continue to strengthen the relationship between the Wauwatosa Youth Commission and Executive Branch of Wauwatosa government (ex. Mayor, Alderperson, Mayor's Office and Staff).
- Birthday mailings to all identified Wauwatosa youth during the month of their 18-birthday to congratulate them and remind students to register to vote and for boys, register for the Selective Service duty.
- Implement the findings of the School District's Youth Perception Survey. The Youth Commission was able to advocate for 5 additional questions to be placed on the School District's Youth Perception Survey the prior year, we were finally able to see the efforts come to fruition once the results from the October 2020 survey came to publication in March of 2021. However, due to concerns about the mental health of students because of the challenges over the past year, the commission will continue to work towards achieving a greater focus on the needs of our community in this area in 2021 – 2022. More information on this initiative to be provided in the section below.

As a result of the findings for the 5 questions the Youth Commission created for the Youth At Risk Perception Survey, we developed a flyer listing Mental Health Resources and Coping Skills which were distributed electronically in an Eblast to all the School Families by the School District in May of 2021 and were placed on the City Health Department's website. Hard copies of the flyers were hung on the inside of doors of bathroom stalls in the Middle Schools and High Schools as well as in doctor's offices, the City Community Bulletin Board, resource shelf in the Public Library and Health Department and coffee shop bulletin boards when the COVID-19 restrictions were lifted.

- Continue Community Service and Outreach opportunities for youth of Wauwatosa. Members continue to look for service opportunities and events to increase the visibility of the Youth Commission as permitted with COVID-19 precautions in place.
- Continue to offer recreation events to youth of Wauwatosa. We look forward to being able to Resume our efforts to encourage the youth in Wauwatosa to experience community events in 2020 – 2021 as possible with following CDC guidelines and social distancing.
- Continue to recruit youth and adult members for the Wauwatosa Youth Commission. This past year has been challenging on this front. Former means of being able to recruit new members were put on hold due to the pandemic. The Youth Commission plans to reignite the member drive through acts of community service, public health initiatives, and word of mouth this upcoming year.
- Participate in the 4th of July Parade with an auto displaying the Youth Commission's Name and distributing candy to children watching the parade to bring awareness of The Youth Commission
- Supported local high schools with donations to the theatre programs and APPSE Teams as a way to advertise the Youth Commission and possible membership. We will participate in the City's first Tosa Takes the Trash Day on April 30, 2022.
- We gained 2 Adult Member and 5 Youth Members in 2021 – 2022

2021 – 2022 Guests/Presenters:

We had Officer Andy Yothesakda, Tosa East High School School Resource Officer as a guest speaker, and our Ex-Officio Member, Officer Dan Kane give a presentation on Bullying, focusing mainly on Cyber Bullying. The presentation was on December 8, 2021 during our Zoom meeting which gave the Youth ideas of how to manage this issue of concern they wanted to address this year.

2022 - 2023 Current Plans in Process and Achievements

- Continue to strengthen the relationship between the Wauwatosa Youth Commission and Executive Branch of Wauwatosa government (ex. Mayor, Alderperson and the Common Council, Mayor's Office and Staff). We would also like to partner with other City Commissions and Committees on projects in the upcoming year.
- The Youth felt many other groups were focusing on ways of providing information to reduce Bullying and Cyber Bullying in the schools and community, so they decided to concentrate on re-distributing the informational flyer they had created in May of 2021 addressing Mental Health Resources and Ways to Reduce Stress and list of coping skills. School District Representative, Emilie O'Connor, (Director of Student Success) helped by resending the flyer in a district wide eblast message to families and posting the flyers in the Middle Schools and High Schools bathroom stalls again.

Community and Promotion Events:

- Birthday mailings to all identified Wauwatosa youth during the month of their 18th birthday to congratulate them and remind students to register to vote and for boys, register for the Selective Service duty
- Supported local high schools with donations to the theatre programs by purchasing Ad Space in the Playbills to promote the Youth Commission and possible membership in it.
- The Youth planned to Participate in the 4th of July Parade with an auto displaying the Youth Commission's Name and distributing candy to children watching the parade to bring awareness of The Youth Commission. Unfortunately, the logistics of this idea proved to be something they were unable to carry out.
- Continue Community Service and Outreach opportunities for youth of Wauwatosa. Members continue to look for service opportunities and events to increase the visibility of the Youth Commission.
- We plan to participate in a food collection/distribution event in October, 2023 in conjunction with the Tosa Cares Food Pantry and possibly again in the Spring.
- Continue to recruit youth and adult members for the Wauwatosa Youth Commission. This past year has been challenging on this front. Former means of being able to recruit new members were put on hold due to the pandemic. The Youth Commission plans to reignite the member drive through acts of community service, public health initiatives, and word of mouth this upcoming year. We will have a table at the High School Registration days in August, 2023. We also had an information table at the Incoming Freshman and Course Information nights at the High Schools in January.
- Revived this year, from years prior to COVID shut down, we offered the opportunity to community members to nominate a youth who put forth outstanding volunteer effort in serving the Wauwatosa community. We didn't have any nominations this year and hope to promote this Award earlier next year, beginning in December 2023.
- We gained 2 Adult Member and 3 Youth Members in 2022 – 2023 (and unfortunately, lost 1 Adult Member)

Guests in 2022 - 2023:

Mrs. Eva Ennamorato, Wauwatosa City Communications Manager, came to our December 14th, meeting to discuss ways and venues the Youth Commission could use to promote our Commission and stay within the Open Meeting Laws in doing so.

On March 8th, 2023 the Wauwatosa West High School APPSE (American Public Policy Special Emphasis class) Team came and gave their presentation to the Youth Commission so we could become better acquainted with and/or better understand what the group would be presenting and how they present their material at the National Competition in Washington D.C. at the end of April this year. On April 12th, 2023 the APPSE Team from Wauwatosa East High School came and presented the topics they would be covering at the National Competition.

2022-2023 Goals and 2023 – 2024 Proposed Budget

	<u>2022 – 2023 Expense</u>	<u>2023 - 2024 Proposed Exp.</u>
• Stay in touch with the School District Director of Secondary Education for results to the 5 questions we created and the School District added to the Youth Perception Survey (replenish our flyers)	\$ 85.00	\$ 100.00
• Keep an active role in Tosa Takes out the Trash Day	\$ none	\$ none
• 4 th of July Parade	\$ none	\$ none
• Trunk or Treat	\$none	\$ none
• Continue to recruit youth and adult members for the Wauwatosa Youth Commission (membership post cards)	\$ 80.00	\$ 100.00
• Update Coroplast Sign Board Contact Information	\$ 85.00	\$ none
• Continue Birthday mailings to all identified Wauwatosa youth during the month of their 18 th birthday to congratulate them and remind students to register to vote and Selective Service duty	\$750.00	\$ 800.00
• Purchased Program/Playbill Ad Space in Tosa East High School And Tosa West High School Theatre Programs (Fall & Spring Productions)	\$ 590.00	\$ 650.00
• Continue to present community service awards in May 2024 to students from Wauwatosa that volunteer to serve our community. (Put this on hold until January of 2022 due to pandemic and timing of needing to start preparing before we could hold meeting).	\$ none	\$1,000.00
• Create an idea/s of how to use our carry over balance of over \$6,000 (?) and carry the plan out	\$ none	\$2,000.00
• Purchase more Youth Commission T-Shirts	<u>\$ 400.00</u>	<u>\$ 400.00</u>
• Total =	\$1,905.00	\$5,050.00



Staff Report

File #: 23-1222

Agenda Date: 4/25/2023

Agenda #: 6.

Resolution approving a Conditional Use Permit in the M1 District at 1435 N 113th Street for a sports and recreation participant establishment, Bron Launsby, Innovative Heights Wauwatosa, LLC, applicant

WHEREAS Bron Launsby, Innovative Heights Wauwatosa, LLC., applied for a Conditional Use Permit in the M1 District at 1435 N 113th Street for a sports and recreation participant establishment, and;

WHEREAS, this request was reviewed and recommended by the City Plan Commission to be necessary for the public convenience at that location; located and proposed to be operated in such manner which will protect the public health, safety, and welfare; and was found to be compatible with surrounding uses;

NOW, THEREFORE, BE IT RESOLVED by the Common Council of the City of Wauwatosa, Wisconsin hereby grants a Conditional Use Permit to Bron Launsby, Innovative Heights Wauwatosa, LLC., subject to:

1. Hours of operation Monday through Thursday from 1:00 pm to 8:30 pm; Friday 11:00 am to 10:00 pm; Saturday from 10:00 am to 10:00 pm; and Sunday from 11:00 am to 8:30 pm.
2. If the City receives complaints regarding parking, the applicant shall take corrective action to resolve all parking issues to the satisfaction of the Planning Manager and Public Works Director.
3. Providing detailed costs of any alterations and/or new construction, as well as income & expense as requested by the Assessor's office.
4. Short- and long-term bicycle parking must be provided in compliance with City Code 24.11.080.
5. Prior to occupancy permit issuance, submitting a site plan/parking lot plan for Engineering approval that provides pedestrian accessibility to the public right-of-way and provides trash container screening. If any modifications to parking lot lighting are proposed, a photometric plot must be submitted to Engineering for review and approval.
6. Any building project in excess of \$100,000 is subject to sanitary sewer lateral replacement or repair if the existing lateral does not pass Board of Public Works testing requirements according to City Code 13.30.030.
7. Under WMC 24.16.040I., a Conditional Use will lapse and have no further effect one year after it is approved by the Common Council, unless a building permit has been issued (if required); the use or structure has been lawfully established; or unless a different lapse of approval period or point of expiration has been expressly established by the Common Council.
8. Obtaining other required licenses, permits, and approvals.
9. Installation of a 6-foot fence with arborvitae on the northern border of the property.
10. Adoption of a policy and posting signage prohibiting the presence of firearms,
11. Installation of exterior security cameras. Adding security guards if determined needed by Wauwatosa Police Department
12. Installation of right-turn-only signs and painted directional arrows at the driveway exits along N 113th Street.

By: Plan Commission

Recommendation: Referred from Council

