Wauwatosa, WI 53213

MSI General St. John's Lutheran

### PLAT OF SURVEY

LOCATION: 7827 Harwood Avenue, Wauwatosa, Wisconsin

## LEGAL DESCRIPTION:

West 50 feet of Lot 1, in **DOUGLAS HEIGHTS**, being in the Southeast 1/4 of Section 21 and the Northeast 1/4 of Section 28, in Township 7 North, Range 21 East, City of Wauwatosa, Milwaukee County, Wisconsin.

Survey No. 113429

### PLAT OF SURVEY

LOCATION: 1249 Dewey Avenue, Wauwatosa, Wisconsin

## LEGAL DESCRIPTION:

Lot 9 of ASSESSOR'S PLAT NO. 26 and Lots 1 and 2 of CHARLES FINGADO'S SUBDIVISION and the East 31.3 feet of Lot 1 of DOUGLAS HEIGHTS SUBDIVISION, being part of the Southeast 1/4 of Section 21, Town 7 North, Range 21 East, City of Wauwatosa, Milwaukee County, Wisconsin.

Survey No. 113427

## PLAT OF SURVEY

LOCATION: 1278 Dewey Avenue, Wauwatosa, Wisconsin

#### LEGAL DESCRIPTION:

Lot 22 in FINGADO'S SUBDIVISION, of 9.66 Acres of land in the Southeast 1/4 of Section 21, in the Township 7 North, of Range 21 East, in the Third Ward of the City of Wauwatosa, excepting therefrom that portion thereof conveyed by deed recorded in Volume 598 of Deeds, on page 34 (#647352) to the Milwaukee Sanitarium Association and further excepting therefrom that portion of said Lot 22, conveyed by deed recorded in Volume 556 of Deeds, on page 289 (#591009) to Johanna Habenicht, also excepting therefrom the premises described in Deed Document #2343040.

Survey No. 113428

Lot Area 53,394 sq. ft.

Chain Fence S 88°58'14" W 142.80'

METROPOLITAN SURVEY

PROFESSIONAL LAND SURVEYORS

● — Denotes Iron Pipe Found

 $\odot$  — Denotes Iron Pipe Set

9415 West Forest Home Avenue, Suite 202

Hales Corners, Wisconsin 53130

PH. (414) 529-5380 survey@metropolitansurvey.com


www.metropolitansurvey.com

SERVICE, INC.

Lot Area -- 1 7,100 sq. ft.

Existing Dwelling


May 10, 2022 February 9, 2023 Revised Elevations / Added Topography

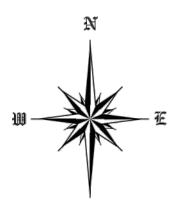



CALL DIGGERS HOTLINE 1-800-242-8511 TOLL FREE

WIS STATUTE 182.0175(1974) REQUIRES MIN. 3 WORK DAYS NOTICE BEFORE YOU EXCAVATE 1-800-242-8511

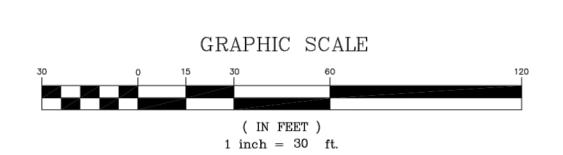




I HEREBY CERTIFY THAT I HAVE SURVEYED THE ABOVE DESCRIBED PROPERTY AND THAT THE ABOVE MAP IS A TRUE REPRESENTATION THEREOF AND SHOWS THE SIZE AND LOCATION OF THE PROPERTY. ITS EXTERIOR BOUNDARIES, THE LOCATION OF ALL VISIBLE STRUCTURES AND DIMENSIONS OF ALL PRINCIPAL BUILDINGS THEREON, BOUNDARY FENCES, APPARENT EASEMENTS AND ROADWAYS AND VISIBLE ENCROACHMENT, IF ANY.

THIS SURVEY IS MADE FOR THE EXCLUSIVE USE OF THE PRESENT OWNERS OF THE PROPERTY, AND ALSO THOSE WHO PURCHASE, MORTGAGE, OR GUARANTEE THE TITLE THERETO WITHIN ONE (1) YEAR FROM THE DATE HEREOF.

Dennis C. Sauer Professional Land Surveyor S-2421

SURVEY/EXISTING SITE PLAN 1" = 30'-0"

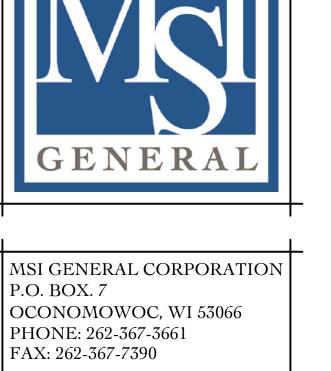

P.O. BOX. 7 OCONOMOWOC, WI 53066 PHONE: 262-367-3661 FAX: 262-367-7390

WWW.MSIGENERAL.COM SINGLE SOURCE RESPONSIBILITY TM

	1	1
_	ISSUE DATES:	
	Proposal:	xx/xx/xxxx
	Contract:	xx/xx/xxxx
	State Submittal / Permit:	
	City Submittal:	06/07/2023
	Record Drawings:	xx/xx/xxxx
	REVISIONS:	
	1	

ST. JOHN'S WAUWATOSA

_	
	PROJECT ADDRESS
	PROJECT NAME St. John's Evangelical Lutheran Sc STREET ADDRESS
	1278 Dewey Ave.
	CITY/ STATE / ZIP

ALL WORK TO BE COMPLETED AS SHOWN, AND IN ACCORDANCE WITH THE LATEST EDITION OF THE MSI GENERAL MASTER SPECIFICATION

SURVEY EXISTING SITE PLAN C-001 P13329



MSI GENERAL CORPORATION P.O. BOX. 7 OCONOMOWOC, WI 53066 PHONE: 262-367-3661 FAX: 262-367-7390

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ISSUE DATES:	
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State Submittal / Permit:	xx/xx/xxxx
City Submittal:	06/07/2023
Record Drawings:	xx/xx/xxxx
REVISIONS:	

# PROJECT ADDRESS:

ST. JOHN'S WAUWATOSA

PROJECT NAME
St. John's Evangelical Lutheran Sch.
STREET ADDRESS
1278 Dewey Ave.
CITY/ STATE / ZIP

Wauwatosa, WI 53213

ALL WORK TO BE COMPLETED AS SHOWN, AND IN ACCORDANCE WITH THE LATEST EDITION OF THE MSI GENERAL MASTER SPECIFICATION

Architect: Engineer: Reviewed By:
BJZ -- AMH
Sheet Title:
FIRE ACCESS
SITE PLAN
Sheet Number:

C-002
Project Number: -P13329

FIRE ACCESS SITE PLAN 1" = 20'-0"





MSI GENERAL CORPORATION P.O. BOX. 7 OCONOMOWOC, WI 53066 PHONE: 262-367-3661 FAX: 262-367-7390

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ISSUE DATES:	
Proposal:	xx/xx/xxxx
Contract:	xx/xx/xxxx
State Submittal / Permit:	xx/xx/xxxx
City Submittal:	06/07/2023
Record Drawings:	xx/xx/xxxx
REVISIONS:	

ST. JOHN'S WAUWATOSA

# PROJECT ADDRESS:

St. John's Evangelical Lutheran Sch.
STREET ADDRESS
1278 Dewey Ave.
CITY/ STATE / ZIP

Wauwatosa, WI 53213

ALL WORK TO BE COMPLETED AS SHOWN, AND IN ACCORDANCE WITH THE LATEST EDITION OF THE MSI GENERAL MASTER SPECIFICATION

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	Architect:	Engineer:	Reviewed B
	BJZ		AMH
	Sheet Title:		
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ISSUE DATES: XX/XX/XXXX XX/XX/XXXX XX/XX/XXXX XX/XX/XXXX State Submittal / Permit: XX/XX/XXXX ITY SUBMITTAL

REVISIONS:

12. ALL EXISTING UTILITIES TO BE FIELD LOCATED AND FLAGGED BY CONTRACTOR. 13. ANY SANITARY SEWER, SANITARY SEWER SERVICES, WATER MAIN, WATER SERVICES, STORM SEWER, OR OTHER UTILITIES, WHICH ARE TO REMAIN, THAT ARE DAMAGED BY THE CONTRACTORS, SHALL BE

14. CONTRACTOR SHALL NOTIFY JSD OF ANY ROOF LEADERS AND/OR STORM DRAIN LINES ENCOUNTERED DURING DEMOLITION WHICH ARE NOT SHOWN ON THE PLANS PRIOR TO ABANDONMENT OR REMOVAL. 15. CONTRACTOR IS RESPONSIBLE FOR SITE SAFETY DURING THE CONSTRUCTION OF THESE

**DEMOLITION NOTES** 

1. THE CONTRACTOR IS RESPONSIBLE FOR DEMOLITION, REMOVAL, AND DISPOSAL (IN A LOCATION APPROVED BY ALL GOVERNING AUTHORITIES) OF ALL STRUCTURES, PADS, WALLS, FLUMES, FOUNDATIONS, PARKING, DRIVES, DRAINAGE STRUCTURES, UTILITIES, ETC., IN A LAWFUL MANNER, SUCH THAT THE IMPROVEMENTS SHOWN ON THE REMAINING PLANS CAN BE CONSTRUCTED. ALL FACILITIES TO BE REMOVED SHALL BE UNDERCUT TO SUITABLE MATERIAL AND BROUGHT TO GRADE WITH SUITABLE COMPACTED FILL MATERIAL PER THE SPECIFICATIONS. THE CONTRACTOR IS

2. THE CONTRACTOR SHALL COORDINATE WITH RESPECTIVE UTILITY COMPANIES PRIOR TO THE REMOVAL AND/OR RELOCATION OF UTILITIES. THE CONTRACTOR SHALL COORDINATE WITH THE UTILITY COMPANY CONCERNING PORTIONS OF WORK WHICH MAY BE PERFORMED BY THE UTILITY COMPANY'S FORCES AND ANY FEES WHICH ARE TO BE PAID TO THE UTILITY COMPANY FOR THEIR SERVICES. THE CONTRACTOR IS RESPONSIBLE FOR PAYING FOR ALL FEES AND CHARGES.

3. THIS PLAN INDICATES ITEMS ON THE PROPERTY INTENDED FOR DEMOLITION BASED ON THE CURRENT SITE DESIGN THAT HAVE BEEN IDENTIFIED BY A REASONABLE OBSERVATION OF THE EXISTING CONDITIONS THROUGH FIELD SURVEY RECONNAISSANCE, "DIGGER'S HOTLINE" LOCATION, AND GENERAL "STANDARD OF CARE". THERE MAY BE ADDITIONAL ITEMS THAT CAN NOT BE IDENTIFIED BY A REASONABLE ABOVE GROUND OBSERVATION, OF WHICH THE ENGINEER WOULD HAVE NO KNOWLEDGE OR MAY BE A PART OF ANOTHER DESIGN DISCIPLINE. IT IS THE CONTRACTOR'S/BIDDER'S RESPONSIBILITY TO REVIEW THE PLANS, INSPECT THE SITE AND PROVIDE THEIR OWN DUE DILIGENCE TO INCLUDE IN THEIR BID WHAT ADDITIONAL ITEMS, IN THEIR OPINION, MAY BE NECESSARY FOR DEMOLITION. ANY ADDITIONAL ITEMS IDENTIFIED BY THE CONTRACTOR/BIDDER SHALL BE IDENTIFIED IN THE BID AND REPORTED TO THE ENGINEER OF

RECORD. JSD PROFESSIONAL SERVICES, INC. (JSD) TAKES NO RESPONSIBILITY FOR ITEMS ON THE PROPERTY THAT COULD NOT BE LOCATED BY A REASONABLE OBSERVATION OF THE PROPERTY OR

4. ALL PERIMETER EROSION CONTROL DEVICES SHALL BE INSTALLED PRIOR TO THE START OF DEMOLITION ACTIVITIES. CONTRACTOR SHALL KEEP ALL STREETS, PRIVATE DRIVES AND PAVEMENT FREE AND CLEAR OF ALL CONSTRUCTION RELATED DIRT, DUST AND DEBRIS.

5. CONTRACTOR TO MAINTAIN CONTINUOUS ACCESS TO SURROUNDING PROPERTIES AND REMAINING PARTS OF THE EXISTING BUILDING AT ALL TIMES DURING THE DEMOLITION PHASE OF THE PROJECT.

6. ALL TREES WITHIN THE CONSTRUCTION LIMITS SHALL BE REMOVED UNLESS SPECIFICALLY CALLED OUT FOR PROTECTION. ALL TREES TO BE REMOVED SHALL BE REMOVED IN THEIR ENTIRETY AND

7. PERFORM TREE PRUNING IN ALL LOCATIONS WHERE PROPOSED PAVEMENT AND/OR UTILITY INSTALLATION ENCROACH WITHIN THE EXISTING DRIP LINE OF THE TREES TO REMAIN. ALL

8. ALL LIGHT POLES TO BE REMOVED SHALL BE REMOVED IN THEIR ENTIRETY, INCLUDING BASE AND ALL APPURTENANCES. SALVAGE FOR RELOCATION. COORDINATE RELOCATION AND/OR ABANDONMENT

10. VOIDS LEFT BY ANY ITEM REMOVED UNDER ANY PROPOSED PAVEMENT, WALK, ETC. OR

WITHIN 24" THEREOF SHALL BE FILLED AND BACKFILLED WITH GRANULAR MATERIALS AND

11.1. EXAMINE ALL SITE CONDITIONS RELATIVE TO THE CONDITIONS INDICATED ON THE ENGINEERING

11.2. VERIFYING UTILITY ELEVATIONS AND NOTIFYING THE DESIGN ENGINEER OF ANY DISCREPANCIES.

11.4. NOTIFYING THE DESIGN ENGINEER AND LOCAL CONTROLLING MUNICIPALITY 48 HOURS PRIOR

11.5. PERFORMING UTILITY LOCATE OBSERVATIONS (ULO) ON ALL UTILITY CROSSINGS. CONTRACTOR

NO WORK SHALL BE PERFORMED UNTIL THE DISCREPANCIES ARE RESOLVED.

11.3. NOTIFYING ALL UTILITIES PRIOR TO THE REMOVAL OF ANY UNDERGROUND UTILITIES.

DRAWINGS. ANY DISCREPANCIES ARE TO BE REPORTED IMMEDIATELY TO THE DESIGN ENGINEER

TO THE START OF CONSTRUCTION TO ARRANGE FOR APPROPRIATE CONSTRUCTION

TO REPORT ANY PLAN DISCREPANCIES OR CONFLICTS PRIOR TO THE START OF UTILITY

CONSTRUCTION. CONTRACTOR SHALL BE RESPONSIBLE FOR COORDINATION WITH THE

OF ALL ELECTRIC LINES WITH ELECTRICAL ENGINEER AND OWNER PRIOR TO DEMOLITION.

9. ABANDONED/REMOVED ITEMS SHALL BE DISPOSED OF OFF SITE UNLESS OTHERWISE NOTED.

BY REPUTABLE TREE PRUNING SERVICE PRIOR TO ANY TRANSVERSE TRENCHING.

TRENCHING WITHIN THE EXISTING DRIP LINE OF THE TREES TO REMAIN SHALL BE DONE RADIALLY AWAY FROM THE TRUNK IF ROOTS IN EXCESS OF 1" DIAMETER ARE EXPOSED. ROOTS MUST BE CUT

RESPONSIBLE FOR OBTAINING ALL PERMITS REQUIRED FOR DEMOLITION AND DISPOSAL.

COORDINATION REQUIRED PRIOR TO CONSTRUCTION.

OF WHICH THEY WOULD HAVE NO KNOWLEDGE.

STUMPS SHALL BE GROUND TO PROPOSED SUBGRADE.

11. PRIOR TO CONSTRUCTION, THE CONTRACTOR IS RESPONSIBLE FOR:

AND RESOLVED PRIOR TO THE START OF CONSTRUCTION.

APPROPRIATE UTILITY COMPANIES TO CONDUCT ULO'S.

REPAIRED TO THE OWNER'S SATISFACTION AT THE CONTRACTOR'S EXPENSE.

COMPACTED PER SPECIFICATIONS.

16. ALL DEMOLITION SHALL BE IN ACCORDANCE WITH THE APPROVED MUNICIPALITY RECYCLING PLAN.

17. ANY CONTAMINATED SOILS SHALL BE REMOVED IN ACCORDANCE WITH FEDERAL AND STATE REGULATIONS TO AN APPROVED LANDFILL. 18. EXISTING FIBER OPTIC LINE(S) TO BE CLEARLY MARKED PRIOR TO ANY EXCAVATION. CONTRACTOR

TO NOTIFY THE DESIGN ENGINEER IMMEDIATELY IF ANY DISCREPANCIES OCCUR IN THE LOCATION SHOWN OR PROPOSED IMPROVEMENTS IMPACTING EXISTING FIBER OPTIC LINE(S) LOCATION(S).

19. CONTRACTOR TO REMOVE EXISTING UTILITY PIPE/CONDUITS WITHIN BUILDING FOOTPRINT AND BACKFILL WITH MATERIALS PER GEOTECHNICAL REPORT.

20. CONTRACTOR MAY LIMIT SAW-CUT AND PAVEMENT REMOVAL TO ONLY THOSE AREAS WHERE IT IS REQUIRED AS SHOWN ON THESE CONSTRUCTION PLANS BUT IF ANY DAMAGE IS INCURRED ON ANY OF THE SURROUNDING PAVEMENT, CURB, SIDEWALK, ETC. THE CONTRACTOR SHALL BE RESPONSIBLE FOR IT'S REMOVAL AND REPAIR. DAMAGE TO ALL EXISTING CONDITIONS TO REMAIN WILL BE REPLACED AT CONTRACTOR'S EXPENSE.

21. RESTORATION OF THE EXISTING ROADWAY RIGHT-OF-WAYS ARE CONSIDERED INCIDENTAL AND SHOULD BE PART OF THE COST OF THE UNDERGROUND IMPROVEMENTS, DEMOLITION AND REMOVAL. THIS INCLUDES CURB & GUTTER, SIDEWALK, TOPSOIL, SEEDING AND MULCHING.


22. PROPOSED REMOVALS AND WORK IS SHOWN IN THE CITY RIGHT OF WAY. THE CONTRACTOR WILL NEED TO OBTAIN A CONSTRUCTION PERMIT PRIOR TO STARTING WORK.

23. ALL WORK WITHIN THE PUBLIC RIGHT OF WAY REQUIRES A STREET OCCUPANCY PERMIT FROM THE

----- SAN ----- SANITARY SEWER LIGHT POLE TELEPHONE PEDESTAL ST STORM SEWER ELECTRICAL MANHOLE ----RD-----ROOF DRAIN POWER POLE --- GUY WIRE SANITARY SEWER MANHOLE STORM MANHOLE CATCH BASIN ROUND CATCH BASIN SQUARE CONIFEROUS TREE ₩ WATER VALVE

C-400 DETAILS



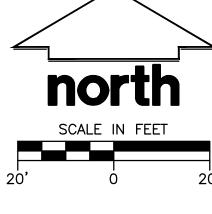









**DEMOLITION LEGEND/KEY** 

PROTECT UTILITY

STORM INLET -

(PER PLAN)

RIM 95.90'

ELECTRIC BOX TO BE

REMOVED AND RELOCATED. CONTRACTOR SHALL

COORDINATE W/ UTILITY

REMOVED AND RELOCATED.

GAS METERS TO BE-

S 88°58'14"

COMPANY

GAS SERVICE TO BE REMOVED AND RELOCATED.

CONTRACTOR SHALL COORDINATE W/ UTILITY

ELECTRIC LINE TO BE

CONTRACTOR SHALL

BASKETBALL -

REMOVED AND RELOCATED.

COORDINATE W/ UTILITY

CONTRACTOR SHALL

COORDINATE W/ UTILITY

15" NW 81.00' INV.

10" SE 81.07' INV.

10" SW 89.75' INV.

Existing Building

Lot Area

53,394 sq. ft.

STORM INLET -

(PER PLAN) RIM 96.15'

10" NE 90.50' INV.

10" SE 90.50' INV.

- *--103-*

-104-

-105—

8" PVC SW 103.40' INV.

8" PVC NE 104.48' INV.

Asphalt Parking Lot

STRUCTURE (TYP.)

REMOVE

EXISTING

PAVEMENT

-ELECTRIC SERVICE TO BE

REMOVED AND RELOCATED. CONTRACTOR SHALL

COORDINATE W/ UTILITY

ASPHALT

PROTECT UTILITY

STRUCTURE (TYP.)

- REMOVE EXISTING

STORM CLEANOUT

₩ REMOVE

RETAINING

EXISTING

VEGETATION <sup>\</sup>

- REMOVE EXISTING

GUARD RAIL

AND FENCE

STORM SEWER

EXISTING ASPHALT PAVEMENT AND BASE TO BE REMOVED EXISTING FEATURE TO BE REMOVED REMOVE/ABANDON EXISTING UTILITIES SAWCUT EXISTING PAVEMENT PROTECT UTILITY STRUCTURE EXISTING VEGETATION TO BE


REMOVE UTILITY STRUCTURE

T UNDERGROUND TELEPHONE ----- FIB ----- UNDERGROUND FIBER OPTICS DECIDUOUS TREE

**CIVIL SHEET INDEX** 

C-100 DEMOLITION PLAN C-200 SITE PLAN C-300 GRADING AND EROSION CONTROL PLAN

THE EXISTING CONDITIONS SURVEY PROVIDED BY CLIENT, JSD PROFESSIONAL SERVICES MAKES NO GUARANTEE ON THE ACCURACY OF THE SURVEY

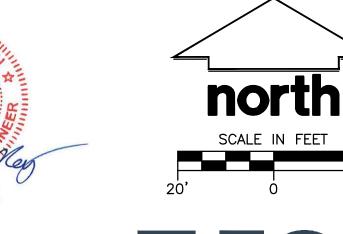

CITY/ STATE / ZIP Wauwatosa, WI 53213 ALL WORK TO BE COMPLETED AS SHOWN, AND IN ACCORDANCE WITH THE LATEST EDITION OF THE MSI GENERAL MASTER SPECIFICATION RWI DEMOLITION PLAN Sheet Number: C-100

P13329

ARCHITECTS

WAUWATOSA

PROJECT ADDRESS:

St. John's Evangelical Lutheran School

PROJECT NAME

STREET ADDRESS

1278 Dewey Ave.

JSD PROJ. MGR.: RWI (I) DEMOLITION PLAN 1"=20'-0"

DRAFT - NOT FOR CONSTRUCTION

OCONOMOWOC, WI 53066

PHONE: 262-367-3661

PROJECT ADDRESS:

St. John's Evangelical Lutheran School

ALL WORK TO BE COMPLETED AS SHOWN, AND IN

ACCORDANCE WITH THE LATEST EDITION OF THE

Reviewed By:

RWI

ARCHITECTS

MSI GENERAL MASTER SPECIFICATION

APM

SITE PLAN

Sheet Number:

C-200

P13329

PROJECT NAME

STREET ADDRESS 1278 Dewey Ave. CITY/ STATE / ZIP


Wauwatosa, WI 53213

17. LIMITS OF FINAL CITY STREET PAVEMENT AND CURB AND GUTTER REMOVAL AND REPLACEMENTS TO 18. PROPOSED PAVEMENT RESTORATION LIMITS IN CITY STREET FOR DRIVEWAY APPROACH REMOVALS ARE SHOWN ARE MINIMUM AREAS. THE CITY REQUIRES PAVEMENT PATCHES TO BE WIDTH TO MATCH 19. ALL WORK WITHIN THE PUBLIC RIGHT OF WAY REQUIRES A STREET OCCUPANCY PERMIT FROM THE

BIKE PARKING STALLS - 6


	LL	<u>JLIND</u>			
S	SANITARY SEWER MANHOLE		- SAN -		SANITARY SEWER
ST	STORM MANHOLE		W		WATER MAIN
$\bigoplus$	CATCH BASIN ROUND		— ST —		STORM SEWER
$\blacksquare$	CATCH BASIN SQUARE		—RD		ROOF DRAIN
A	FIRE HYDRANT		——G——		UNDERGROUND GAS
M	WATER VALVE		—Е—		UNDERGROUND ELECTRIC
	GAS VALVE		—т—		UNDERGROUND TELEPHONE
¤	LIGHT POLE		– FIB –		UNDERGROUND FIBER OPTIC
T	TELEPHONE PEDESTAL		— ОН —		OVERHEAD UTILITY
E	ELECTRICAL MANHOLE	-	—— SF——		SILT FENCE
	SIGN		Z.	CONIF	FEROUS TREE
Ø	POWER POLE		The state of the s		··· <del></del>
			کی ک		



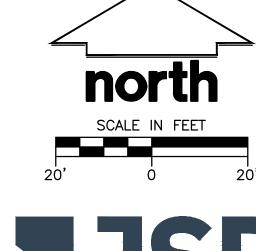



Hearing Impaired TDD (800) 542-2289 www.DiggersHotline.com SITE PLAN 1"=20'-0"

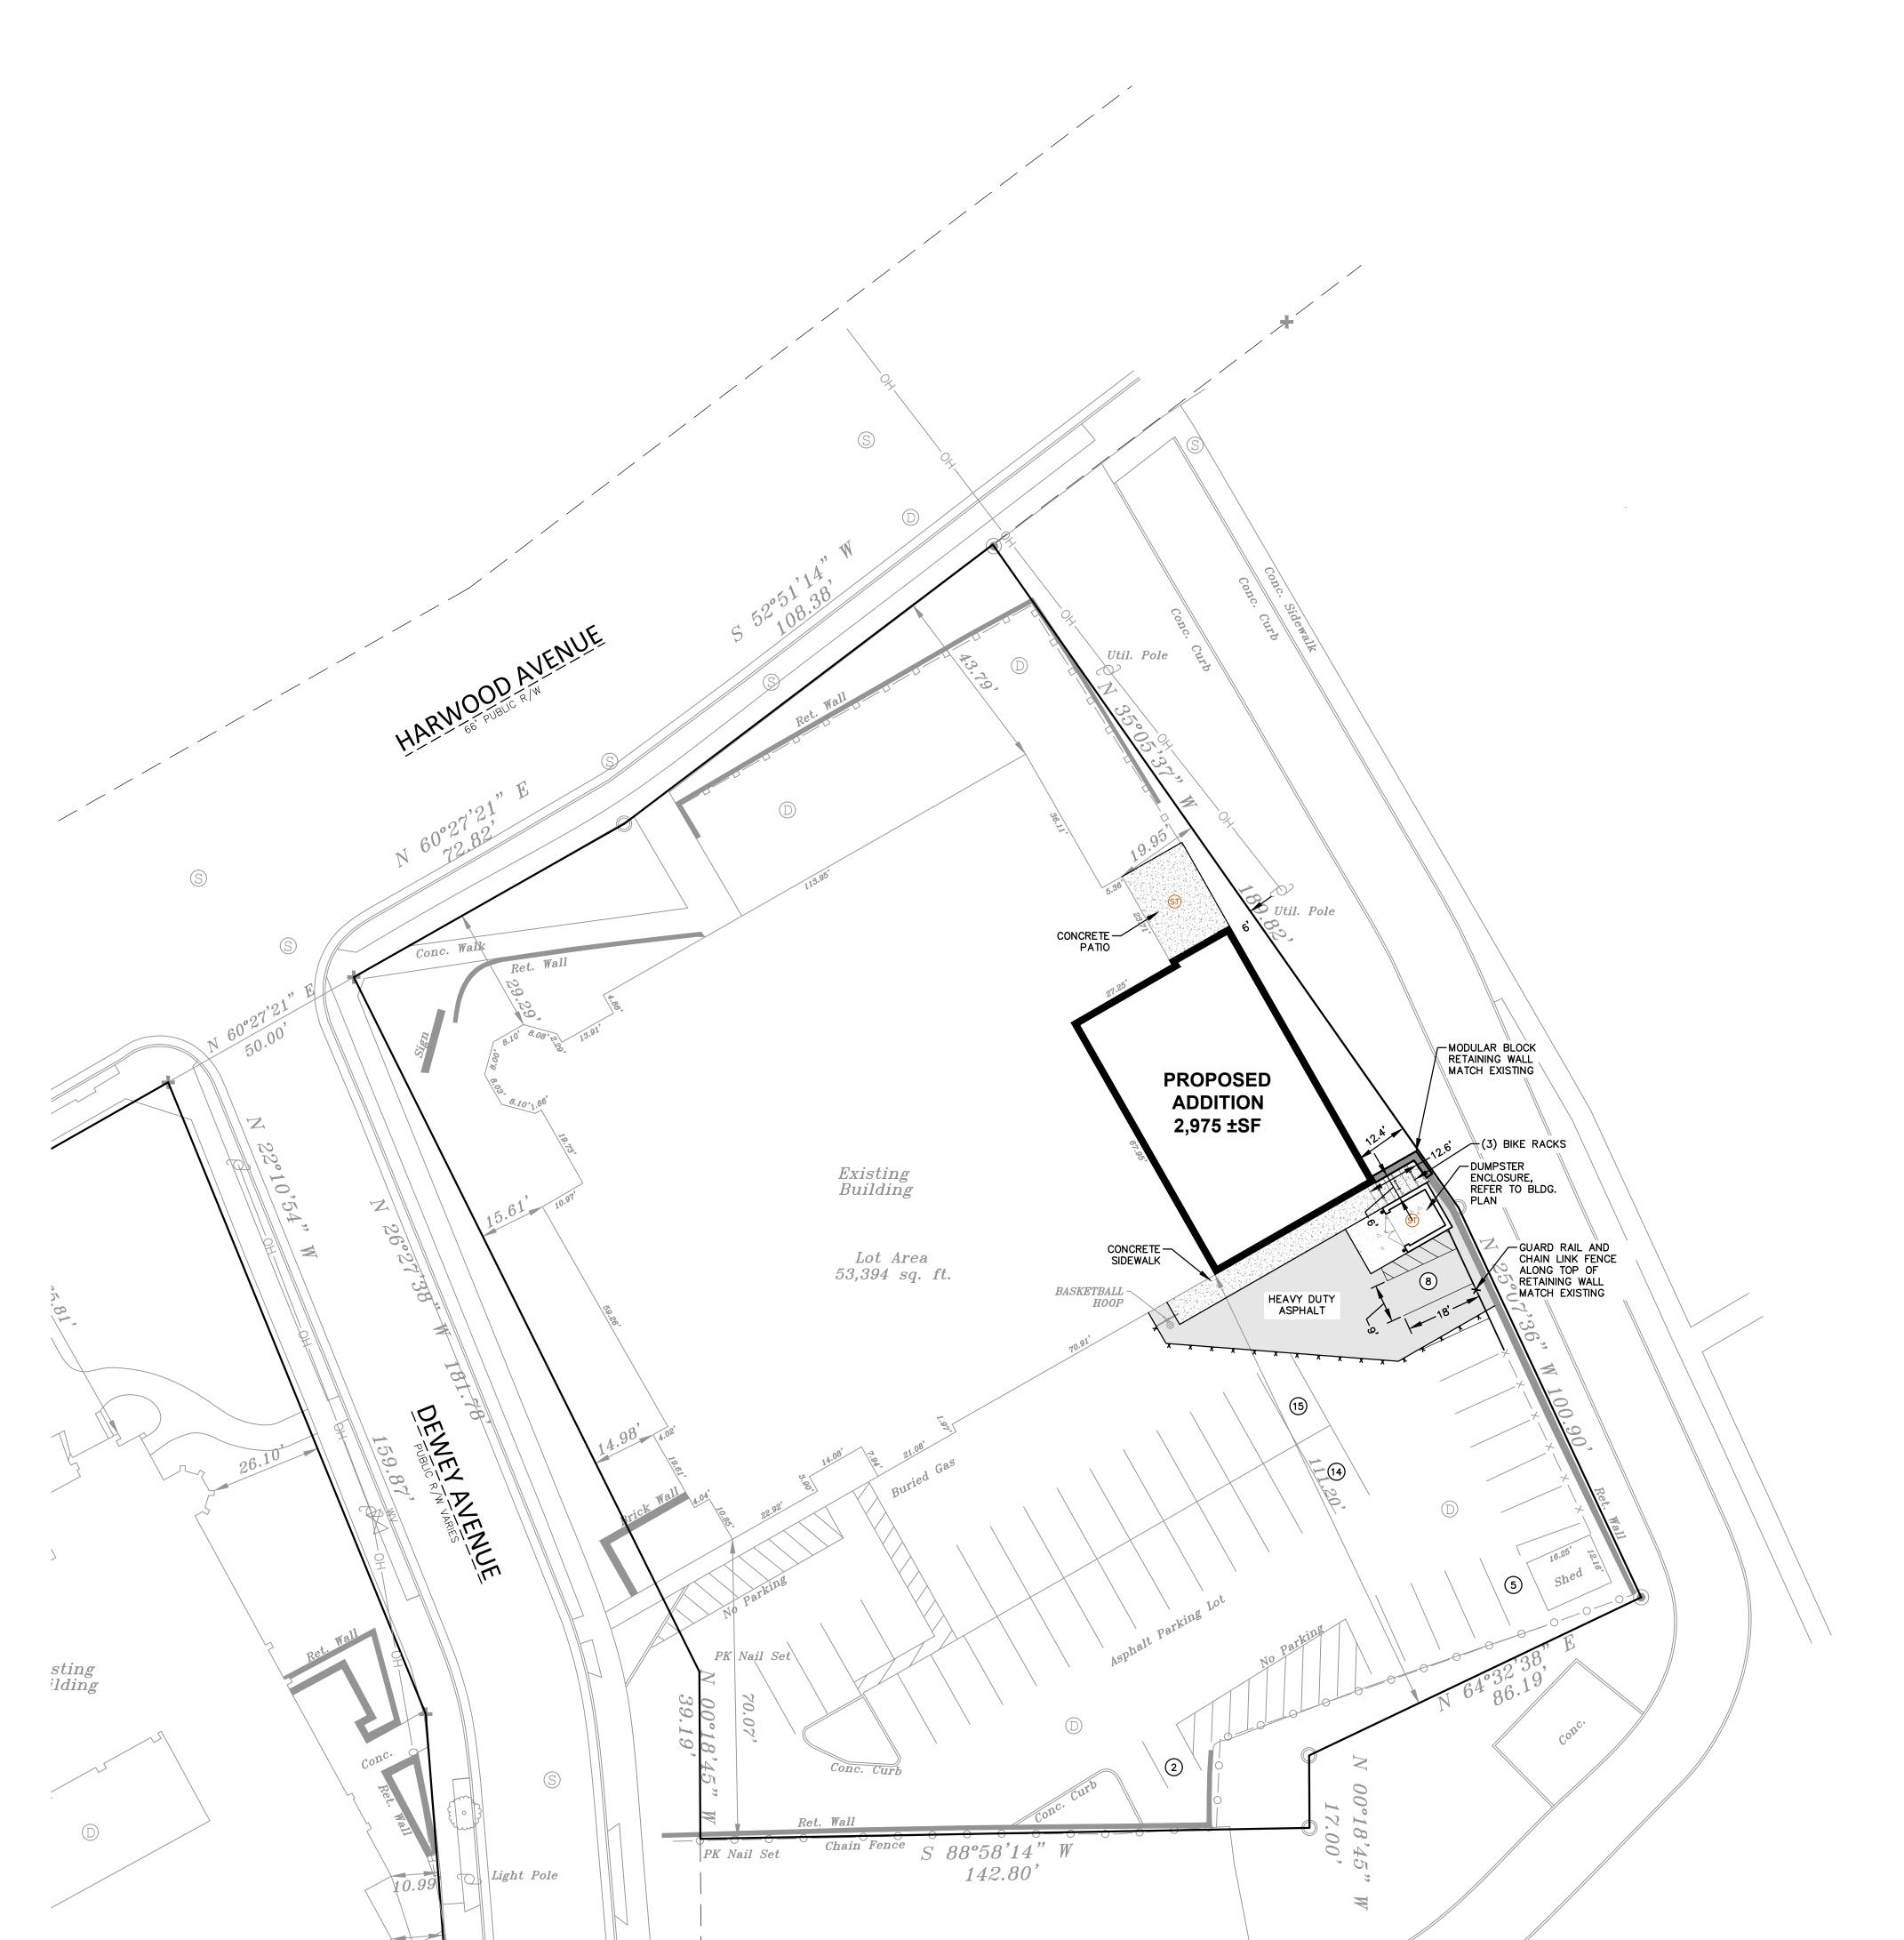

Asphalt Parking Lot

#### **PAVING NOTES**

2. CONCRETE PAVING SPECIFICATIONS-

- 1. ALL PAVING SHALL CONFORM TO "STATE OF WISCONSIN STANDARD SPECIFICATIONS FOR HIGHWAY & 1. THE INTENTION OF THE PLANS AND SPECIFICATIONS IS TO SET FORTH PERFORMANCE AND STRUCTURE CONSTRUCTION AND APPLICABLE CITY OF WAUWATOSA ORDINANCES. CONSTRUCTION MATERIAL STANDARDS FOR THE PROPER EXECUTION OF WORK. ALL WORKS CONTAINED STRUCTURE CONSTRUCTION AND APPLICABLE CITY OF WAUWATOSA ORDINANCES.
- CODES AND STANDARDS THE PLACING, CONSTRUCTION AND COMPOSITION OF THE CONCRET PAVEMENT SHALL BE IN ACCORDANCE WITH THE REQUIREMENTS OF SECTIONS 415 AND 416 OF THE 2. THE CONTRACTOR IS RESPONSIBLE FOR PERFORMING ANY ADDITIONAL SOILS INVESTIGATIONS THEY STATE OF WISCONSIN STANDARD SPECIFICATIONS FOR HIGHWAY AND STRUCTURE CONSTRUCTION, FEEL IS NECESSARY FOR THE PROPER EVALUATION OF THE SITE FOR PURPOSES OF PLANNING, CURRENT EDITION. HEREAFTER, THIS PUBLICATION WILL BE REFERRED TO AS STATE HIGHWAY
- CRUSHED AGGREGATE BASE COURSE THE BASE COURSE SHALL CONFORM TO SECTIONS 301 AND 305, STATE HIGHWAY SPECIFICATIONS. CLEAN RECYCLED CRUSHED CONCRETE MAY BE USED IF APPROVED BY GEOTECH ENGINEER OF RECORD.
- SURFACE PREPARATION NOTIFY CONTRACTOR OF UNSATISFACTORY CONDITIONS. DO NOT BEGIN PAVING WORK UNTIL DEFICIENT SUBBASE AREAS HAVE BEEN CORRECTED AND ARE READY TO RECEIVE
- 3. ASPHALTIC CONCRETE PAVING SPECIFICATIONS-
- CODES AND STANDARDS THE PLACING, CONSTRUCTION AND COMPOSITION OF THE ASPHALTIC BASE COURSE AND ASPHALTIC CONCRETE SURFACING SHALL BE IN ACCORDANCE WITH THE REQUIREMENTS OF SECTIONS 450, 455, 460 AND 465 OF THE STATE OF WISCONSIN STANDARD SPECIFICATIONS FOR HIGHWAY AND STRUCTURE CONSTRUCTION, EDITION OF 2005. HEREAFTER, THIS PUBLICATION WILL BE REFERRED TO AS STATE HIGHWAY SPECIFICATIONS.
- WEATHER LIMITATIONS APPLY TACK COATS WHEN AMBIENT TEMPERATURE IS ABOVE 50° F (10° C) AND WHEN TEMPERATURE HAS NOT BEEN BELOW 35° F (1° C) FOR 12 HOURS IMMEDIATELY PRIOR TO APPLICATION. DO NOT APPLY WHEN BASE IS WET OR CONTAINS EXCESS AMOUNTS OF MOISTURE. CONSTRUCT ASPHALTIC CONCRETE SURFACE COURSE WHEN ATMOSPHERIC TEMPERATURE IS ABOVE 40° F (4° C) AND WHEN BASE IS DRY AND WHEN WEATHER IS NOT RAINY. BASE COURSE MAY BE PLACED WHEN AIR TEMPERATURE IS ABOVE 30° F  $(-1^{\circ}$  C).
- GRADE CONTROL ESTABLISH AND MAINTAIN REQUIRED LINES AND ELEVATIONS FOR EACH COURSE CRUSHED AGGREGATE BASE COURSE - THE TOP LAYER OF BASE COURSE SHALL CONFORM TO SECTIONS 301 AND 305, STATE HIGHWAY SPECIFICATIONS. CLEAN RECYCLED CRUSHED CONCRETE MAY

  9. SHOULD ANY DISCREPANCIES OR CONFLICTS IN THE PLANS OR SPECIFICATIONS BE DISCOVERED AFTER
  BE USED IF APPROVED BY GEOTECH ENGINEER OF RECORD.

  9. SHOULD ANY DISCREPANCIES OR CONFLICTS IN THE PLANS OR SPECIFICATIONS BE DISCOVERED AFTER
  THE AWARD OF CONTRACT, ENGINEER SHALL BE NOTIFIED IN WRITING IMMEDIATELY AND CONSTRUCTION
- BINDER COURSE AGGREGATE THE AGGREGATE FOR THE BINDER COURSE SHALL CONFORM TO SECTIONS 460.2.7 AND 315, STATE HIGHWAY SPECIFICATIONS. SURFACE COURSE AGGREGATE - THE AGGREGATE FOR THE SURFACE COURSE SHALL CONFORM TO SECTIONS 460.2.7 AND 465, STATE HIGHWAY SPECIFICATIONS.
- SURFACE PREPARATION NOTIFY CONTRACTOR OF UNSATISFACTORY CONDITIONS. DO NOT BEGIN PAVING WORK UNTIL DEFICIENT SUBBASE AREAS HAVE BEEN CORRECTED AND ARE READY TO RECEIVE

ASPHALTIC MATERIALS - THE ASPHALTIC MATERIALS SHALL CONFORM TO SECTION 455 AND 460,

## **PAVEMENT STRIPING NOTES**

- 1. CONTRACTOR SHALL CONSULT STRIPING COLOR WITH OWNER PRIOR TO CONSTRUCTION.
- 2. PROVIDE CONTRACTOR GRADE ACRYLIC, STRIPING PAINT FOR NEW ASPHALT OR COATED ASPHALT. ALL STRIPING SHALL BE APPLIED IN ACCORDANCE WITH MANUFACTURER'S SPECIFICATIONS. 3. THOROUGHLY CLEAN SURFACES FREE OF DIRT, SAND, GRAVEL, OIL AND OTHER FOREIGN MATTER.
- CONDITION THROUGH NORMAL PREPARATORY WORK AS SPECIFIED. 4. DO NOT PLACE MARKING OVER UNSOUND PAVEMENTS. IF THESE CONDITIONS EXIST, NOTIFY OWNER. STARTING INSTALLATION CONSTITUTES CONTRACTOR'S ACCEPTANCE OF SURFACE AS SUITABLE FOR

PROFESSIONALLY MADE TO INDUSTRY STANDARDS. "FREE HAND" PAINTING OF ARROWS, SYMBOLS, OR

CONTRACTOR RESPONSIBLE TO INSPECT PAVEMENT SURFACES FOR CONDITIONS AND DEFECTS THAT WILL ADVERSELY AFFECT QUALITY OF WORK, AND WHICH CANNOT BE PUT INTO AN ACCEPTABLE

- 5. LAYOUT MARKINGS USING GUIDE LINES, TEMPLATES AND FORMS. STENCILS AND TEMPLATES SHALL BE
- WORDING SHALL NOT BE ALLOWED. APPLY STRIPES STRAIGHT AND EVEN. 6. PROTECT ADJACENT CURBS, WALKS, FENCES, AND OTHER ITEMS FROM RECEIVING PAINT.
- 7. APPLY MARKING PAINT AT A RATE OF ONE (1) GALLON PER THREE TO FOUR HUNDRED (300-400) LINEAL FEET OF FOUR (4) INCH WIDE STRIPES. (OR TO MFG. SPECIFICATIONS)
- 8. BARRICADE MARKED AREAS DURING INSTALLATION AND UNTIL THE MARKING PAINT IS DRIED AND READY
- 9. ALL HANDICAPPED ACCESSIBLE PARKING SHALL BE LOCATED PER 2009 IBC 1106.6

#### **PAVEMENT THICKNESS NOTES**

ALL PAVING SHALL CONFORM TO "STATE OF WISCONSIN STANDARD SPECIFICATIONS FOR HIGHWAY & STRUCTURE CONSTRUCTION — CURRENT EDITION AND ADDENDUM, APPLICABLE CITY OF WAUWATOSA ORDINANCES, AND THE GEOTECHNICAL ENGINEERING SERVICES REPORT PREPARED BY CGC INC., DATED

#### \*\* FINAL PAVEMENT DESIGN TO BE DETERMINED BY OWNER BASED ON GEOTECHNICAL ENGINEER OF RECORD RECOMMENDATIONS. ALL PAVING SHALL BE PERFORMED IN ACCORDANCE WITH THE GEOTECHNICAL ENGINEER OF RECORDS RECOMMENDATIONS AS SPECIFIED IN THE SAID GEOTECHNICAL REPORT. MINIMUM PAVEMENT STRUCTURE

8" CONCRETE W/ MESH REINFORCEMENT 6" CRUSHED AGGREGATE BASE COURSE (1-1/4" DENSE GRADED LIMESTONE) CLEAN RECYCLED CRUSHED CONCRETE MAY BE USED IF APPROVED BY GÉOTECH ENGINEER OF RECORD.

CONCRETE PAVEMENT (TRASH PAD)

HEAVY DUTY ASPHALT PAVEMENT 4-1/2" ASPHALTIC CONCRETE (2 LIFTS, 3" BINDER, 1-1/2" SURFACE) LOWER LAYER (2.25 BINDER, 4LT 58.28 S) UPPER LAYER (1.75" SURFACE, 5LT 58.28 S) 11" CRUSHED AGGREGATE BASE COURSE (1-1/4" DENSE GRADED LIMESTONE) CLEAN RECYCLED CRUSHED CONCRETE MAY BE USED IF APPROVED BY GEOTECH ENGINEER OF RECORD.

5" CONCRETE

CONCRETE SIDEWALK, PATIO, AND STOOPS 6" CRUSHED AGGREGATE BASE COURSE CLEAN RECYCLED CRUSHED CONCRETE MAY BE USED IF APPROVED BY GEOTECH ENGINEER OF RECORD.

PRE-DEVELOPMENT (PROPERTY\* LIMIT): PERVIOUS - 10,316 SF (19.3% GREEN SPACE)

IMPERVIOUS - 43,078 SF POST-DEVELOPMENT-THIS PHASE (PROPERTY\* LIMIT): PERVIOUS - 10,957 SF (20.5% GREEN SPACE) IMPERVIOUS - 42,437 SF

\* PROPERTY BASED ON SURVEY BY OTHER.

**GENERAL NOTES AND SPECIFICATIONS** 

WITHIN THE PLANS AND SPECIFICATIONS SHALL BE COMPLETED IN ACCORDANCE WITH ALL REQUIREMENTS FROM LOCAL, STATE, FEDERAL OR OTHER GOVERNING AGENCY'S LAWS, REGULATIONS,

3. THE CONTRACTOR IS RESPONSIBLE TO REVIEW AND UNDERSTAND ALL COMPONENTS OF THE PLANS

AND SPECIFICATIONS, INCLUDING FIELD VERIFYING SOIL CONDITIONS, PRIOR TO SUBMISSION OF A BID

THE CONTRACTOR SHALL PROMPTLY REPORT ANY ERRORS OR AMBIGUITIES DISCOVERED AS PART OF

5. THE CONTRACTOR IS SOLELY RESPONSIBLE FOR THE COMPUTATION OF QUANTITIES AND WORK REQUIRED TO COMPLETE THIS PROJECT. THE CONTRACTOR'S BID SHALL BE BASED ON THEIR OWN

6. QUESTIONS/CLARIFICATIONS WILL BE INTERPRETED BY ENGINEER/OWNER PRIOR TO THE AWARD OF CONTRACT. ENGINEER/OWNER WILL SUBMIT OFFICIAL RESPONSES IN WRITING. INTERPRETATIONS

PRIOR TO START OF WORK, CONTRACTOR SHALL BE COMPLETELY FAMILIAR WITH ALL CONDITIONS (

THE SITE, AND SHALL ACCOUNT FOR CONDITIONS THAT AFFECT, OR MAY AFFECT CONSTRUCTION

INCLUDING, BUT NOT LIMITED TO, LIMITATIONS OF WORK ACCESS, SPACE LIMITATIONS, OVERHEAD

OBSTRUCTIONS. TRAFFIC PATTERNS, LOCAL REQUIREMENTS, ADJACENT ACTIVITIES, ETC. FAILURE TO

B. COMMENCEMENT OF CONSTRUCTION SHALL EXPLICITLY CONFIRM THAT THE CONTRACTOR HAS REVIEWED THE PLANS AND SPECIFICATIONS IN THEIR ENTIRETY AND CERTIFIES THAT THEIR SUBMITTED BID PROPOSAL CONTAINS PROVISIONS TO COMPLETE THE PROJECT, WITH THE EXCEPTION OF UNFORESEEN

FIELD CONDITIONS; ALL APPLICABLE PERMITS HAVE BEEN OBTAINED; AND CONTRACTOR UNDERSTANDS

OF ITEMS AFFECTED BY THE DISCREPANCIES/CONFLICTS SHALL NOT COMMENCE, OR CONTINUE, UNTIL

BETWEEN REFERENCED CODES, STANDARDS, SPECIFICATIONS AND PLANS, THE ONE ESTABLISHING THE

COMPLETE THE PROJECT. OBTAINING PERMITS, OR DELAYS IN OBTAINING PERMITS, IS NOT CAUSE FOR

DELAY OF THE CONTRACT OR SCHEDULE. CONTRACTOR SHALL COMPLY WITH ALL PERMIT

A WRITTEN RESPONSE FROM ENGINEER/OWNER IS DISTRIBUTED. IN THE EVENT OF A CONFLICT

10. THE CONTRACTOR SHALL, AT ITS OWN EXPENSE, OBTAIN ALL NECESSARY PERMITS AND LICENSES TO

11. THE CONTRACTOR SHALL NOTIFY ALL INTERESTED GOVERNING AGENCIES, UTILITY COMPANIES AFFECTED

12. SAFETY IS THE SOLE RESPONSIBILITY OF THE CONTRACTOR. THE CONTRACTOR SHALL BE RESPONSIBLE

13. CONTRACTOR SHALL KEEP THE JOBSITE CLEAN AND ORDERLY AT ALL TIMES. ALL LOCATIONS OF THE SITE SHALL BE KEPT IN A WORKING MANNER SUCH THAT DEBRIS IS REMOVED CONTINUOUSLY AND

14. THE CONTRACTOR SHALL INDEMNIFY THE OWNER, JSD, AND THEIR AGENTS FROM ALL LIABILITY

INVOLVED WITH THE CONSTRUCTION, INSTALLATION, AND TESTING OF THE WORK ON THIS PROJECT.

ALL RESPECTIVE CONTRACTORS OPERATE UNDER GENERAL "GOOD HOUSEKEEPING."

TO INITIATE, INSTITUTE, ENFORCE, MAINTAIN, AND SUPERVISE ALL SAFETY PRECAUTIONS AND JOB SITE

BY THIS CONSTRUCTION PROJECT, AND "DIGGER'S HOTLINE" IN ADVANCE OF CONSTRUCTION TO

COMPLY WITH ALL JURISDICTIONAL ORDINANCES/CODES/RULES/ETC., PERMIT STIPULATIONS, AND OTHER APPLICABLE STANDARDS. CONTRACTOR IS RESPONSIBLE TO DETERMINE WHICH

PRESENTED IN OFFICIAL RESPONSES SHALL BE BINDING ON ALL PARTIES ASSOCIATED WITH THE CONTRACT. IN NO WAY SHALL WORD-OF-MOUTH DIALOG CONSTITUTE AN OFFICIAL RESPONSE.

COMPUTATIONS AND UNDER NO CIRCUMSTANCES BE BASED ON THE ENGINEER'S ESTIMATE.

JURISDICTIONAL ORDINANCES/CODES/RULES/ETC., AND THE OWNER'S DIRECTION.

THEIR REVIEW OF PLANS, SPECIFICATIONS, REPORTS AND FIELD INVESTIGATIONS.

CONSIDER SITE CONDITIONS SHALL NOT BE CAUSE FOR CLAIM OF JOB EXTRAS.

ALL OF THE REQUIREMENTS OF THE PROJECT.

MOST STRINGENT REQUIREMENTS SHALL BE FOLLOWED.

ORDINANCES/CODES/RULES/ETC. ARE APPLICABLE.

SAFETY PROGRAMS IN CONNECTION WITH THE WORK.

DAYS PRIOR TO WORK IN CITY RIGHT OF WAY.


LENGTH, OR TO CENTERLINE OF STREET.

BE MARKED BY CITY ENGINEERING STAFF IN FIELD.

BIDDING, OR CONSTRUCTING THE PROJECT AT NO ADDITIONAL COST TO THE OWNER.

PRE-DEVELOPMENT ONSITE PARKING STALLS: TOTAL PARKING STALLS - 54 ADA PARKING STALLS - 3 STANDARD PARKING STALLS - 51 POST-DEVELOPMENT ONSITE PARKING STALLS: TOTAL PARKING STALLS - 44 ADA PARKING STALLS - 3 STANDARD PARKING STALLS - 41

# LEGEND

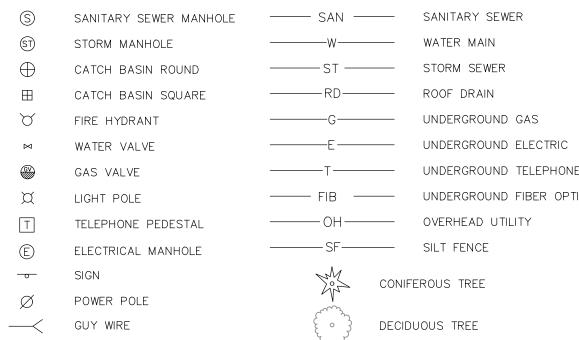





JSD PROJ. MGR.: RWI

CHITE

ALL WORK TO BE COMPLETED AS SHOWN, AND IN ACCORDANCE WITH THE LATEST EDITION OF THE

Engineer: APM **GRADING & EROSION** 

Sheet Number:

## **EROSION AND SEDIMENT CONTROL NOTES**

✓ PROTECTIÓN

STORM MANHOLI

FIRE HYDRANT

GAS VALVE

SIGN

---- GUY WIRE

 $^{-104}-$ 

<sup>-</sup>105—

8" PVC SW 103.40' INV.

**UTILITY NOTES** 

PRIOR TO ANY CONSTRUCTION.

APPROPRIATE LOCAL AND STATE AUTHORITIES.

STATUTES AND CITY OF WAUWATOSA REQUIREMENTS

. EXISTING UTILITIES ARE SHOWN FOR INFORMATIONAL PURPOSES ONLY AND ARE NOT GUARANTEED TO

2. ALL UTILITY WORK SHALL BE DONE IN ACCORDANCE WITH THE STANDARD SPECIFICATIONS FOR SEWER

3. UTILITY CONSTRUCTION AND SPECIFICATIONS SHALL COMPLY WITH THE CITY OF WAUWATOSA MUNICIPAL

4. TRACER WIRES SHALL BE INSTALLED AS NECESSARY IN ACCORD WITH 182.0715(2R) OF THE STATE

5. LENGTHS OF PROPOSED UTILITIES ARE TO CENTER OF STRUCTURES OR FITTINGS AND MAY VARY

SLIGHTLY FROM PLAN. LENGTHS ARE SHOWN FOR CONTRACTOR CONVENIENCE ONLY. CONTRACTOR IS

SOLELY RESPONSIBLE FOR COMPUTATIONS OF MATERIALS REQUIRED TO COMPLETE WORK. LENGTHS

CODE AND WISCONSIN DEPARTMENT OF SAFETY AND PROFESSIONAL SERVICES DSPS 382.

BE ACCURATE OR ALL INCLUSIVE. CONTRACTOR IS RESPONSIBLE FOR VERIFYING THE TYPE, LOCATION,

SIZE AND ELEVATION OF UNDERGROUND UTILITIES AS THEY DEEM NECESSARY FOR PROPOSED UTILITY CONNECTIONS AND/OR TO AVOID DAMAGE THERETO. CONTRACTOR SHALL CALL "DIGGER'S HOTLINE"

AND WATER CONSTRUCTION IN (WISCONSIN LATEST EDITION AND ADDENDUM) AND ALL STATE AND

LOCAL CODES AND SPECIFICATIONS. IT IS THE CONTRACTORS RESPONSIBILITY TO DETERMINE WHICH

SPECIFICATIONS AND CODES APPLY, AND TO COORDINATE ALL CONSTRUCTION ACTIVITIES WITH THE

8" PVC NE 104.48' INV.

Asphalt Parking Lot

POWER POLE

CATCH BASIN SQUARE

TELEPHONE PEDESTAL

ELECTRICAL MANHOLE

————G———— UNDERGROUND GAS

-----OH------OVERHEAD UTILIT

— FIB — UNDERGROUND FIBER OPTICS

CONIFEROUS TREE

DECIDUOUS TREE

BLUEGRASS BLEND SEED

LOCATION AND SLOPE C

EXISTING PIPE IS BASED OFF OF

PLANS. CONTRACTOR TO VERIFY

-LOCATION AND SLOPE PRIOR TO

© 1.04% MIN.

STO BEND-11

I.E. = 93.00

0" - 45' BEND

DISTURBANCE AREA

**@** 6.70%

@ 1.04% MIN.

-PROTECTION

RIM 110.30

101.70 10"SW

98.50 10"NW

INCREASE RETAINING

APPROXIMATELY 1.5'

- WALL HEIGHT

LOCATION AND SLOPE OF EXISTING PIPE IS BASED OFF OF

PLANS, CONTRACTOR TO VERIFY

CONSTRUCTION, CONTACT THE

ENGINEER OF RECORD IF ANY

DISCREPANCY ARE FOUND

BACKFILL AND BEDDING - STORM SEWER SHALL BE CONSTRUCTED WITH GRAVEL BACKFILL AND

CLASS "B" BEDDING IN ALL PAVED AREAS AND TO A POINT 5 FEET BEYOND THE EDGE OF PAVEMENT.

TRENCHES RUNNING PARALLEL TO AND LESS THAN 5 FEET FROM THE EDGE OF PAVEMENT SHALL

ALSO REQUIRE GRAVEL BACKFILL. LANDSCAPED AREAS MAY BE BACKFILLED WITH EXCAVATED MATERIAL

MANHOLE FRAMES AND COVERS - MANHOLE FRAMES AND COVERS SHALL BE NEENAH R-1713 WITH

FIELD TILE CONNECTION - ALL FIELD TILE ENCOUNTERED DURING CONSTRUCTION SHALL BE INCLUDED

IN THE UNIT PRICE(S) FOR STORM SEWER. TILE LINES CROSSED BY THE TRENCH SHALL BE

11. ALL WORK WITHIN THE PUBLIC RIGHT OF WAY REQUIRES A STREET OCCUPANCY PERMIT FROM THE

12. THE PROPOSED STORM SEWER MANHOLE INSTALLATION WITHIN THE CITY RIGHT OF WAY REQUIRES

FULL-TIME INSPECTION. ALL REQUIRED INSPECTION SHALL BE PAID FOR THE DEVELOPMENT.

IN CONFORMANCE WITH SECTION 8.43.5 OF THE "STANDARD SPECIFICATIONS".

TYPE "B" SELF SEALING LIDS, NON-ROCKING OR EQUAL

MAINTAINED BY THE PROPERTY OWNER.

REPLACED WITH THE SAME MATERIAL AS THE STORM SEWER.

LOCATION AND SLOPE PRIOR TO

🐧 230 SQ. FT

CONSTRUCTION CONTACT THE

ENGINEER OF RECORD IF ANY

DISCREPANCY ARE FOUND

**ADDITION** 

FFE MATCH

**EXISTING** 

STO BEND-13

(ASSUMED)

10" FXISTING

STORM SEWER

S @ 1.04% ¯

(ASSUMED)

(MINIMUM) C-76 WITH RUBBER GASKET JOINTS CONFORMING TO ASTO C-443; HIGH DENSITY 9. ALL NEW ON-SITE SANITARY, STORM AND WATER UTILITIES SHALL BE PRIVATELY OWNED AND

M-294 TYPE "S", OR POLYVINYL CHLORIDE (PVC) - CLASS PS46 MEETING AASHTO M278, AS NOTED. 10. NOTIFY CITY PRIOR TO ANY UTILITY WORK IN THE RIGHT OF WAY AND ALL SANITARY SEWER

10" - 45° BEND

10" EXISTING

STORM SEWER S @ 1.04%

(ASSUMED)

STORM INLET -

(PER PLAN)

RIM 95.90

RIM 96.20

BASKETBALL -

92.83 10"SE

90.47 10"NW (ASSUMED)

15" NW 81.00' INV.

10" SE 81.07' INV.

10" SW 89.75' INV.

Existing

Building

Lot Area

53,394 sq. ft.

S 88°58'14"

CONTRACTOR SHALL ADJUST AND/OR RECONSTRUCT EXISTING UTILITY COVERS (SUCH AS MANHOLE

COVERS, VALVE BOX COVERS, ETC.) TO MATCH FINISHED GRADES OF THE AREAS DISTURBED DURING

CONTRACTOR SHALL FIELD VERIFY LOCATIONS, ELEVATIONS, AND SIZES OF PROPOSED UTILITIES AND

CHECK ALL UTILITY CROSSINGS FOR CONFLICTS PRIOR TO ATTEMPTING CONNECTIONS AND BEGINNING

PIPE - REINFORCED CONCRETE PIPE (RCP) SHALL MEET THE REQUIREMENTS OF ASTO CLASS IV

DUAL-WALL POLYETHYLENE N-12 CORRUGATED PIPE (HDPE) SHALL BE AS MANUFACTURED BY ADS

OR EQUAL WITH WATER TIGHT JOINTS, AND SHALL MEET THE REQUIREMENTS OF AASHTO DESIGNATION

INLETS/CATCH BASINS - INLETS/CATCH BASINS SHALL BE CONSTRUCTED IN ACCORDANCE WITH FILE

NO. 25 OF THE "STANDARD SPECIFICATIONS" WITH A 1'-8" X 2'-6" MAXIMUM OPENING. FRAME &

GRATE SHALL BE NEENAH R-2504 WITH TYPE G GRATE, OR EQUAL. CURB FRAME & GRATE SHALL

SHALL BE FIELD VERIFIED DURING CONSTRUCTION.

BE NEENAH R-33228 WITH TYPE G GRATE, OR EQUAL.

UTILITY CONSTRUCTION.

STORM SEWER SPECIFICATIONS -

STORM INLET -

(PER PLAN)

RIM 96.15

PK Nail Set

10" NE 90.50' INV. 10" SE 90.50' INV.

ROOF DRAIN

-----RD-----

- POLLUTANT DISCHARGE ELIMINATION SYSTEM (NPDES) STORMWATER GENERAL PERMIT FOR CONSTRUCTION SITE LAND DISTURBANCE ACTIVITIES. ALL EROSION AND SEDIMENT CONTROL MEASURES ARE TO BE CONSTRUCTED AND MAINTAINED IN ACCORDANCE WITH THE WISCONSIN DEPARTMENT OF NATURAL RESOURCES (WDNR) TECHNICAL STANDARDS (REFERRED TO AS BMP'S) AND CITY O MANAGEMENT PRACTICES (BMP'S). IT IS THE RESPONSIBILITY OF ALL CONTRACTORS ASSOCIATED WITH THE PROJECT TO OBTAIN A COPY OF, AND UNDERSTAND, THE BMP'S PRIOR TO THE START OF
- 2. THE EROSION CONTROL MEASURES INDICATED ON THE PLANS ARE THE MINIMUM REQUIREMENTS. ADDITIONAL CONTROL MEASURES AS DIRECTED BY JSD PROFESSIONAL SERVICES, INC. OR GOVERNING
- AGENCIES SHALL BE INSTALLED WITHIN 24 HOURS OF REQUEST. 3. MODIFICATIONS TO THE APPROVED EROSION CONTROL PLAN IN ORDER TO MEET UNFORESEEN FIELD CONDITIONS ARE ALLOWED IF MODIFICATIONS CONFORM TO BMP'S. ALL MODIFICATIONS MUST BE

APPROVED BY JSD/MUNICIPALITY PRIOR TO DEVIATION OF THE APPROVED PLAN.

WITH BMP'S PRIOR TO RELEASE INTO STORM SEWER OR DITCHES.

- 4. INSTALL PERIMETER EROSION CONTROL MEASURES (SUCH AS SILT FENCE AND EXISTING INLET PROTECTION) PRIOR TO ANY SITE WORK, INCLUDING GRADING OR DISTURBANCE OF EXISTING SURFACE FROM SEDIMENT TRANSPORT
- 5. PAVED SURFACES ADJACENT TO CONSTRUCTION ENTRANCES SHALL BE SWEPT AND/OR SCRAPED TO 6. ALL DISTURBED GROUND LEFT INACTIVE FOR SEVEN OR MORE DAYS SHALL BE STABILIZED BY REMOVE ACCUMULATED SOIL, DIRT AND/OR DUST AFTER THE END OF EACH WORK DAY AND AS REQUESTED BY THE GOVERNING AGENCIES.
- 6. ALL EXISTING STORM SEWER FACILITIES THAT WILL COLLECT RUNOFF FROM DISTURBED AREAS SHALL BE PROTECTED TO PREVENT SEDIMENT DEPOSITION WITHIN STORM SEWER SYSTEMS. INLET PROTECTION
- SHALL BE IMMEDIATELY FITTED AT THE INLET OF ALL INSTALLED STORM SEWER. ALL INLETS, STRUCTURES, PIPES, AND SWALES SHALL BE KEPT CLEAN AND FREE OF SEDIMENTATION AND DEBRIS. 7. EROSION CONTROL FOR UTILITY CONSTRUCTION (STORM SEWER, SANITARY SEWER, WATER MAIN, ETC.)
- OUTSIDE OF THE PERIMETER CONTROLS SHALL INCORPORATE THE FOLLOWING PLACE EXCAVATED TRENCH MATERIAL ON THE HIGH SIDE OF THE TRENC BACKFILL, COMPACT, AND STABILIZE THE TRENCH IMMEDIATELY AFTER PIPE CONSTRUCTION. DISCHARGE TRENCH WATER INTO A SEDIMENTATION BASIN OR FILTERING TANK IN ACCORDANCE
- AS NEEDED. THE GENERAL CONTRACTOR WILL BE RESPONSIBLE FOR INSPECTION AND REPAIR DURING CONSTRUCTION. THE OWNER WILL BE RESPONSIBLE IF EROSION CONTROL IS REQUIRED AFTER THE
- 10. NOTIFY THE CITY OF COMPLETION OF ANY BEST MANAGEMENT PRACTICES WITHIN THE NEXT WORKING 9. TOPSOIL STOCKPILES SHALL HAVE A BERM OR TRENCH AROUND THE CIRCUMFERENCE AND PERIMETER SILT FENCE TO CONTROL SILT. IF TOPSOIL STOCKPILE REMAINS UNDISTURBED FOR MORE THAN
- SEVEN (7) DAYS, TEMPORARY SEEDING AND STABILIZATION IS REQUIRED. 10. EROSION CONTROL MEASURES TEMPORARILY REMOVED FOR UNAVOIDABLE CONSTRUCTION ACTIVITIES SHALL BE IN WORKING ORDER PRIOR TO THE COMPLETION OF EACH WORK DAY.
- TEMPORARY EROSION AND SEDIMENT CONTROL MEASURES SHALL BE REMOVED WITHIN THIRTY (30) DAYS AFTER FINAL SITE STABILIZATION IS ACHIEVED OR AFTER THE TEMPORARY MEASURES ARE NO LONGER NEEDED. DISTURBANCES ASSOCIATED WITH EROSION CONTROL REMOVAL SHALL BE 14. KEEP A COPY OF THE EROSION CONTROL PLAN ON THE SITE. IMMEDIATELY STABILIZED.
- 12. PUMPS MAY BE USED AS BYPASS DEVICES. IN NO CASE SHALL PUMPED WATER BE DIVERTED OUTSIDE THE PROJECT LIMITS. 13. GRADING EFFORTS SHALL BE CONDUCTED IN SUCH A MANNER AS TO MINIMIZE EROSION. EROSION AND SEDIMENT CONTROL MEASURES SHALL CONSIDER THE TIME OF YEAR, SITE CONDITIONS, AND THE

USE OF TEMPORARY OR PERMANENT MEASURES. ALL DISTURBED AREAS THAT WILL NOT BE WORKEI

FOR EROSION CONTROL SHALL BE IN ACCORDANCE WITH TECHNICAL STANDARDS. 14. ALL DISTURBED SLOPES EXCEEDING 4:1 YET LESS THAN 3:1, SHALL BE STABILIZED WITH NORTH 3. AMERICAN GREEN S75BN EROSION MATTING (OR APPROVED EQUAL) AND DISTURBED SLOPES EXCEEDING 3:1 YET LESS THAN 2:1 SHALL BE STABILIZED WITH NORTH AMERICAN GREEN C125BN (OR APPROVED EQUAL) OR APPLICATION OF AN APPROVED POLYMER SOIL STABILIZATION TREATMENT OR A COMBINATION THEREOF, AS REQUIRED. EROSION MATTING AND/OR NETTING USED ONSITE SHALL

BE INSTALLED IN ACCORDANCE WITH MANUFACTURER'S GUIDELINES.

POLLUTANTS ENTERING THE DRAINAGE SYSTEM ON A DAILY BASIS.

- 15. DURING PERIODS OF EXTENDED DRY WEATHER, THE CONTRACTOR SHALL KEEP A WATER TRUCK ON SITE FOR THE PURPOSE OF WATERING DOWN SOILS WHICH MAY OTHERWISE BECOME AIRBORNE. THE CONTRACTOR IS RESPONSIBLE FOR CONTROLLING WIND EROSION (DUST) DURING CONSTRUCTION AT
- 16. DISTURBED AREAS AND AREAS USED FOR STORAGE OF MATERIALS THAT ARE EXPOSED TO PRECIPITATION SHALL BE VISUALLY INSPECTED FOR EVIDENCE OF, OR THE POTENTIAL FOR,
- 17. QUALIFIED PERSONNEL (PROVIDED BY THE GENERAL/PRIME CONTRACTOR) SHALL INSPECT DISTURBED AREAS OF THE CONSTRUCTION SITE THAT HAVE NOT BEEN FINALLY STABILIZED AND EROSION AND SEDIMENT CONTROLS WITHIN 24 HOURS OF ALL 0.5-INCH, OR MORE, PRECIPITATION EVENTS WITH A MINIMUM INSPECTION INTERVAL OF ONCE EVERY SEVEN (7) CALENDAR DAYS IN THE ABSENCE OF A QUALIFYING RAIN OR SNOWFALL EVENT. REPORTING SHALL BE IN ACCORDANCE WITH PART IV D.4. (a-f). OF THE NPDES GENERAL PERMIT. CONTRACTOR SHALL IMMEDIATELY ARRANGE TO HAVE ANY DEFICIENT ITEMS REVEALED DURING INSPECTIONS REPAIRED/REPLACED.
- 18. THE FOLLOWING MAINTENANCE PRACTICES SHALL BE USED TO MAINTAIN, IN GOOD AND EFFECTIVE OPERATING CONDITIONS, VEGETATION, EROSION AND SEDIMENT CONTROL MEASURES, AND OTHER PROTECTIVE MEASURES IDENTIFIED IN THIS PLAN. UPON IDENTIFICATION, DEFICIENCIES IN STORMWATER CONTROLS SHALL BE ADDRESSED IMMEDIATELY. THE MAINTENANCE PROCEDURES FOR THIS DEVELOPMENT SHALL INCLUDE, BUT NOT BE LIMITED TO THE BELOW.
- SILT FENCE REPAIR OR REPLACE ANY DAMAGED FILTER FABRIC AND/OR STAKES. REMOVE ACCUMULATED SEDIMENT WHEN IT HAS REACHED ONE—HALF THE ABOVE GROUND HEIGHT OF THE • <u>EROSION CONTROL MATTING</u> — REPAIR MATTING IMMEDIATELY IF INSPECTION REVEALS BREACHED OR FAILED CONDITIONS. REPAIR AND RE-GRADE SOIL WHERE CHANNELIZATION HAS OCCURRED. • <u>DIVERSION</u> <u>BERM/SWALE</u> — REPLACE OR RE—COMPACT THE CONSTRUCTION MATERIALS AS
- INLET PROTECTION CLEAN, REPAIR OR REPLACE FILTER FABRIC AND/OR STONE WHEN CONTROL MEASURE IS CLOGGED. INLET FILTER BAGS SHALL BE REPLACED ONCE BAG BECOMES ONE—HALF

#### ADDITIONAL POLLUTANT CONTROL MEASURES TO BE IMPLEMENTED DURING CONSTRUCTION ACTIVITIES SHALL INCLUDE, BUT NOT BE LIMITED TO THE FOLLOWING.

- CONSTRUCTION WASTE SHALL BE PROPERLY DISPOSED OF. THIS INCLUDES ALL CONSTRUCTION SITE WASTE MATERIAL, SANITARY WASTE, AND WASTE FROM VEHICLE TRACKING OF SEDIMENTS. THE CONTRACTOR SHALL ENSURE THAT NO MATERIAL WASTES OR UNUSED BUILDING MATERIALS SHALI BE BURIED, DUMPED, BURNED, OR DISCHARGED TO THE WATERS OF THE STATE. VEHICLE HAULING MATERIAL AWAY FROM THE SITE SHALL BE COVERED WITH A TARPAULIN TO PREVENT BLOWING DEBRIS.
- DUST CONTROL SHALL BE ACCOMPLISHED BY ONE OR MORE OF THE FOLLOWING METHODS: COVERING 30% OR MORE OF THE SOIL SURFACE WITH A NON-ERODIBLE MATERIAL. . ROUGHENING THE SOIL TO PRODUCE RIDGES PERPENDICULAR TO THE PREVAILING WIND. RIDGES SHALL BE AT LEAST SIX (6) INCHES IN HEIGHT. FREQUENT WATERING OF EXCAVATION AND FILL AREAS.
- D. PROVIDING GRAVEL OR PAVING AT ENTRANCE/EXIT DRIVES, PARKING AREAS AND TRANSIT STREET SWEEPING SHALL BE PERFORMED TO IMMEDIATELY REMOVE ANY SEDIMENT TRACKED ON

21. NOTIFY THE CITY OF WAUWATOSA ENGINEERING DEPARTMENT ONCE ALL EROSION CONTROL IS

INSTALLED FOR CITY INSPECTION AND APPROVAL PRIOR TO STARTING CONSTRUCTION ACTIVITIES.

- 22. REMOVE EROSION CONTROL DEVICES AFTER SITE IS FULLY ESTABLISHED AND THERE IS NO CHANCE EROSION CAN TAKE PLACE. 23. CONTRACTOR SHALL NOTIFY THE CITY OF WAUWATOSA OF ALL CHANGES TO THE EROSION CONTROL
- PLAN. CITY OF WAUWATOSA SHALL REVIEW AND APPROVE ALL CHANGES PRIOR TO COMMENCING 24. CONTRACTOR SHALL NOTIFY THE CITY OF WAUWATOSA WHEN THE SITE IS FULLY ESTABLISHED AND
- READY FOR FINAL INSPECTION. UPON CITY'S APPROVAL OF SITE, CONTRACTOR SHALL BE PERMITTED TO REMOVE ALL EROSION CONTROL. 25. ALL WORK WITHIN THE PUBLIC RIGHT OF WAY REQUIRES A STREET OCCUPANCY PERMIT FROM THE

# SEEDING NOTES

- 1. GENERAL: ALL WORK IN THE R-O-W AND PUBLIC EASEMENTS SHALL BE IN ACCORDANCE WITH LOCAL MUNICIPAL REQUIREMENTS. JSD SHALL BE HELD HARMLESS AND DOES NOT WARRANT ANY DEVIATIONS BY THE OWNER/CONTRACTOR FROM THE APPROVED CONSTRUCTION PLANS THAT MAY RESULT IN DISCIPLINARY ACTIONS BY ANY OR ALL REGULATORY AGENCIES. LOCATE ALL UTILITIES 4. COMPLETE FINAL GRADING, INSTALLATION OF GRAVEL BASE COURSES, PLACEMENT OF CURBS, PRIOR TO CONSTRUCTION. THE CONTRACTOR IS RESPONSIBLE FOR REPAIRING ANY DAMAGE DONE TO UTILITIES. CONTRACTOR MUST CALL 1-800-242-8511 FOR UTILITY LOCATIONS AT LEAST THREE DAYS PRIOR TO DIGGING. HAND DIG AND INSTALL ALL PLANTS THAT ARE NEAR EXISTING UTILITIES. 5. PLACE TOPSOIL AND IMMEDIATELY STABILIZE DISTURBED AREAS WITH EROSION CONTROLS. PROTECT PREVIOUSLY INSTALLED WORK OF OTHER TRADES. CONTRACTOR IS RESPONSIBLE FOR STAKING THE PLANT MATERIALS FOR REVIEW BY OWNER PRIOR TO DIGGING AND PLACEMENT AND 6. EROSION CONTROL MEASURES SHALL BE REMOVED ONLY AFTER SITE CONSTRUCTION IS COMPLETE SHALL COORDINATE ALL FINE GRADING AND RESTORATION WITH THE GRADING CONTRACTOR.
- 2. MATERIALS BLUEGRASS SEED: DISTURBED LAWN AREAS LABELED ON PLAN AS SUCH, SHAL RECEIVE 6" OF TOPSOIL AND EARTH CARPET'S "MADISON PARKS" GRASS SEED, OR EQUIVALENT AS APPROVED BY THE OWNER'S REPRESENTATIVE, INSTALLED PER MANUFACTURER'S RECOMMENDATIONS. IN ADDITION TO TURFGRASS SEED, ANNUAL RYE SHALL BE APPLIED TO ALL DISTURBED AREAS AT A RATE OF 1 1/2 LBS PER 1000 SQUARE FEET. FERTILIZE AND MULCH PER MANUFACTURER'S RECOMMENDATIONS. MULCH SHALL BE CERTIFIED NOXIOUS WEED SEED-FREE
- 3. MATERIALS TOPSOIL: TOPSOIL TO BE CLEAN, FRIABLE LOAM FROM A LOCAL SOURCE, FREE FROM STONES OR DEBRIS OVER 3/4" IN DIAMETER, AND FREE FROM TOXINS OR OTHER DELETERIOUS MATERIALS. TOPSOIL SHALL HAVE A pH VALUE BETWEEN 6 AND 7. TOPSOIL AND PLANTING SOIL SHALL BE TESTED TO ENSURE CONFORMANCE WITH THESE SPECIFICATIONS AND SHALL BE AMENDED TO MEET THESE SPECIFICATIONS. PROVIDE TEST RESULTS TO OWNER'S REPRESENTATIVE PRIOR TO PLACEMENT. DO NOT PLACE FROZEN OR MUDDY TOPSOIL. APPLY SOIL AMENDMENTS TO ALL LANDSCAPE AREAS PER SOIL TEST.
- 4. CLEANUP: THE WORK AREA SHALL BE KEPT SAFE AND NEAT AT ALL TIMES. DISPOSED OF EXCESS SOIL. REMOVE ALL CUTTINGS AND WASTE MATERIALS. SOIL AND BRANCHES. BIND AND WRAP THESE MATERIALS, ANY REJECTED PLANTS, AND ANY OTHER DEBRIS RESULTING FROM ALL PLANTING TASKS AND PROMPTLY CLEAN UP AND REMOVE FROM THE PROJECT SITE. UNDER NO CIRCUMSTANCES SHALL THE ACCUMULATION OF SOIL, BRANCHES OR OTHER DEBRIS BE ALLOWED UPON A PUBLIC PROPERTY IN SUCH A MANNER AS TO RESULT IN A PUBLIC SAFETY HAZARD OR DAMAGE. LIKEWISE UNDER NO CIRCUMSTANCES SHALL ANY DEBRIS OR INCIDENTAL MATERIALS BE ALLOWED UPON

## CITY OF WAUWATOSA EROSION CONTROL NOTES

- 1. ALL CONSTRUCTION SHALL ADHERE TO THE REQUIREMENTS SET FORTH IN WISCONSIN'S NATIONAL 1. SITE DEWATERING, WATER PUMPED FROM THE SITE SHALL BE TREATED BY SEDIMENT BASINS OF OTHER APPROPRIATE BEST MANAGEMENT PRACTICES SPECIFIED IN THE WISCONSIN CONSTRUCTION SITE BEST MANAGEMENT PRACTICES (BMP) HANDBOOK. WATER MAY NOT BE DISCHARGED IN A MANNER THAT CAUSES EROSION OF THE SITE, ADJACENT SITES, OR RECEIVING CHANNELS.
- WAUWATOSA ORDINANCE. THESE PROCEDURES AND STANDARDS SHALL BE REFERRED TO AS BEST 2. WASTE AND MATERIAL DISPOSAL. ALL WASTE AND UNUSED BUILDING MATERIALS (INCLUDING GARBAGE, DEBRIS, CLEANING WASTES, WASTEWATER, TOXIC MATERIALS, OR HAZARDOUS MATERIALS) SHALL BE PROPERLY DISPOSED AND NOT ALLOWED TO BE CARRIED OFF-SITE BY RUNOFF OR WIND.
  - 3. TRACKING. EACH SITE SHALL HAVE GRAVELED ROADS, ACCESS DRIVES AND PARKING AREAS SUFFICIENT WIDTH AND LENGTH TO PREVENT SEDIMENT FROM BEING TRACKED ONTO PUBLIC PRIVATE ROADWAYS. ANY SEDIMENT REACHING A PUBLIC OR PRIVATE ROAD SHALL BE REMOVED STREET CLEANING, TO THE SATISFACTION OF THE CITY, BEFORE THE END OF EACH WORKDAY. FLUSHING MAY NOT BE USED UNLESS SEDIMENT WILL BE CONTROLLED BY A SEDIMENT BASIN OF
  - OTHER APPROPRIATE BEST MANAGEMENT PRACTICE SPECIFIED IN THE BMP HANDBOOK. SEDIMENT CLEANUP. ALL OFF-SITE SEDIMENT DEPOSITS OCCURRING AS A RESULT OF A STORM EVENT SHALL BE CLEANED UP BY THE END OF THE NEXT WORK DAY. ALL OTHER OFF—SITE SEDIMENT DEPOSITS OCCURRING AS A RESULT OF CONSTRUCTION ACTIVITIES SHALL BE CLEANED UP BY THE END OF THE WORK DAY.
- COVER, AS SHOWN ON PLAN IN ORDER TO PROTECT ADJACENT PROPERTIES/STORM SEWER SYSTEMS 5. ALL ACTIVITIES ON THE SITE SHALL BE CONDUCTED IN A LOGICAL SEQUENCE TO MINIMIZE THE AREA OF BARE SOIL EXPOSED AT ANY ONE TIM
  - TEMPORARY OR PERMANENT SEEDING, TEMPORARY OR PERMANENT SEEDING AND MULCHING, SODDING COVERING WITH TARPS, OR EQUIVALENT BEST MANAGEMENT PRACTICES. IF TEMPORARY SEEDING  $\parallel$ ISED, A PERMANENT COVER SHALL ALSO BE REQUIRED AS PART OF THE FINAL SITE STABILIZATION. SEEDING OR SODDING SHALL BE REQUIRED AS PART OF THE FINAL SITE STABILIZATION.
  - DOWNSLOPE ROAD, LAKE, STREAM, WETLAND, OR DRAINAGE CHANNEL. STRAW BALE OR FILTER FABRIC FENCES SHALL BE PLACED ON THE DOWN SLOPE SIDE OF THE PILES. IF REMAINING FOR MORE THAN SEVEN DAYS, PILES SHALL BE STABILIZED BY MULCHING, VEGETATIVE COVER, TARPS OR OTHER

. SOIL OR DIRT STORAGE PILES SHALL BE LOCATED A MINIMUM OF TWENTY-FIVE FEET FROM ANY

- 8. WHEN THE DISTURBED AREA HAS BEEN STABILIZED BY PERMANENT VEGETATION OR OTHER MEANS, TEMPORARY BEST MANAGEMENT PRACTICES SUCH AS FILTER FABRIC FENCES, STRAW BALES, SEDIMENT AND SEDIMENT TRAPS SHALL BE REMOVED.
- 8. ALL TEMPORARY AND PERMANENT EROSION CONTROL MEASURES MUST BE MAINTAINED AND REPAIRED 9. NOTIFY THE CITY ENGINEERING DEPARTMENT (479-8934) WITHIN TWO WORKING DAYS OF COMMENCING ANY LAND DEVELOPMENT OR LAND DISTURBING ACTIVITY.
  - DAY AFTER THEIR INSTALLATION. 1. OBTAIN PERMISSION IN WRITING FROM THE CITY OF WAUWATOSA ENGINEERING DEPARTMENT PRIOR TO MODIFYING THE EROSION CONTROL PLAN.
- 12. REPAIR ANY SILTATION OR EROSION DAMAGE TO ADJOINING SURFACES AND DRAINAGE WAYS RESULTING FROM LAND DEVELOPMENT OR LAND DISTURBING ACTIVITIES. 11. MAINTAIN SOIL EROSION CONTROL DEVICES THROUGH THE DURATION OF THIS PROJECT. ALL 13. INSPECT THE BEST MANAGEMENT PRACTICES AFTER EACH RAIN OF 0.5 INCH OR MORE AND AT LEAST

ONCE EACH WEEK AND MAKE NEEDED REPAIRS.

## **GRADING NOTES**


DEPICTED IN THE PLANS.

- . CONTRACTOR SHALL VERIFY ALL GRADES, ENSURE ALL AREAS DRAIN PROPERLY AND REPORT ANY DISCREPANCIES TO JSD PROFESSIONAL SERVICES, INC. PRIOR TO THE START OF ANY CONSTRUCTION
- FOR A PERIOD OF THIRTY (30) DAYS REQUIRE TEMPORARY SEEDING FOR EROSION CONTROL. SEEDING 2 . ALL EXISTING CONTOURS REPRESENT EXISTING SURFACE GRADES UNLESS OTHERWISE NOTED. ALL PROPOSED GRADES SHOWN ARE FINISH SURFACE GRADES UNLESS OTHERWISE NOTED. 3. ALL EXCAVATIONS AND MATERIAL PLACEMENT SHALL BE COMPLETED TO DESIGN ELEVATIONS AS
  - CONTRACTOR SHALL ASSUME SOLE RESPONSIBILITY FOR THE COMPUTATION(S) OF ALL GRADING QUANTITIES. WHILE JSD ATTEMPTS TO PROVIDE A COST EFFECTIVE APPROACH TO BALANCE EARTHWORK, GRADING DESIGN IS BASED ON MANY FACTORS, INCLUDING SAFETY, AESTHETICS, AND COMMON ENGINEERING STANDARD OF CARE, THEREFORE NO GUARANTEE CAN BE MADE FOR A BALANCED SITE. THE CONTRACTOR MAY SOLICIT APPROVAL FROM ENGINEER/OWNER TO ADJUST FINAL GRADES

FROM DESIGN GRADES TO PROVIDE AN OVERALL SITE BALANCE AS A RESULT OF FIELD

- 4. GRADING ACTIVITIES SHALL BE IN A MANNER TO ALLOW POSITIVE DRAINAGE ACROSS DISTURBED SOILS. WHICH MAY INCLUDE EXCAVATION OF TEMPORARY DITCHES TO PREVENT PONDING, AND IF NECESSARY PUMPING TO ALLEVIATE PONDING. CONTRACTOR SHALL PREVENT SURFACE WATER FROM ENTERING INTO EXCAVATIONS. IN NO WAY SHALL OWNER BE RESPONSIBLE FOR REMEDIATION OF UNSUITABLE SHALL SEQUENCE GRADING ACTIVITIES TO LIMIT EXPOSURE OF DISTURBED SOILS DUE TO WEATHER.
- THE CONTRACTOR IS RESPONSIBLE FOR MEETING MINIMUM COMPACTION STANDARDS AS RECOMMENDED BY THE GEOTECHNICAL ENGINEER. CONTRACTOR SHALL REFER TO THE GEOTECHNICAL ENGINEERING SERVICES REPORT PREPARED BY \_\_\_\_\_ AND DATED \_ REQUIREMENTS. THE CONTRACTOR SHALL NOTIFY ENGINEER/OWNER IF PROPER COMPACTION CANNOT BE OBTAINED. THE PROJECT'S GEOTECHNICAL CONSULTANT SHALL DETERMINE WHICH IN-SITU SOILS ARE TO BE CONSIDERED UNSUITABLE SOILS. THE ENGINEER/OWNER AND GEOTECHNICAL TESTING CONSULTANT WILL DETERMINE IF REMEDIAL MEASURES WILL BE NECESSARY.
- . IN THE EVENT THAT ANY MOISTURE-DENSITY TEST(S) FAIL TO MEET SPECIFICATION REQUIREMENTS, THE CONTRACTOR SHALL PERFORM CORRECTIVE WORK AS NECESSARY TO BRING THE MATERIAL INTO COMPLIANCE AND RETEST THE FAILED AREA AT NO COST TO THE OWNER.
- . WITH THE AUTHORIZATION OF THE ENGINEER/OWNER, MATERIAL THAT IS TOO WET TO PERMIT PROPER COMPACTION MAY BE SPREAD ON FILL AREAS IN AN EFFORT TO DRY. CONTRACTOR SHALL CLEARLY FIELD MARK THE EXTERIOR LIMITS OF SPREAD MATERIAL WITH PAINTED LATH AND SUBMIT A PLAN TO THE ENGINEER/OWNER THAT IDENTIFIES THE LIMITS. UNDER NO CONDITION SHALL THE SPREAD MATERIAL DEPTH EXCEED THE MORE RESTRICTIVE OF: THE EFFECTIVE TREATMENT DEPTH OF MACHINERY THAT WILL BE USED TO TURNOVER THE SPREAD MATERIAL; OR THE MAXIMUM COMPACTION
- THE CONTRACTOR SHALL IMMEDIATELY NOTIFY ENGINEER/OWNER IF GROUNDWATER IS ENCOUNTERED
- 9. CONTRACTOR IS SOLELY RESPONSIBLE FOR THE DESIGN AND CONSTRUCTION OF ADEQUATE AND SAFE TEMPORARY SHORING, BRACING, RETENTION STRUCTURES, AND EXCAVATIONS. 10. THE SITE SHALL BE COMPLETED TO WITHIN  $0.10-{
  m FT}$  (+/-) OF THE PROPOSED GRADES AS INDICATED WITHIN THE PLANS PRIOR TO PLACEMENT OF TOPSOIL OR STONE. CONTRACTOR IS ENCOURAGED TO
- SEQUENCE CONSTRUCTION SUCH THAT THE SITE IS DIVIDED INTO SMALLER AREAS TO ALLOW TABILIZATION OF DISTURBED SOILS IMMEDIATELY UPON COMPLETION OF INDIVIDUAL SMALLER AREAS. . CONTRACTOR SHALL CONTACT "DIGGER'S HOTLINE" FOR LOCATIONS OF ALL EXISTING UTILITIES PRIOR TO COMMENCEMENT OF ANY CONSTRUCTION ACTIVITIES AND SHALL BE RESPONSIBLE FOR PROTECTING
- SAID UTILITIES FROM ANY DAMAGE DURING CONSTRUCTION. 12. CONTRACTOR SHALL PROTECT INLETS AND ADJACENT PROPERTIES WITH SILT FENCING OR APPROVED EROSION CONTROL METHODS UNTIL CONSTRUCTION IS COMPLETED. CONTRACTOR SHALL PLACE SILT
- FENCING AT DOWN SLOPE SIDE OF GRADING LIMITS. 13. CONTRACTOR SHALL BE RESPONSIBLE FOR DAMAGE TO ANY EXISTING FACILITIES OR UTILITIES. ANY DAMAGE SHALL BE REPAIRED TO THE OWNER SATISFACTION AT THE EXPENSE OF THE CONTRACTOR.
- 14. WORK WITHIN ANY ROADWAY RIGHT-OF-WAY SHALL BE COORDINATED WITH THE APPROPRIATE MUNICIPAL OFFICIAL PRIOR TO COMMENCEMENT OF ANY CONSTRUCTION ACTIVITIES. CONTRACTOR SHALL BE RESPONSIBLE FOR OBTAINING ALL NECESSARY PERMITS AND FEES. GRADING WITHIN RIGHT-OF-WAY IS SUBJECT TO APPROVAL BY SAID OFFICIALS. RESTORATION OF RIGHT-OF-WAY IS CONSIDERED INCIDENTAL AND SHALL BE INCLUDED IN THE COST OF GRADING. RESTORATION SHALL
- INCLUDE ALL ITEMS NECESSARY TO RESTORE RIGHT-OF-WAY IN-KIND INCLUDING LANDSCAPING. 15. CONTRACTOR SHALL COMPLY WITH ALL CITY AND/OR STATE CONSTRUCTION STANDARDS/ORDINANCES.
- 16. THE STORM WATER FACILITY SHALL BE INSPECTED BY A CITY OF WAUWATOSA INSPECTOR AT LEAST ONCE DURING CONSTRUCTION AND ONCE AFTER FINAL SITE STABILIZATION OF THE SITE. 17. ALL WORK WITHIN THE PUBLIC RIGHT OF WAY REQUIRES A STREET OCCUPANCY PERMIT FROM THE
- CONSTRUCTION SITE SEQUENCING
- 1. INSTALL PERIMETER SILT FENCE AND EXISTING INLET PROTECTION
- 2. DEMOLISH EXISTING PAVEMENT AND RETAINING. STRIP AND STOCKPILE TOPSOIL, INSTALL SILT FENCE AROUND PERIMETER OF STOCKPILE.
- CONSTRUCT PROPOSED BUILDING AND CONDUCT ROUGH GRADING EFFORTS.
- PAVEMENTS, WALKS, ETC.
- WITH ALL SOIL SURFACES HAVING AN ESTABLISHED VEGETATIVE COVER THAT MEETS OR EXCEEDS THE MISCONSIN DEPARTMENT OF NATURAL RESOURCES DEFINITION OF 'FINAL STABILIZATION'. CONTRACTOR MAY MODIFY SEQUENCING AFTER ITEM 1 AS NEEDED TO COMPLETE CONSTRUCTION EROSION CONTROLS ARE MAINTAINED IN ACCORDANCE WITH THE CONSTRUCTION SITE EROSION CONTROL REQUIREMENTS.



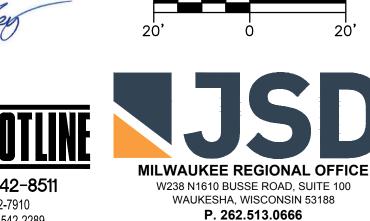

nortr

JSD PROJ. NO.: 22-11646

JSD PROJ. MGR.: RWI

Call 811 or (800) 242-8511 Milwaukee Area (262) 432-7910 Hearing Impaired TDD (800) 542-2289

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GRADING & EROSION CONTROL PLAN

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TY SUBMITTAI

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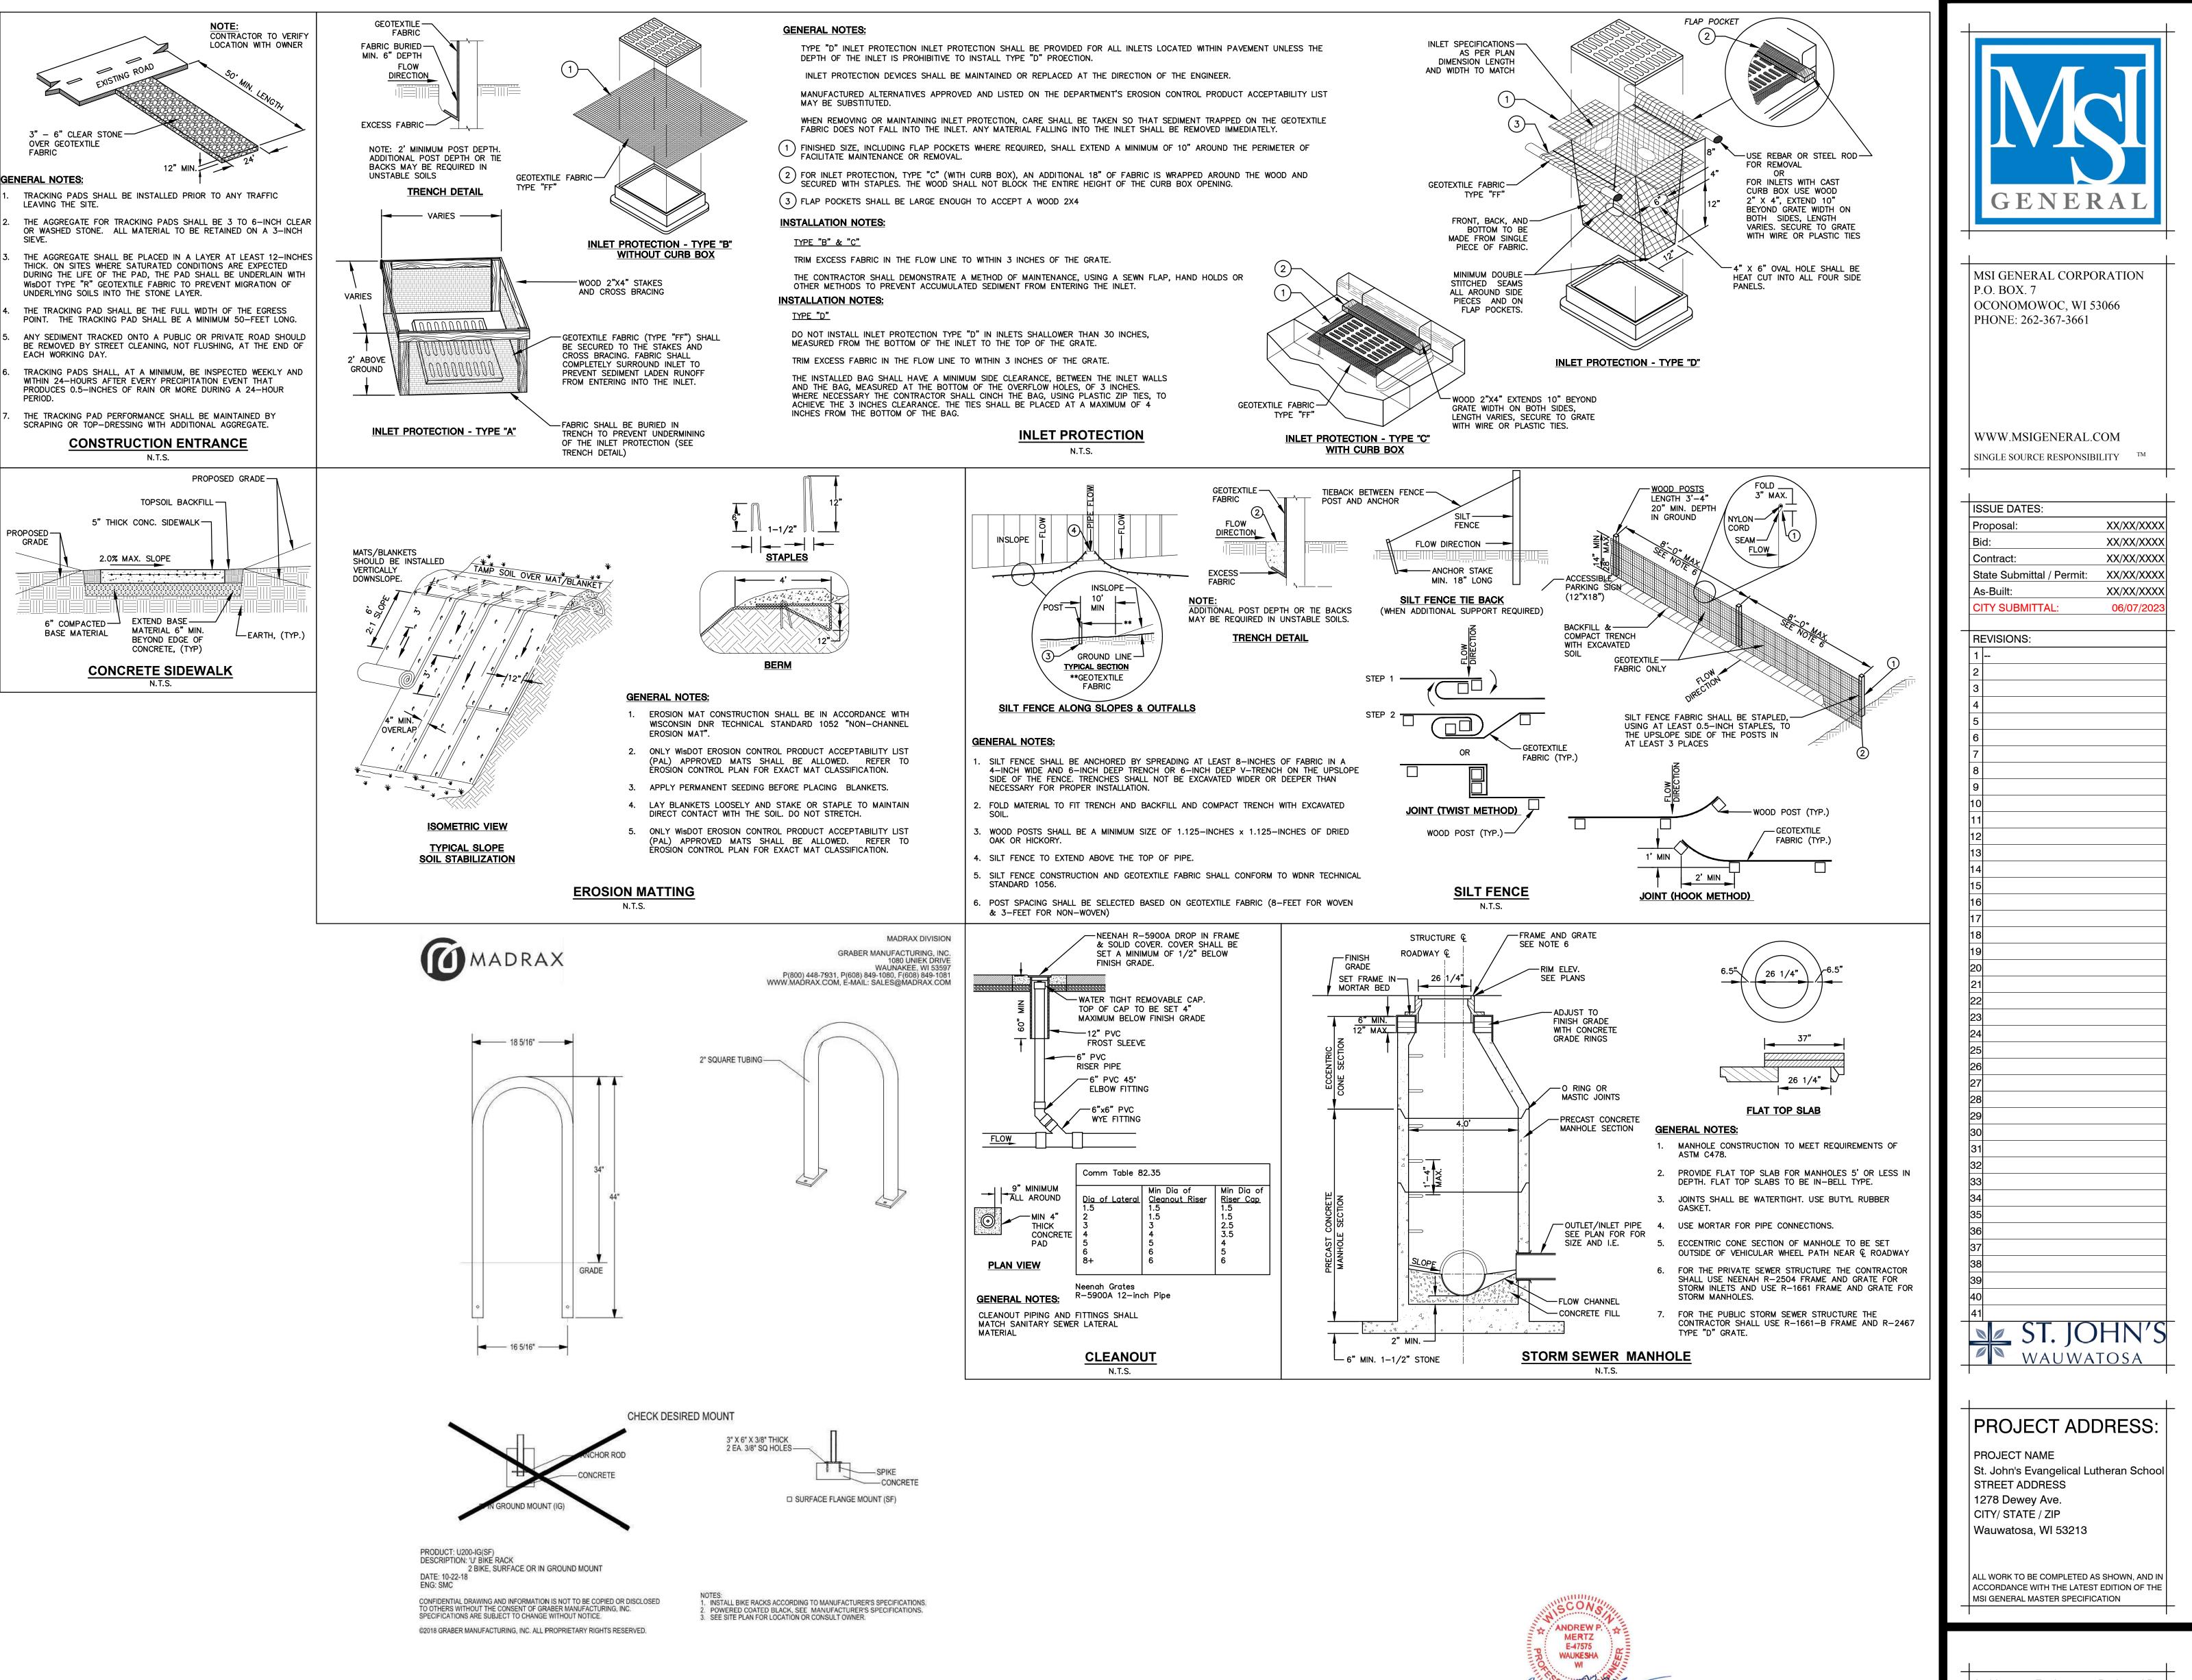
l P.O. BOX. 7

PROJECT ADDRESS

PROJECT NAME | St. John's Evangelical Lutheran School STREET ADDRESS 1278 Dewey Ave. CITY/ STATE / ZIP

Reviewed By

CONTROL PLAN



IGINEER

Engineer: Reviewed By: APM RWI Sheet Title: DETAILS

ARCHITECTS

Sheet Number: C-400

P13329

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GIRAFFE ELECTRIC II, INC.

2025 S WEST AVENUE WAUKESHA, WI 262-549-6500

FAX 262-549-6503 PROJECT ADDRESS:

DATE: 6/5/23

DRAWN BY: JDG REVISIONS: DATE:

SHEET NUMBER: E-5-0

SHEET TITLE: SITE LIGHTING PHOTOMETRICS PLAN

SCALE: 1"=20'-0"

ST. JOHN'S EV. LUTHERAN SCHOOL 1278 DEWEY AVE. WAUWATOSA, W 53213 PROJECT NUMBER:

QTY SYMBOL/TYPE OA 🔀 LED WALL PACK 25'-0"AFG LITHONIA DSX0 LED P5 40K 70CRI LCCO MVOLT WBA DDBXD 90W EACH LED EX EXISTING LED WALL PACK

## LIGHTING NOTES:

MULTIPLE PARTS ARE NEEDED TO ASSEMBLE AS A COMPLETE FIXTURE.
 SEE INSTALLATION INSTRUCTIONS
 EXISTING WALL LIGHT ADDED INTO CALCULATION FOR REPRESENTATION OF CONTRIBUTED LIGHT

### <u>UNDERGROUND NOTES:</u>

Calculation Summary							
Label	CalcType	Units	Avg	Max	Min	Avg/Min	Max/Min
Site	Illuminance	Fc	1.51	5.3	0.0	N.A.	N.A.

DISCLAIMER: CALCULATIONS HAVE BEEN PERFORMED ACCORDING TO IESNA & CIE STANDARDS AND GOOD PRACTICE.

SOME DIFFERENCES BETWEEN MEASURED VALUES AND CALCULATED RESULTS MAY OCCUR DUE TO TOLERANCES IN CALCULATION METHODS,
TESTING PROCEDURES, COMPONENT PERFORMANCE, MEASUREMENT TECHNIQUES AND FIELD CONDITIONS SUCH AS VOLTAGE AND TEMPERATURE VARIATIONS.
INPUT DATA USED TO GENERATE THE ATTACHED CALCULATIONS SUCH AS ROOM DIMENSIONS,
REFLECTANCES, FURNITURE AND ARCHITECTURAL ELEMENTS SIGNIFICANTLY AFFECT THE LIGHTING CALCULATIONS. IF THE

REAL ENVIRONMENT CONDITIONS DO NOT MATCH THE INPUT DATA, DIFFERENCES WILL OCCUR BETWEEN MEASURED VALUES AND CALCULATED VALUES.

H OH Burried Gas OH OH | | | | | | |

Existing Building

Lot Area 53,394 sq. ft.

 0.7
 0.8
 0.9
 1.0
 1.0
 1.0
 0.9
 0.9

1.2 1.2 1.3 1.2 1.2 1.1 1.0 5.9

PK Nail Set Chain Fence S 88°58'14" W

0.4 0.4 0.5 0.5 0.6 0.142.80'0.5 0.4 0.4 0.3 0.3 0.2 0.2 0.1

Util. Pole


4.7 3.9 3.5 1.2 0.5


PROPOSED ADDITION

SITE PHOTOMETRIC PLAN

1" = 20'-0"


Light Pole

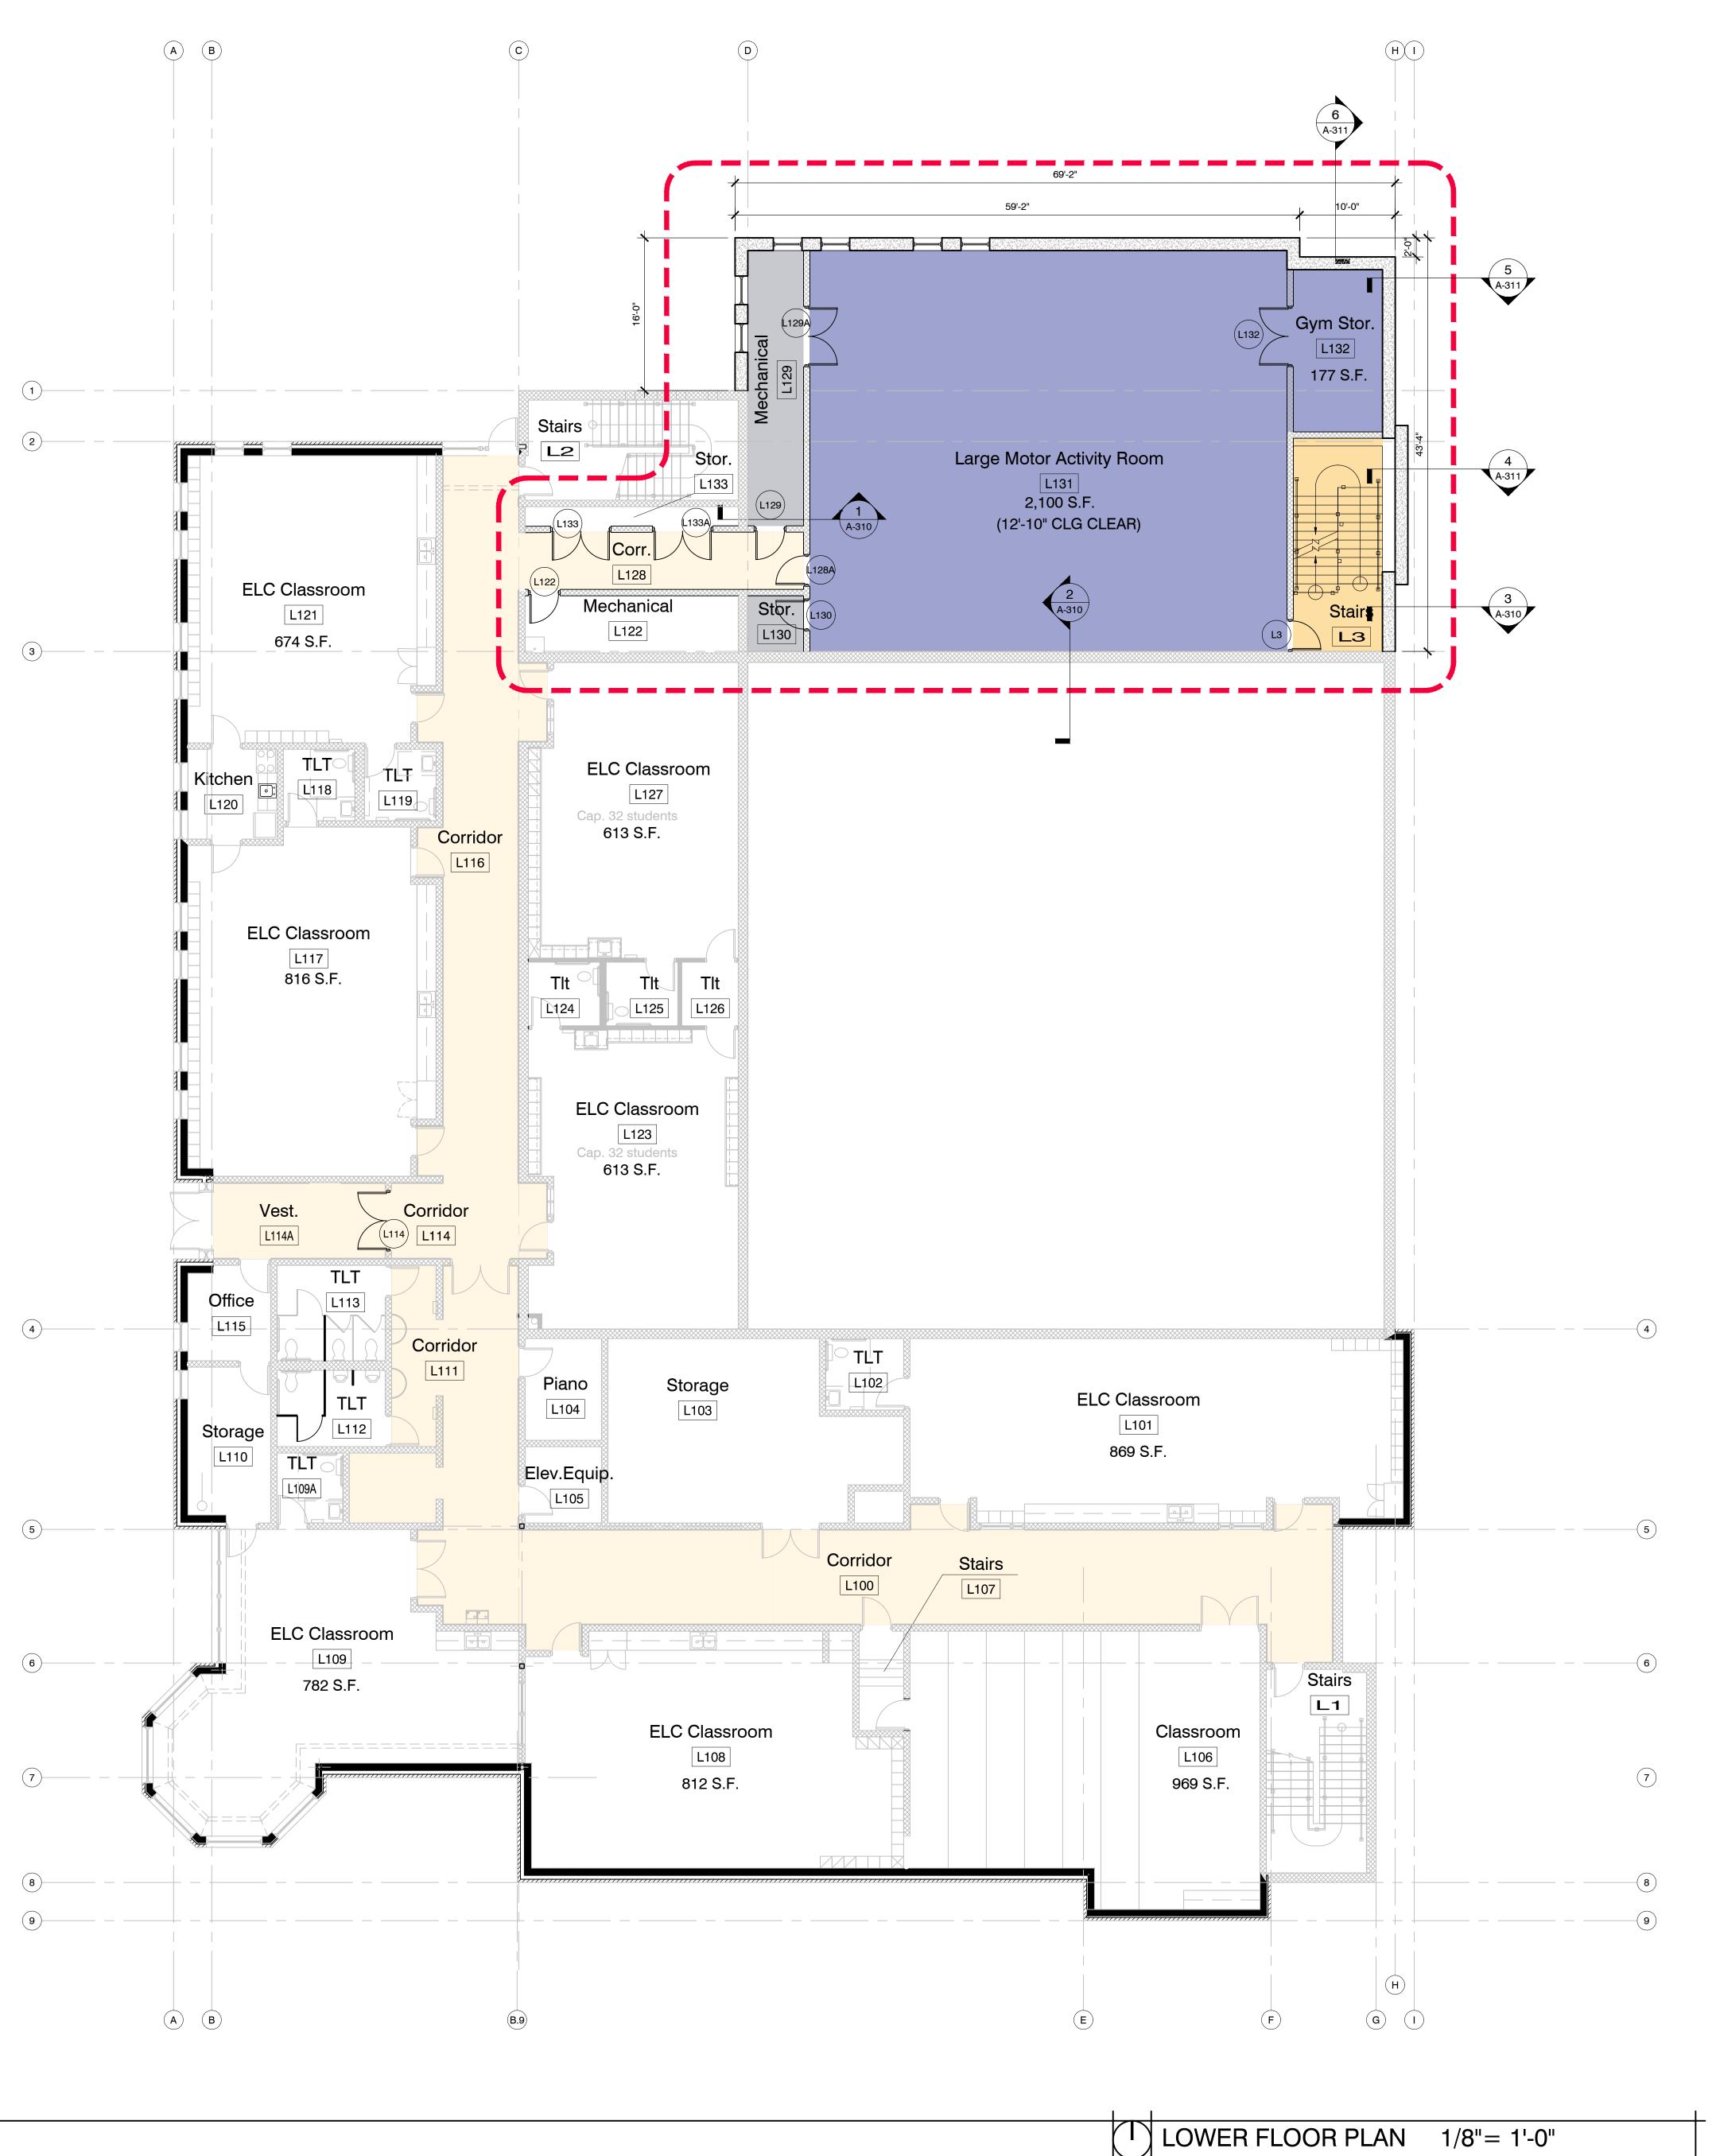


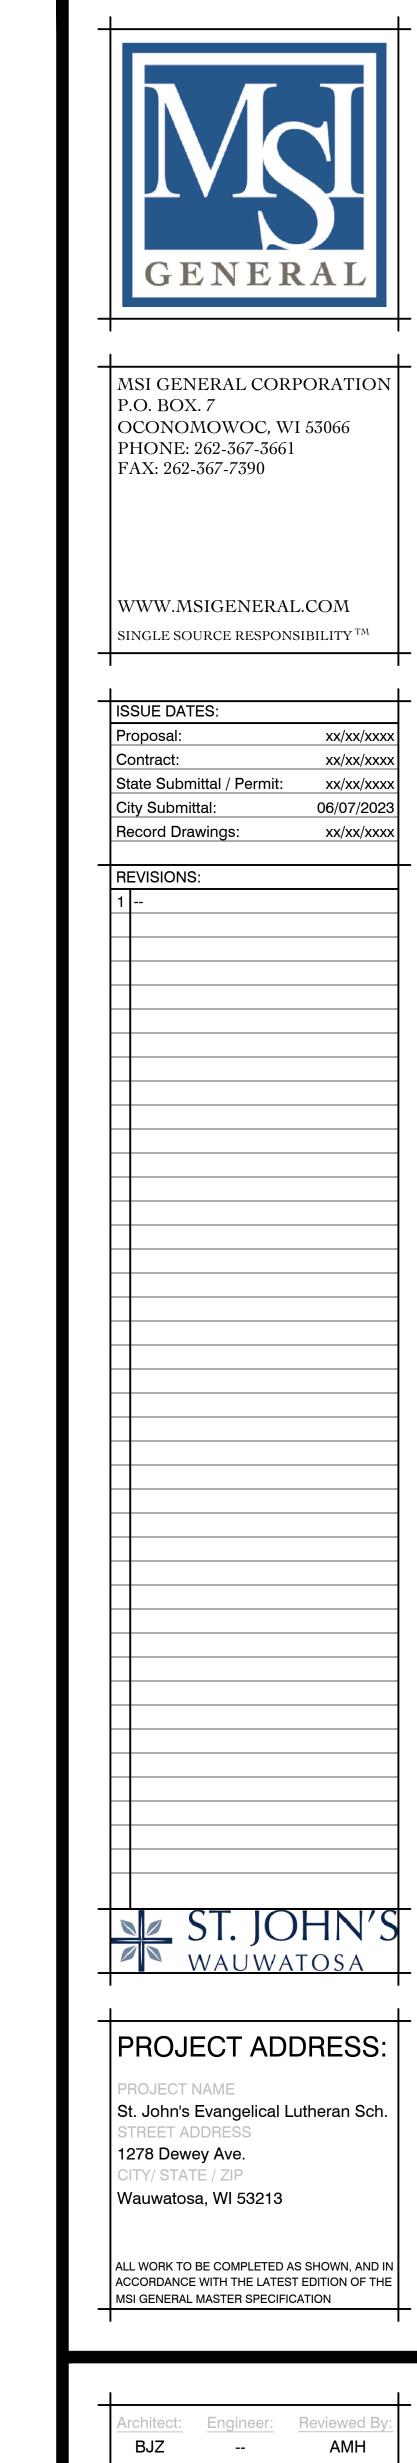

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BJZ -- AMH
Sheet Title:
LOWER FLOOR PLAN
Sheet Number:

A-101
Project Number: -P13329

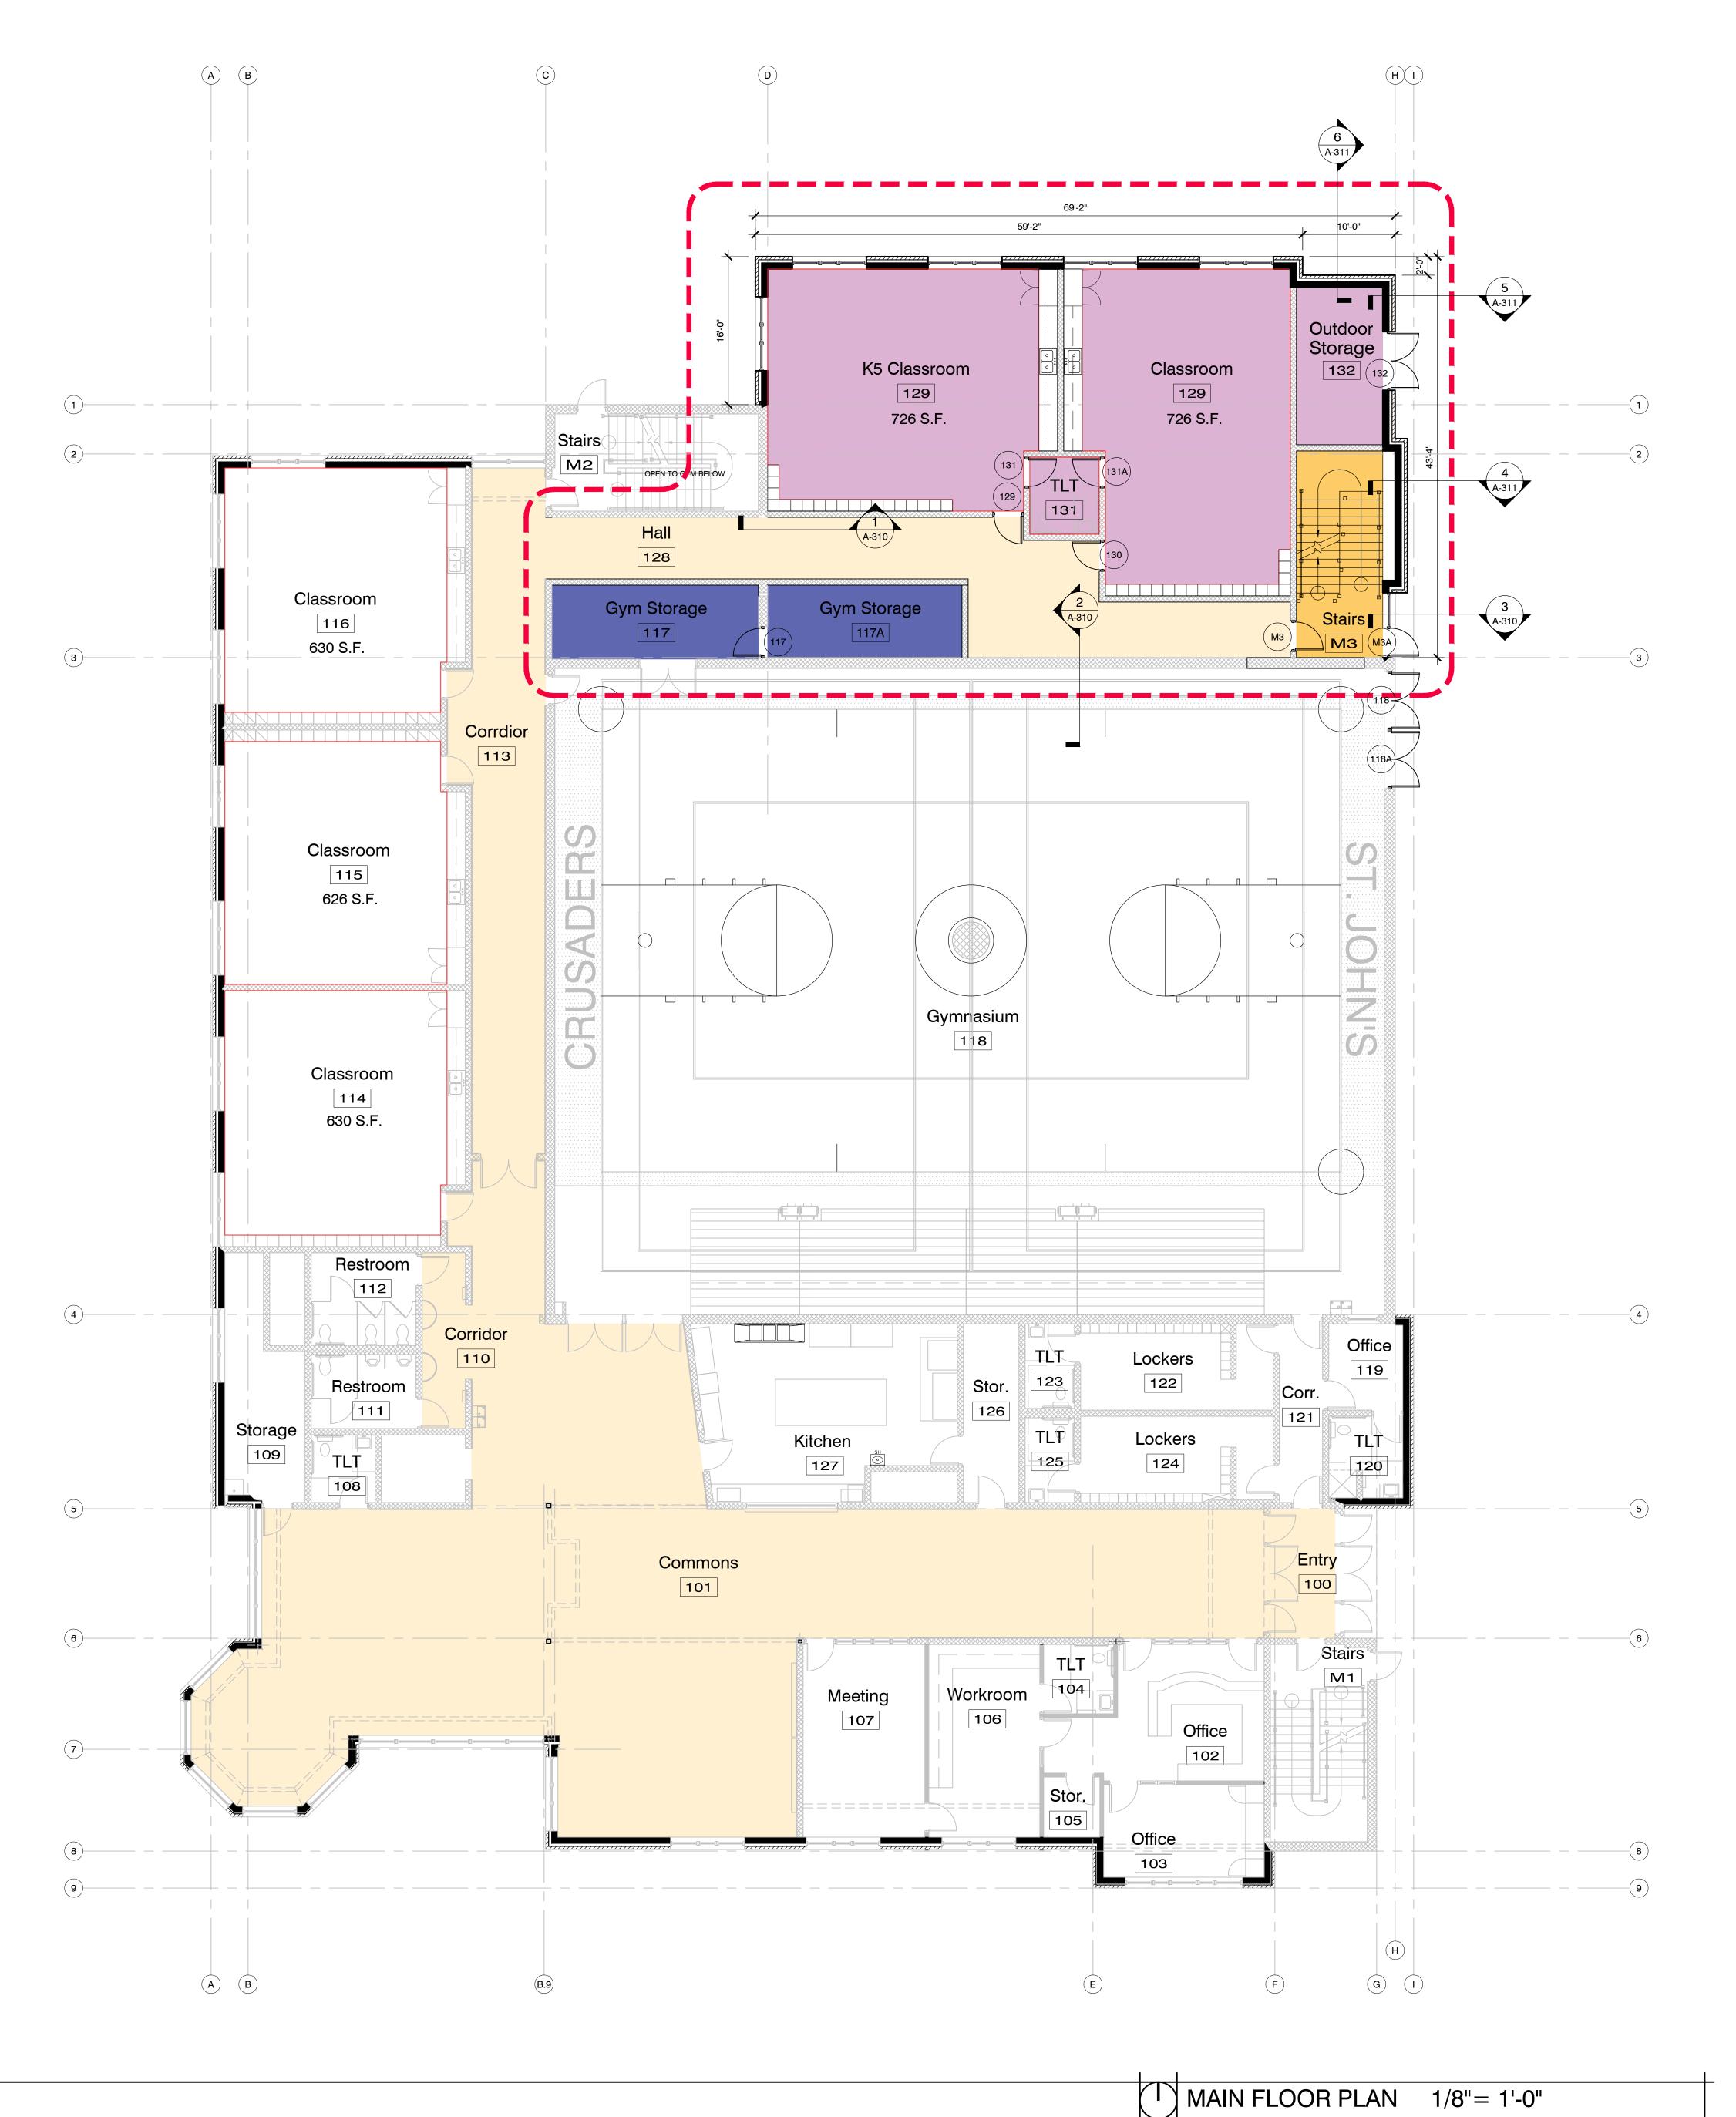

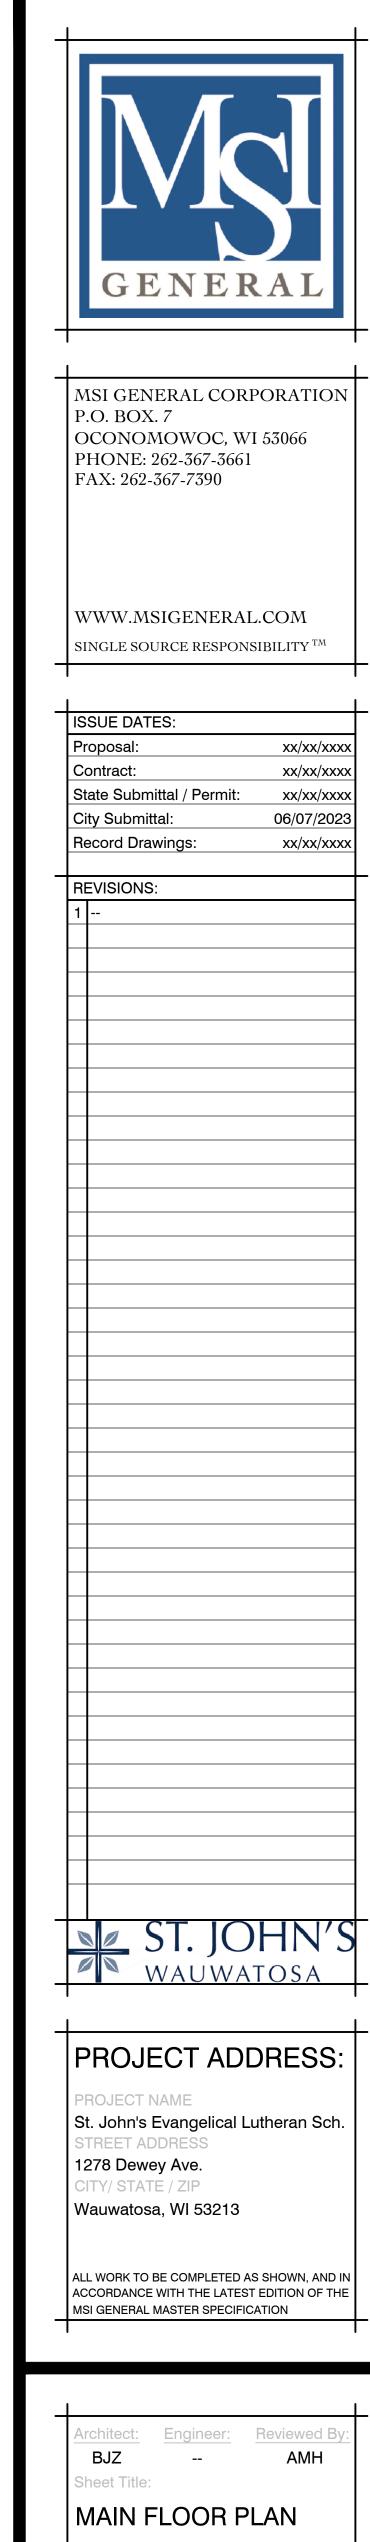

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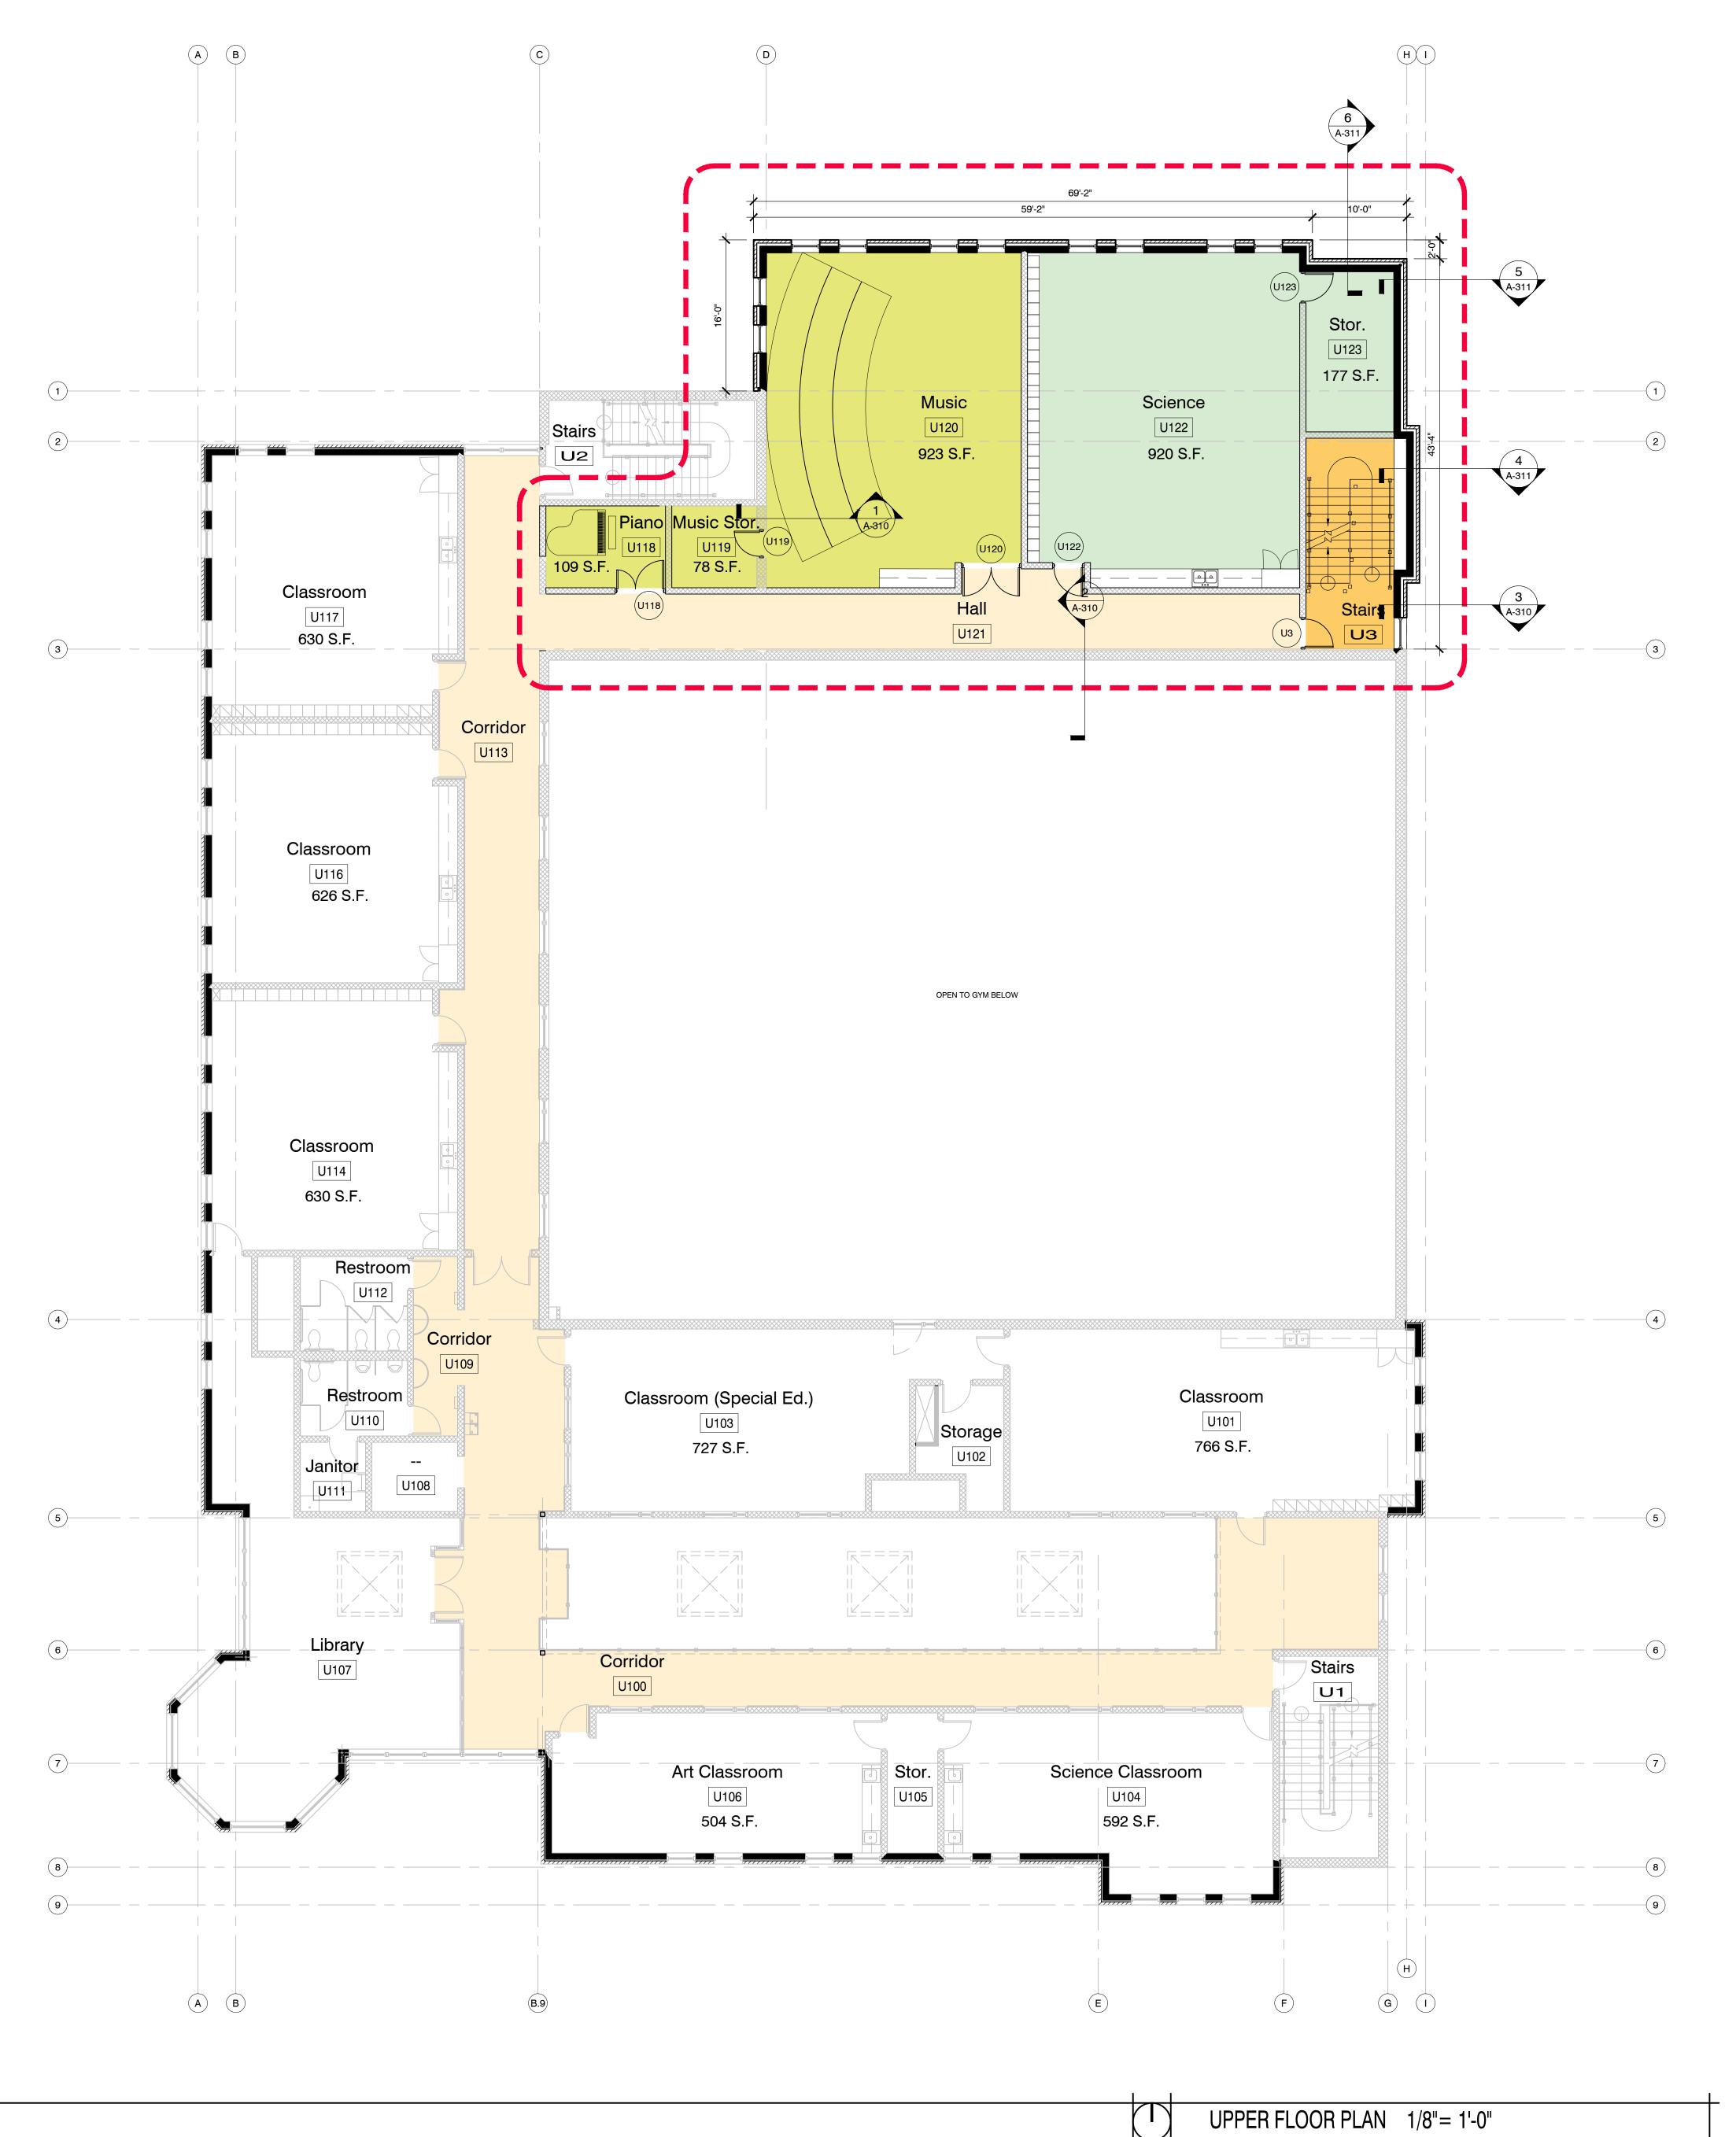
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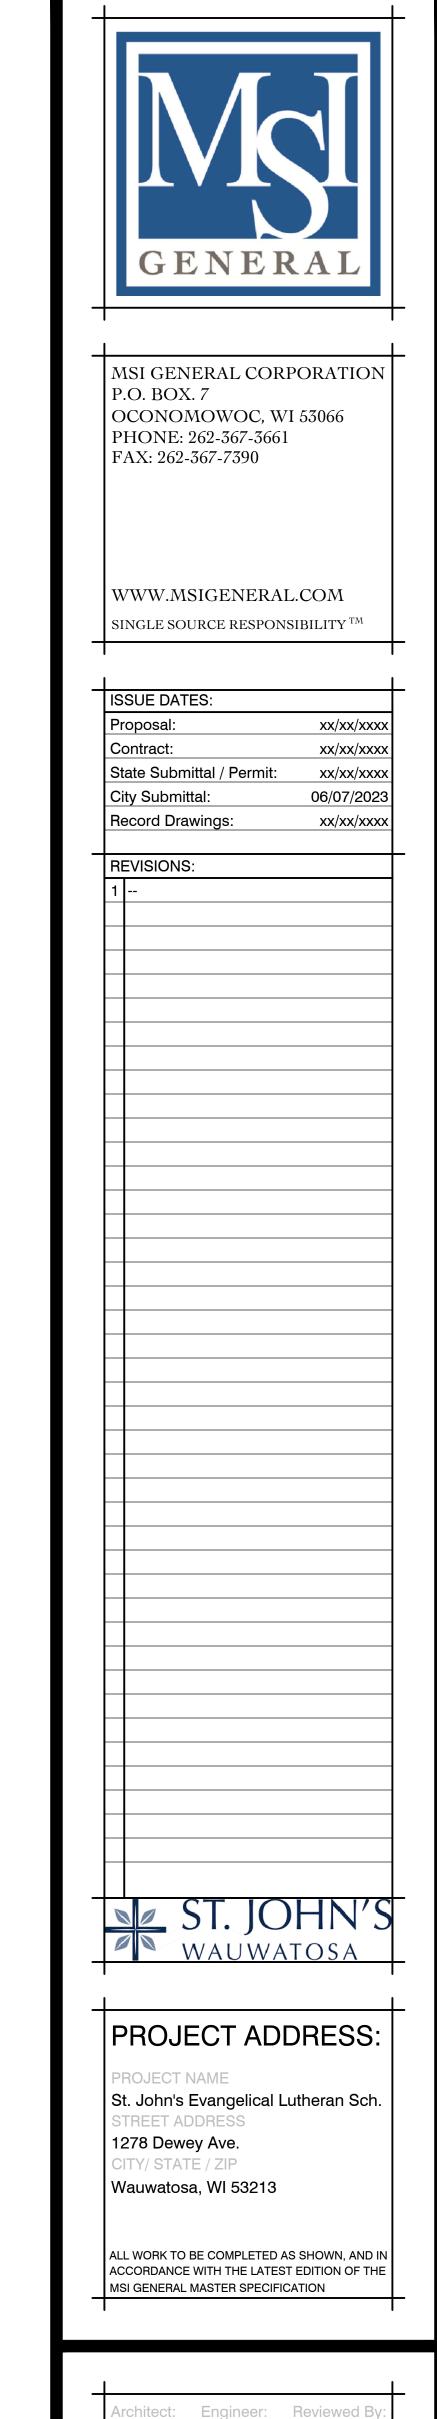
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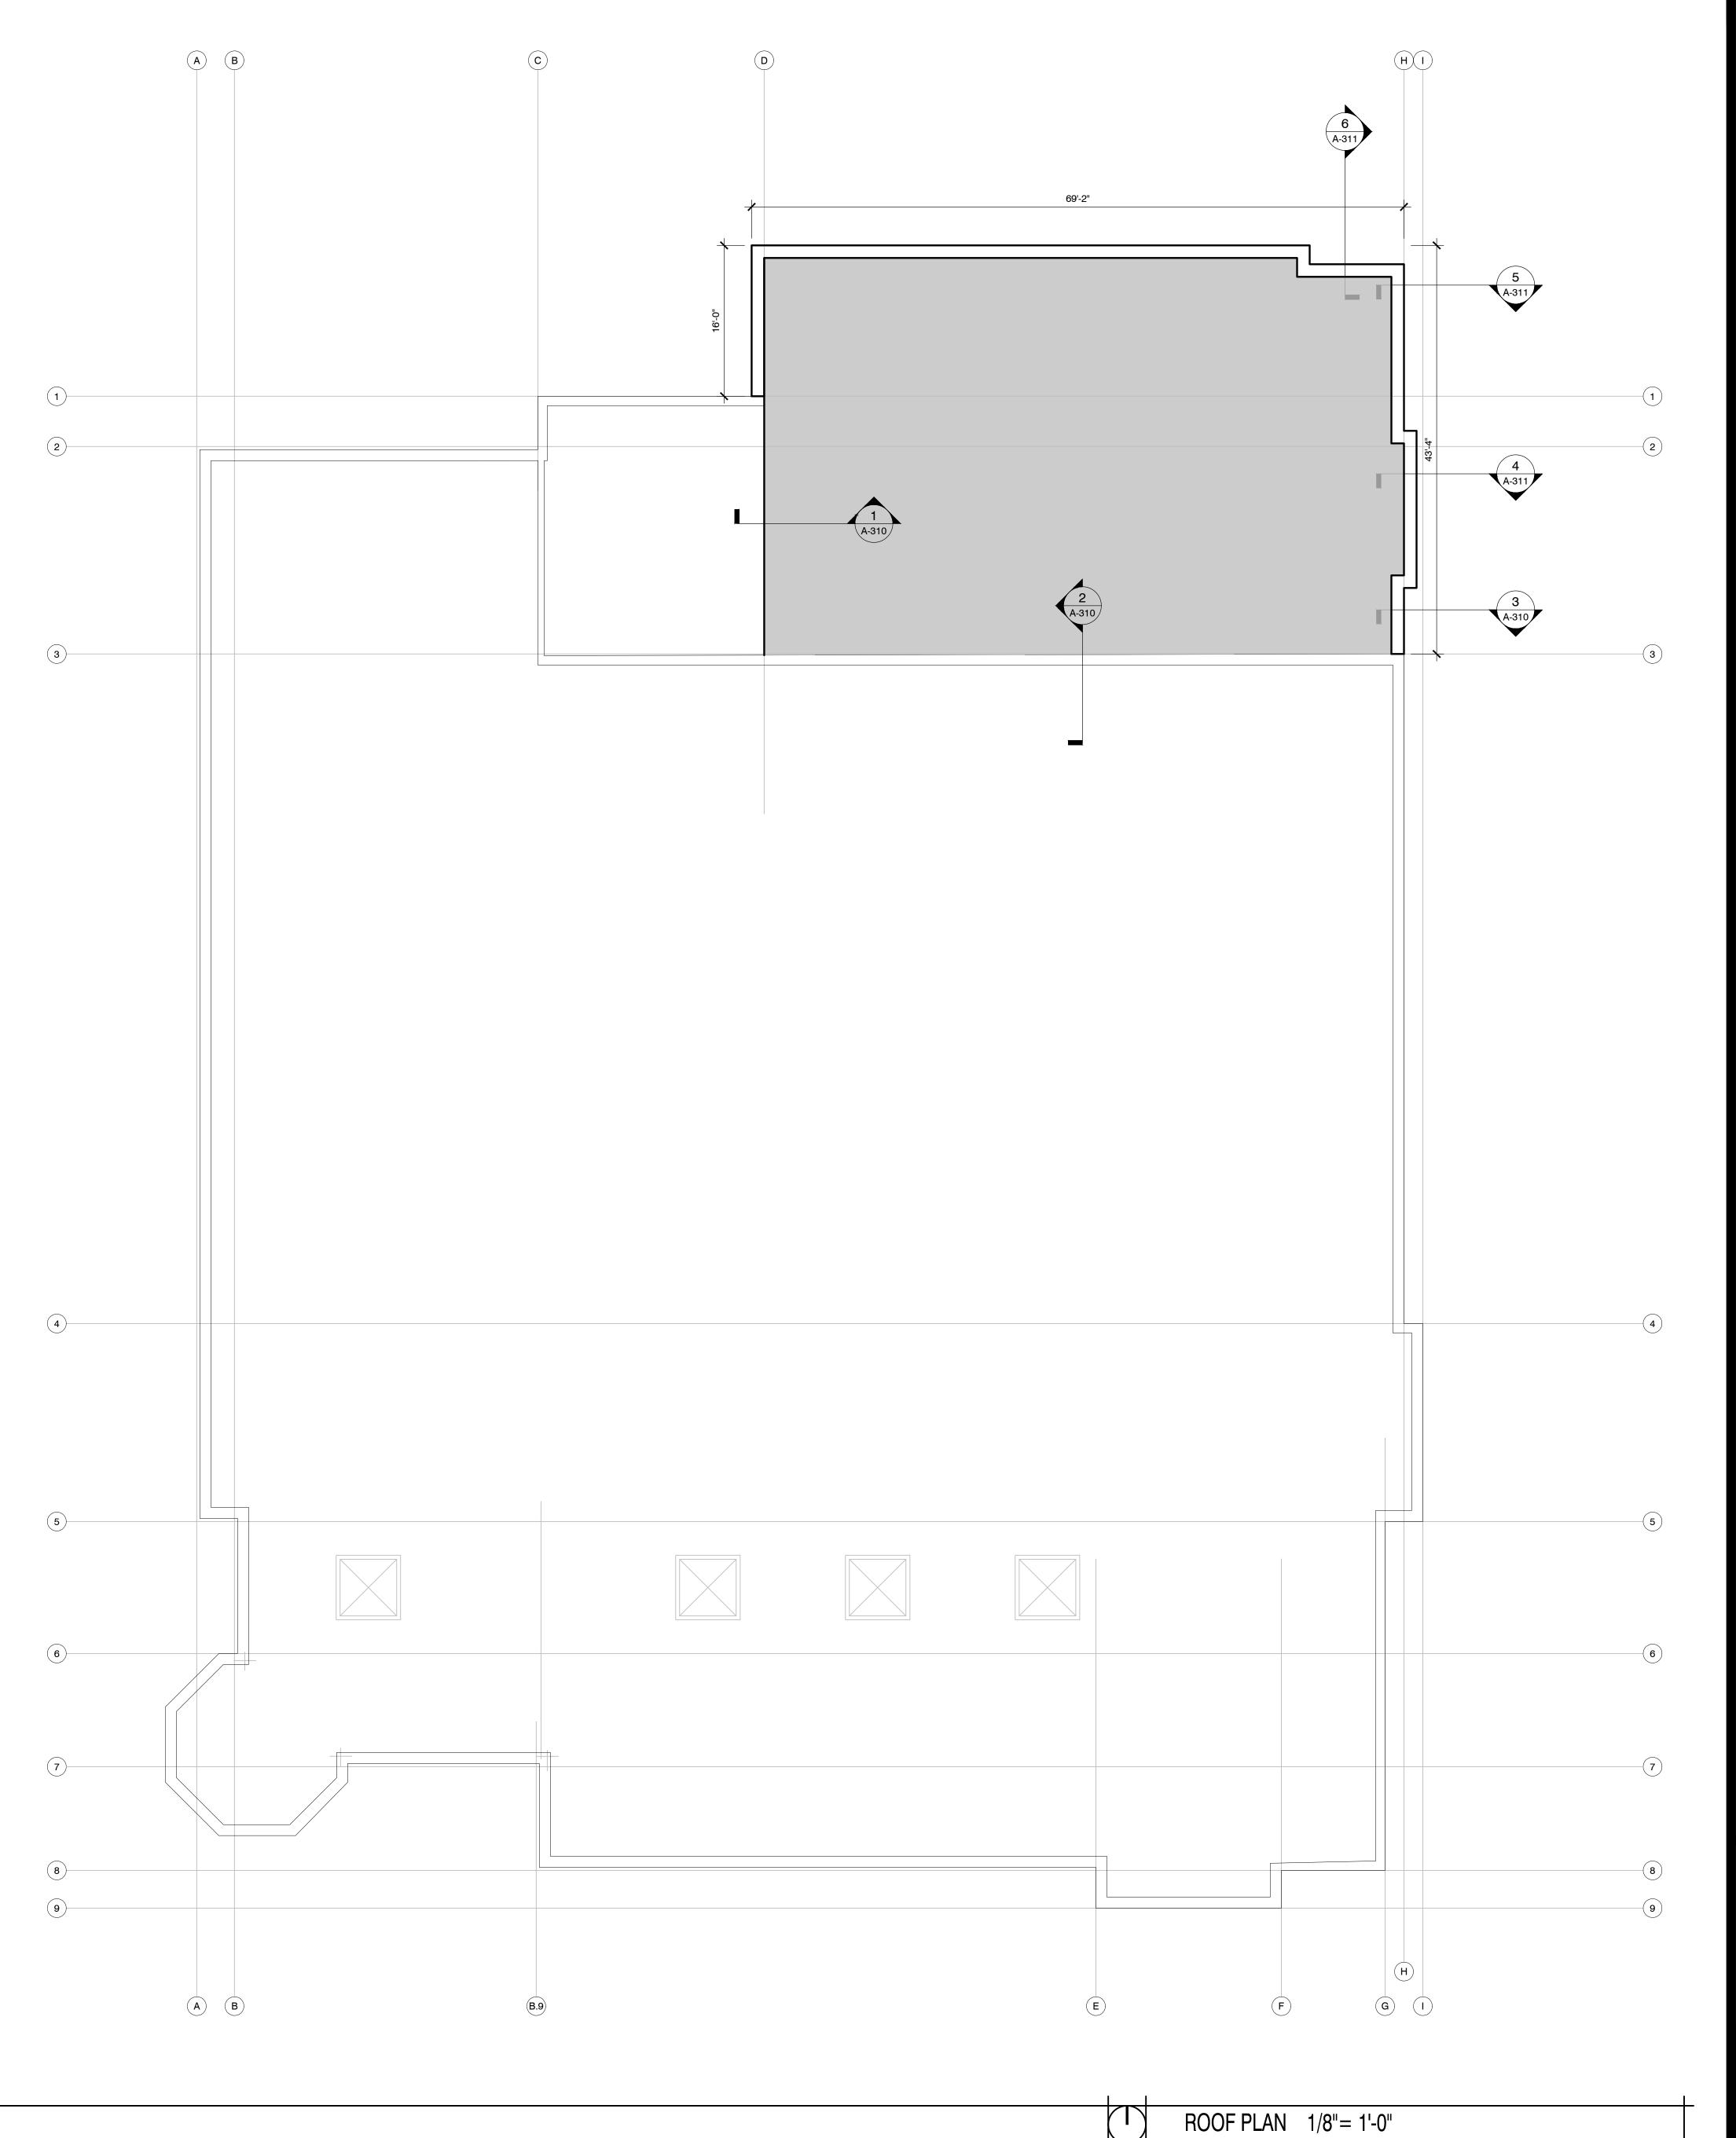
MAIN FLOOR PLAN A-110 P13329





UPPER FLOOR PLAN

P13329





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1 --

REVISIONS:

PROJECT ADDRESS:

ST. JOHN'S WAUWATOSA

PROJECT NAME
St. John's Evangelical Lutheran Sch.
STREET ADDRESS
1278 Dewey Ave.
CITY/ STATE / ZIP

Wauwatosa, WI 53213

ALL WORK TO BE COMPLETED AS SHOWN, AND IN ACCORDANCE WITH THE LATEST EDITION OF THE MSI GENERAL MASTER SPECIFICATION

Architect: Engineer: Reviewed By:
BJZ -- AMH
Sheet Title:
ROOF PLAN
Sheet Number:
A-130
Project Number: -P13329

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> rchitect: Engineer: Reviewed E AMH Sheet Title:

EXTERIOR ELEVATIONS Sheet Number:


A-201 P13329

ARC


ELEVATIONS 1/8" = 1'-0"



NORTH ELEVATION

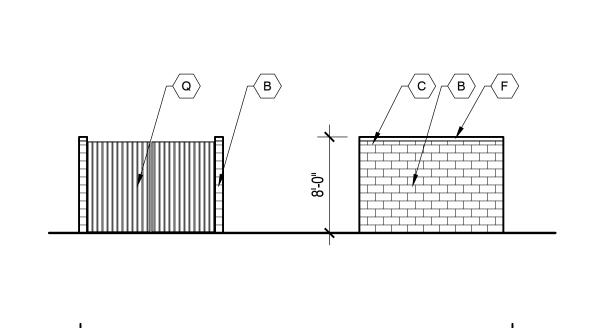

**DUMPSTER ELEVATIONS** 

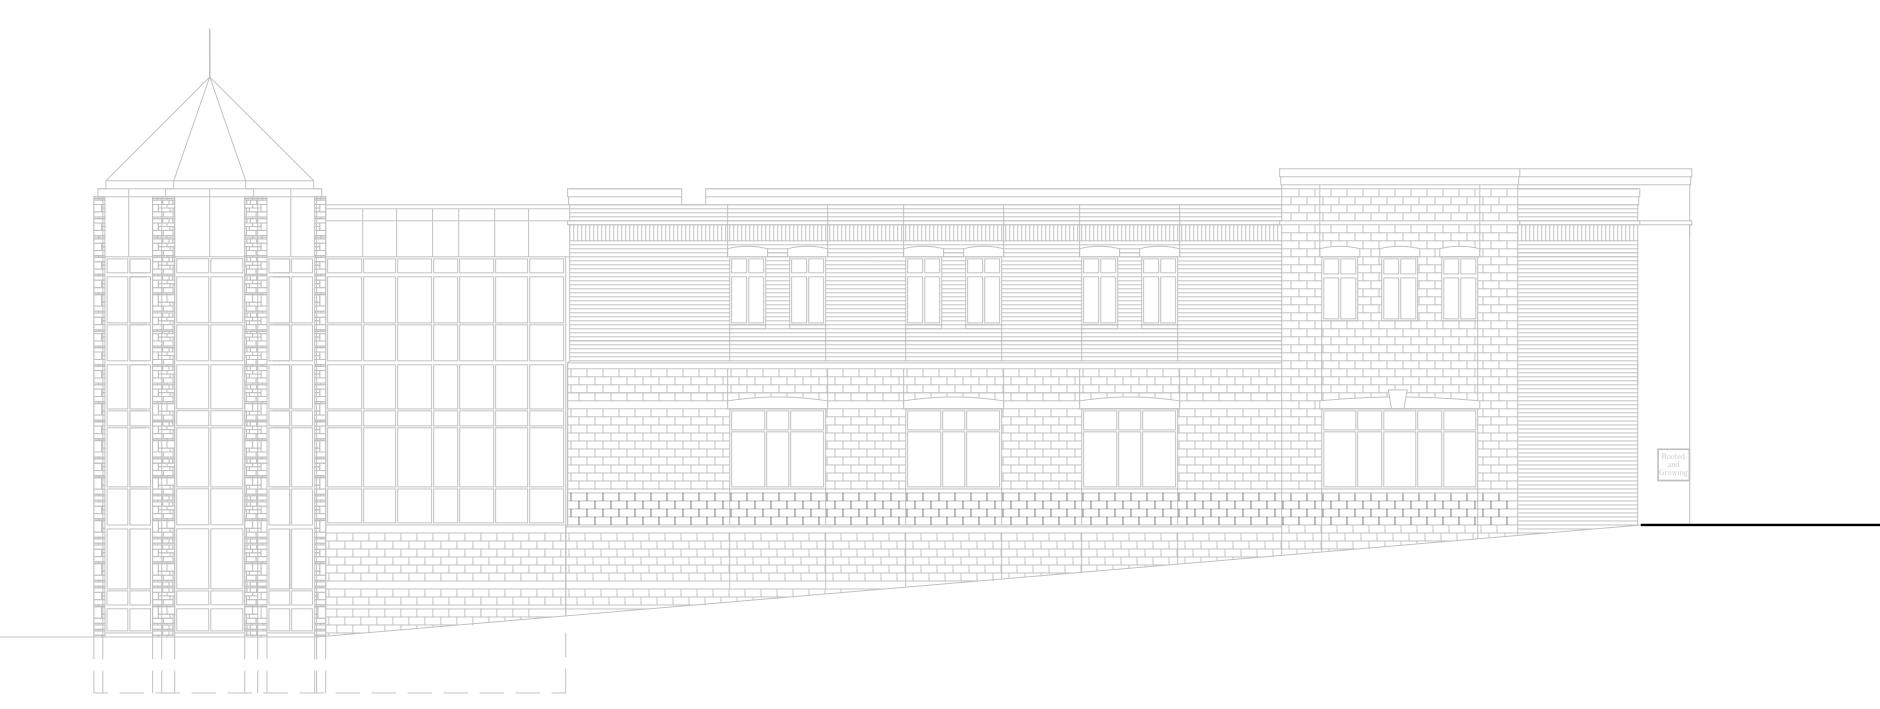

EXTERIOR BUILDING MATERIAL COLORS

A - Concrete brick units-Stria #43 Straw(5%) by Quality Block (or approved equal)

B - Split face units (8" high) #43 Straw(5%) by Quality Block (or approved equal)

C - Smooth face units (8" high) #43 Straw(5%) by Quality Block (or approved equal)

D - Split face units (4" high) #43 Straw(5%) by Quality Block (or approved equal)

- Smooth face units (4" high) #43 Straw(5%) by Quality Block (or approved equal)

Additional notes: All concrete brick units to be laid with standard gray mortar All other units to be laid with matching colored mortar Cap flashing and metal panel to be Siarra Tan by Una-Clad or equal Standing seam metal roof to be Patena Copper


Lannon Stone Colonial Blend by Halquist (or approved equal)

WEST ELEVATION F - Prefinished parapet cap to match exist.

G - Precast stone arched header to match exist. H - Precast stone sill to match exist. J - Prefinished metal panel to match exist.


K - Prefinished alum. storefront frame & glass to match exist.
L - Alum. window frame & glass to match exist.
M - H. M. door & frame (paint to match wall)
N - Glass block to match exist.

P - Cornerstone to match exist. Q - Vertical wood slat gates on metal frame w/ pin closure

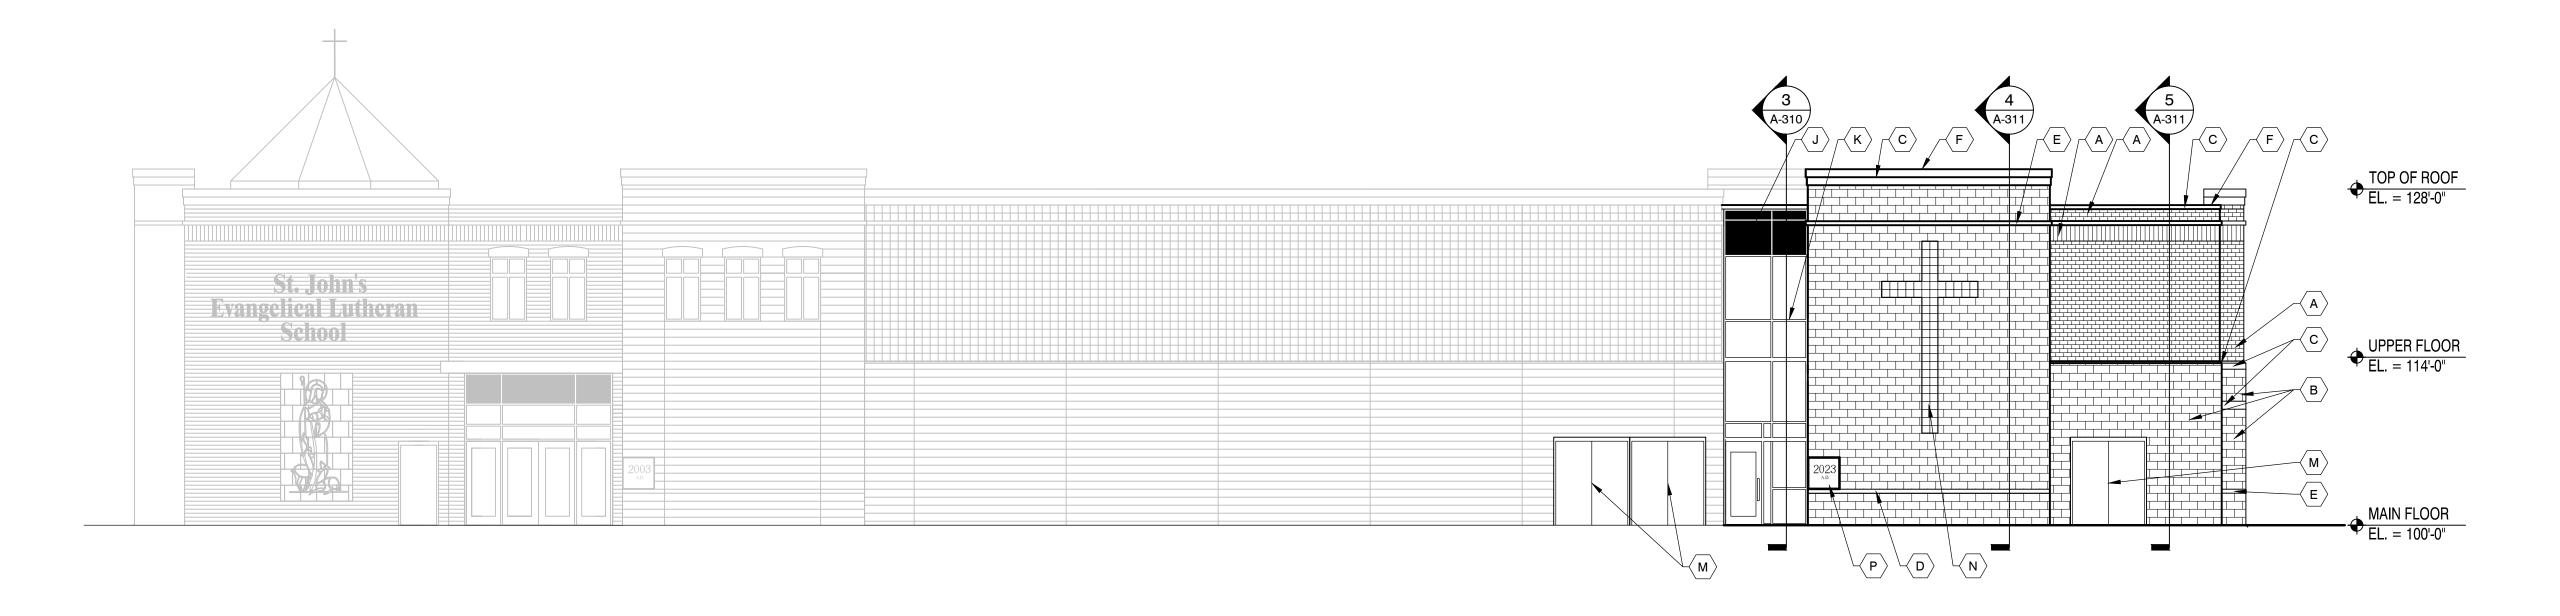

LOWER FLOOR EL. = 86'-0"

SOUTH ELEVATION

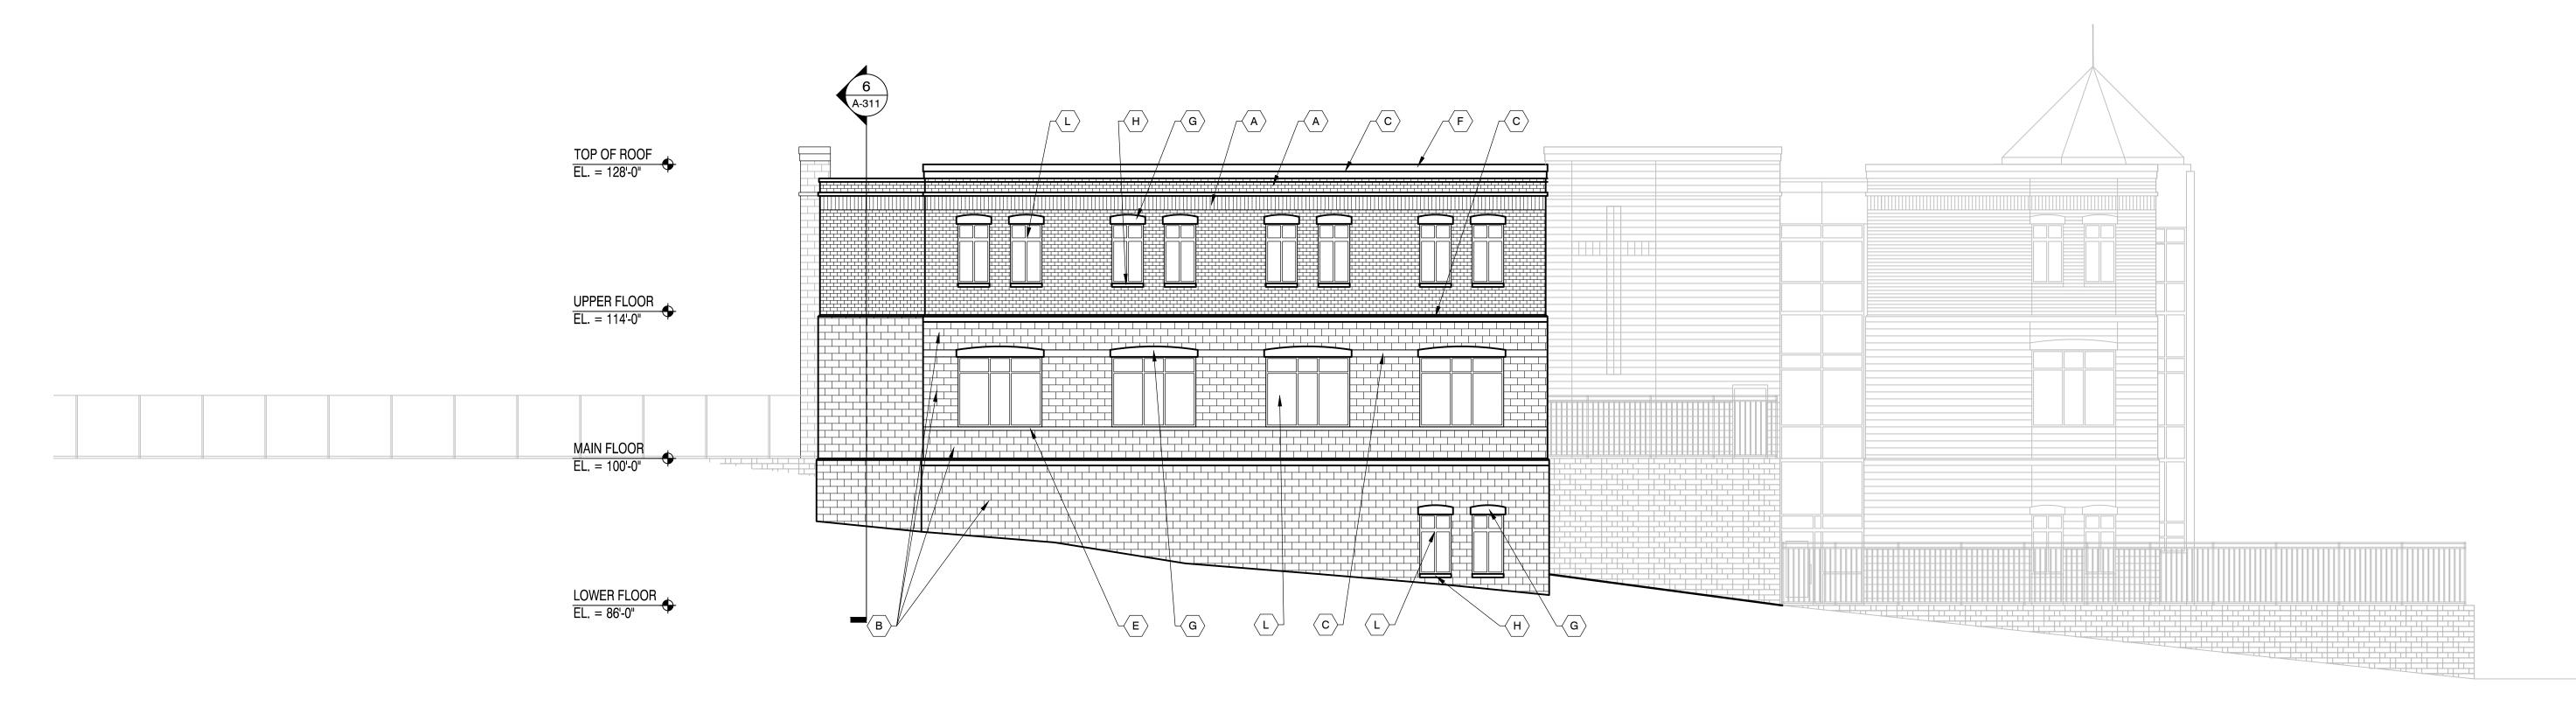

F - Prefinished parapet cap to match exist.

J - Prefinished metal panel to match exist.

H - Precast stone sill to match exist.

P - Cornerstone to match exist.

G - Precast stone arched header to match exist.

K - Prefinished alum. storefront frame & glass to match exist.

L - Alum. window frame & glass to match exist.

M - H. M. door & frame (paint to match wall)

N - Glass block to match exist.

# EXTERIOR BUILDING MATERIAL COLORS

- A Concrete brick units-Stria #43 Straw(5%) by Quality Block (or approved equal)
- B Split face units (8" high) #43 Straw(5%) by Quality Block (or approved equal)
- C Smooth face units (8" high) #43 Straw(5%) by Quality Block (or approved equal)
- O Split face units (4" high) #43 Straw(5%) by Quality Block (or approved equal)
- E Smooth face units (4" high) #43 Straw(5%) by Quality Block (or approved equal)

# Additional notes:

All concrete brick units to be laid with standard gray mortar All other units to be laid with matching colored mortar

Cap flashing and metal panel to be Siarra Tan by Una-Clad or equal Standing seam metal roof to be Patena Copper

Lannon Stone Colonial Blend by Halquist (or approved equal)

# **EAST ELEVATION**

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Wauwatosa, WI 53213

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rchitect: Engineer: Reviewed E Sheet Title: EXTERIOR ELEVATIONS

> Sheet Number: A-201

P13329

ELEVATIONS 1/8" = 1'-0"

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A-210
Project Number: P13329

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SOUTH ELEVATION



NORTHEAST ELEVATION



SOUTHWEST ELEVATION

RENDERING ELEVATIONS N.T.S.