DESIGN REVIEW BOARD SUBMISSION SUBMITTED 08/08/2023 FOR 08/17/2023 MEETING ST. JOHN'S EV. LUTHERAN CHURCH 7809 HARWOOD AVE, WAUWATOSA, WI 53213



CITY OF WAUWATOSA

BUILDING & SAFETY DIVISION

7725 WEST NORTH AVENUE, WAUWATOSA, WISCONSIN 53213

PHONE (414) 479-8907

FACSIMILE (414) 479-8986

E-MAIL: tbuilding@wauwatosa.net WEB SITE: www.wauwatosa.net

DESIGN REVIEW BOARDS

The Design Review Board is created to review and approve the exterior design and aesthetic aspects of building projects. Their purpose is to promote good design and continuity, which often impacts the overall appearance and property value of a neighborhood. Applicants are required to attend the meeting in order to address any of the Board's questions or concerns. Meetings are conducted at City Hall, 7725 West North Avenue, Wauwatosa, Wisconsin at 7:00 p.m. on the first and third Thursdays of each month (*unless otherwise noted). The application deadlines can be found in the schedule below.

HOW TO MAKE APPLICATION

- 1. It is suggested that you discuss the proposed application with the Building & Safety Division prior to submission, in the interest of having adequate information for the request.
- 2. The request shall consist of an online application through our Customer Service Portal accompanied by the following. *Incomplete submittals will not be considered*.
 - one digital copy of the plans (to scale). All elevations must be shown on the plans.
 - One digital copy of the land survey (to scale) and site plan with the proposed structure (with dimensions and distances from lot lines) drawn on each copy.
 - Y Photograph of the existing front elevation.
 - Photograph of the affected area to be built.
 - Me One digital copy of scaled drawings of the building elevations showing fenestration, materials and landscaping.
 - One digital copy of exterior lighting plans including lamp types, light pattern and fixture style.
 - One digital copy of samples of all exterior materials affected by the project, and physical samples dropped off in the Building & Safety Department. INLCUDED ON ELEVATION SHEETS
 - ★ Colored rendering of the proposed project.
 - Three color copy packets including the above requirements.
- A \$50 application fee is due at the time of the online submittal. Total fees are calculated based on the cost of a project
 or square footage, plus plan review. Plan review adds another \$100-\$500 depending on the scope of the project. PAID ONLINE
- 4. All applications and submittals must be completed online not later than the application date and time indicated below to be considered for the schedule's meeting date. The advance application date is necessary to meet legal notification requirements.

12:00 PM APPLICATION DATE	7:00 PM *MEETING DATE
December 27, 2022	January 5, 2023
January 10, 2023	January 19, 2023
January 24, 2023	February 2, 2023
February 7, 2023	February 16, 2023
February 21, 2023	March 2, 2023
March 7, 2023	March 16, 2023
April 11, 2023	April 20, 2023
April 25, 2023	May 4, 2023
May 9, 2023	May 18, 2023
May 23, 2023	June 1, 2023
June 6, 2023	June 15, 2023
June 27, 2023	July 6, 2023

12:00 PM APPLICATION DATE	7:00 PM *MEETING DATE
July 11, 2023	July 20, 2023
July 25, 2023	August 3, 2023
August 8, 2023	August 17, 2023
August 22, 2023	September 7, 2023
September 5, 2023	September 21, 2023
September 26, 2023	October 5, 2023
October 10, 2023	October 19, 2023
October 24, 2023	November 2, 2023
November 7, 2023	November 16, 2023
November 28, 2023	December 7, 2023
December 5, 2023	December 21, 2023

Questions?

Application related questions may be directed to the clerical staff (414-479-8907) anytime 8:00 a.m.-4:30 p.m. weekdays. The City code is available online at: www.wauwatosa.net.

St. John's Evangelical Lutheran Church

Project Address

7809 Harwood Ave.

Wauwatosa, WI 53213

Project Description

Proposed 3,925 SF building addition to the existing church/narthex to provide additional church office space, larger accessible restrooms, and a larger narthex for gathering before/after church services. The church will also remove an existing house on the property currently being used for a parsonage in order to gain additional space for parking. Additional parking spaces near the main entrance will be provided along with a covered canopy for visitors to be dropped.





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MSI GENERAL CORPORATION P.O. BOX. 7 OCONOMOWOC, WI 53066 PHONE: 262-367-3661 FAX: 262-367-7390

WWW.MSIGENERAL.COM
SINGLE SOURCE RESPONSIBILITY TM

ISSUE DATES:	
City Submittal	06/07/2023
Design Review Board:	08/07/2023
Proposal:	xx/xx/xxxx
Bid:	xx/xx/xxxx
Contract:	xx/xx/xxxx
State Submittal / Permit:	xx/xx/xxxx
As-Built:	xx/xx/xxxx
REVISIONS:	
1	
2	
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PROJECT ADDRESS:

PROJECT NAME
St. John's Evangelical Lutheran Church
STREET ADDRESS
7809 Harwood Ave.
CITY/ STATE / ZIP
Wauwatosa, WI 53213

ALL WORK TO BE COMPLETED AS SHOWN, AND IN
ACCORDANCE WITH THE LATEST EDITION OF THE
MSI GENERAL MASTER SPECIFICATION


Architect: Engineer: Reviewed By:
AMH -- -Sheet Title:
COVER SHEET
Sheet Number:
G-001
Project Number:

P13586

ARCHITECTS

CERTIFIED SURVEY MAP NO.

Being a redivision of Lot 1 of DOUGLAS HEIGHTS, Lot 9 of ASSESSOR'S PLAT NO. 26 and Lots 1 and 2 of CHARLES FINGADO'S SUBDIVISION, being part of the Southeast 1/4 of the Southeast 1/4 Section 21, Town 7 North, Range 21 East, in the City of Wauwatosa, Milwaukee County, Wisconsin.

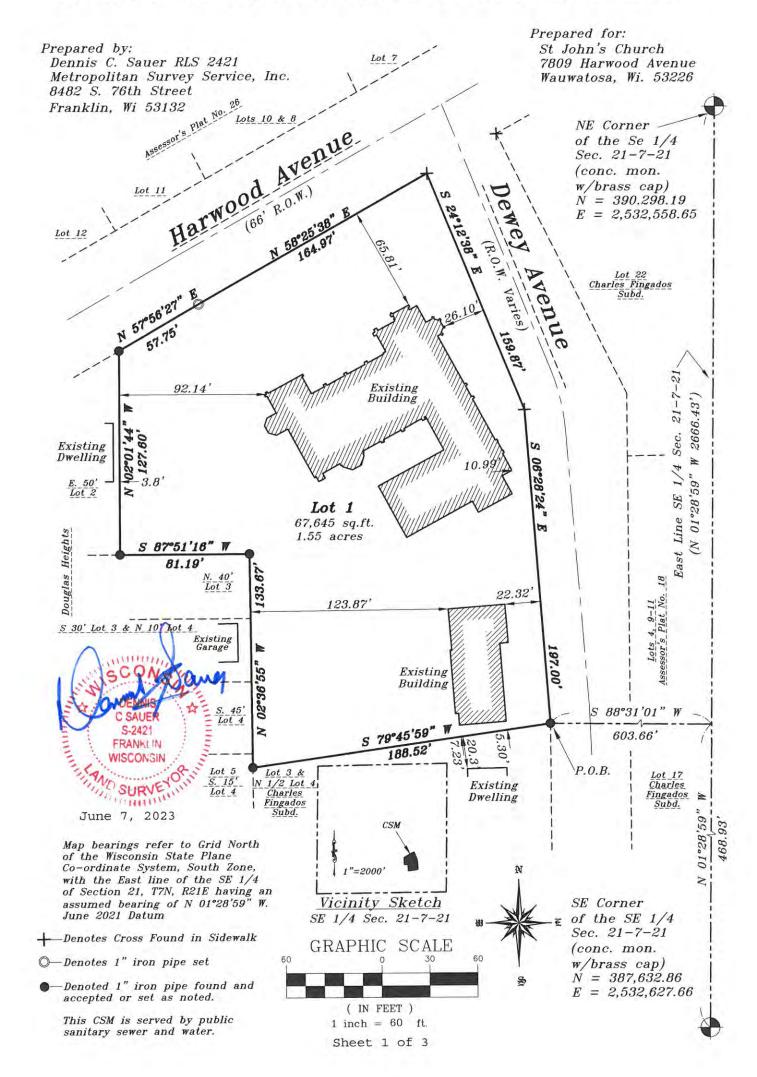

CERTIFIED	SURVEY	MAP	NO	
CERTTETE	DOKARI	TITTE	TAO.	

Being a redivision of Lot 1 in Douglas Heights, Lot 9 of Assessor's Plat No. 26 and Lots 1 and 2 of Charles Fingado's Subdivision, being part of the Southeast 1/4 of the Southeast 1/4 of Section 21, Town 7 North, Range 21 East, in the City of Wauwatosa, Milwaukee County, Wisconsin.

SURVEYOR'S CERTIFICATE

STATE OF WISCONSIN)
MILWAUKEE COUNTY) SS

I, Dennis C. Sauer, registered land surveyor, hereby certify that:

I have surveyed, divided and mapped a redivision of the West 50 feet of Lot 1, in Douglas Heights, and Lot 9 of Assessor's Plat No. 26 and Lots 1 and 2 of Charles Fingado's Subdivision and the East 31.3 feet of Lot 1 of Douglas Heights Subdivision, being part of the Southeast 1/4 of the Southeast 1/4 of Section 21, Town 7 North, Range 21 East, in the City of Wauwatosa, Milwaukee County, Wisconsin, bounded and described as follows: Commencing at the Southeast corner of said Southeast 1/4; thence N 01°28'59" W along the East line of said Southeast 1/4, 468.93; thence S 88°31'01" W, 603.66 feet to the West right-of-way line of Dewey Avenue and the point of beginning; thence S 79°45'59" W, 188.52 feet; thence N 02°36'55" W, 133.67 feet; thence S 87°51'16" W, 81.19 feet; thence N 02°01'44" W, 127.60 feet to southeasterly right-of-way line of Harwood Avenue; thence N 57°56'27" E along said southeasterly right-of-way line, 57.75 feet; thence N 58°25'38" E along said southeasterly right-of-way line, 164.97 feet to the West right-of-way line of Dewey Avenue; thence S 24°12'38" E along said West right-of-way line, 159.87 feet; thence S 06°28'24" W along said West right-of-way line, 197.00 feet to the point of beginning. Said lands containing 67,645 square feet (1.55 acres).

That I have made such survey, land division and map by the direction of St. John's Evangelical Church, owner of said land.

That such map is a correct representation of all exterior boundaries of the land surveyed and the land division thereof made.

That I have fully complied with the provisions of Chapter 236.34 of the Wisconsin State Statutes and the Regulations of the City of Wauwatosa in surveying, dividing and mapping the same.

June 7, 2023

Date

DENNIS
C SAUER
S-2421
FRANKLIN
NISCONSIN

Dennis C. Sauer

Registered Land Surveyor S-2421

PREPARED FOR: St. John's Evangelical Church 7809 Harwood Avenue Wauwatosa, WI 53226 PREPARED BY: Metropolitan Survey Service 8482 South 76th Street Franklin, WI 53132

Being a redivision of Lot 1 of Douglas Heights, Lot 9 of Assessor's Plat No. 26 and Lots 1 and 2 of Charles Fingado's Subdivision, being part of the Southeast 1/4 of the Southeast 1/4 of Section 21, Town 7 North, Range 21 East, in the City of Wauwatosa, Milwaukee County, Wisconsin.
CORPORATE OWNER'S CERTIFICATE OF DEDICATION
St. John's Evangelical Church, a Wisconsin corporation duly organized and existing under and by virtue of the laws of the State of Wisconsin St. as owner, does hereby certify that it has caused the land described on this map to be surveyed, divided and mapped as represented on this map in accordance with the requirements of Chapter 236.34 of the Wisconsin State Statutes and the Regulations of the City of Wauwatosa.
IN WITNESS WHEREOF, the said St. John's Evangelical Church has caused these presents to be signed by Peter Hanson, President of St. John's Evangelical Church, this day of, 20
Peter Hanson, President
STATE OF WISCONSIN) MILWAUKEE COUNTY) ss
PERSONALLY came before me this day of, 20, Peter Hanson, President of St. John's Evangelical Church to me known to be the person who executed the foregoing instrument and acknowledged the same.
Notary Public
State of Wisconsin
My Commission Expires:
COMMON COUNCIL APPROVAL
APPROVED and DEDICATED by the Common Council of the City of Wauwatosa in accordance with resolution adopted on this day of, 20
Steven Braatz, City Clerk
PLANNING COMMISSION APPROVAL
APPROVED and DEDICATED by the Planning Commission of the City of Wauwatosa in accordance with resolution adopted on this day of, 20
Dennis McBride, Chair, Mayor Zachary Kessler, Deputy Clerk
NE COMMON DEVINE

CERTIFIED SURVEY MAP NO.

THIS INSTRUMENT WAS DRAFTED BY: Dennis C. Sauer, R.L.S. S-2421 June 7, 2023

PHONE: 262-367-3661

GINEER

PROJECT ADDRESS: PROJECT NAME


St. John's Evangelical Lutheran Church STREET ADDRESS 7809 Harwood Ave. CITY/ STATE / ZIP Wauwatosa, WI 53213

ALL WORK TO BE COMPLETED AS SHOWN, AND IN ACCORDANCE WITH THE LATEST EDITION OF THE MSI GENERAL MASTER SPECIFICATION

Engineer: Reviewed By: RWI AMH APM SITE PLAN

Sheet Number: C-200 ARCHITECTS

P13586

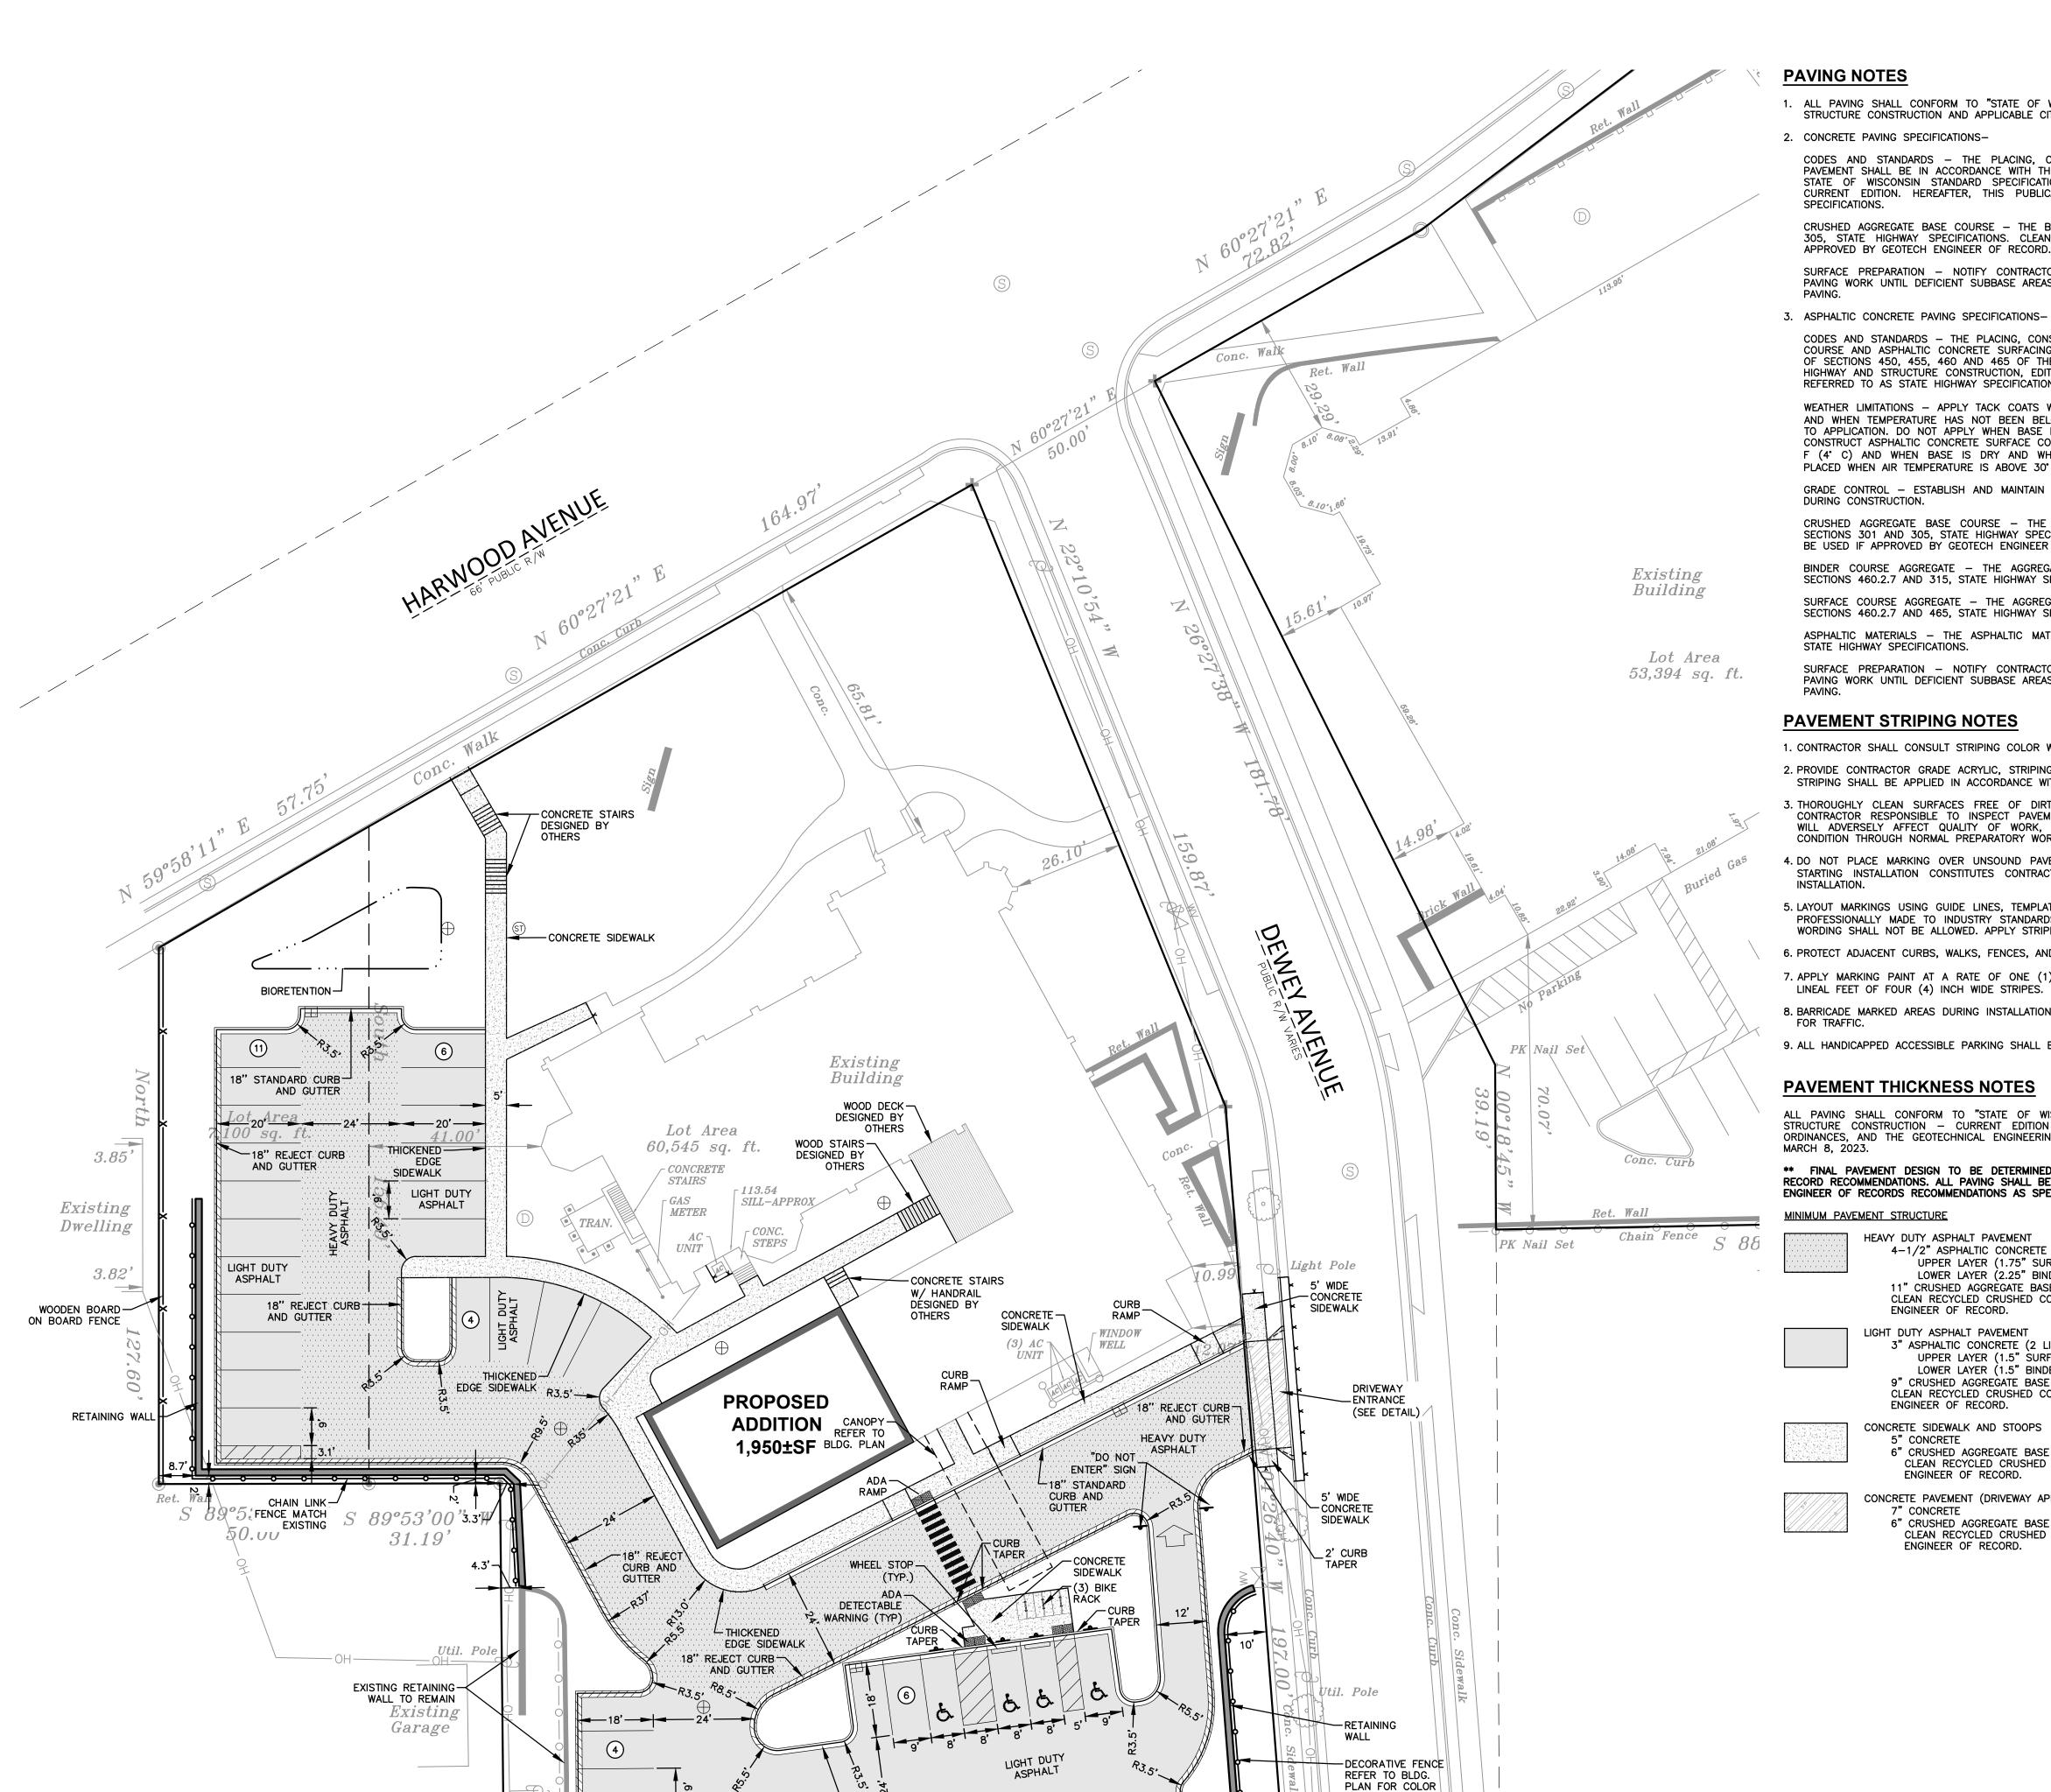

-18" REJECT CURB

-RETAINING

FENCE MATCH

Existing

AND GUTTER

CONTRACTOR TO CONFIRM

EXISTING WALL IS LOW ENOUGH FOR PROPOSED ELEVATIONS, IF NOT

REMOVE AND REPLACE

BURIED DEPTH OF

WALL AS NEEDED

Util. Pole

AND STYLE

-5' WIDE)+

SIDEWALK

-30" STANDARD

CURB AND

ALL PAVING SHALL CONFORM TO "STATE OF WISCONSIN STANDARD SPECIFICATIONS FOR HIGHWAY & 1. THE INTENTION OF THE PLANS AND SPECIFICATIONS IS TO SET FORTH PERFORMANCE AND STRUCTURE CONSTRUCTION AND APPLICABLE CITY OF WAUWATOSA ORDINANCES.

CONSTRUCTION MATERIAL STANDARDS FOR THE PROPER EXECUTION OF WORK. ALL WORKS CONTAINED STRUCTURE CONSTRUCTION AND APPLICABLE CITY OF WAUWATOSA ORDINANCES.

2. CONCRETE PAVING SPECIFICATIONS-CODES AND STANDARDS - THE PLACING, CONSTRUCTION AND COMPOSITION OF THE CONCRET PAVEMENT SHALL BE IN ACCORDANCE WITH THE REQUIREMENTS OF SECTIONS 415 AND 416 OF THE 2. THE CONTRACTOR IS RESPONSIBLE FOR PERFORMING ANY ADDITIONAL SOILS INVESTIGATIONS THEY STATE OF WISCONSIN STANDARD SPECIFICATIONS FOR HIGHWAY AND STRUCTURE CONSTRUCTION, CURRENT EDITION. HEREAFTER, THIS PUBLICATION WILL BE REFERRED TO AS STATE HIGHWAY

CRUSHED AGGREGATE BASE COURSE - THE BASE COURSE SHALL CONFORM TO SECTIONS 301 AND 305, STATE HIGHWAY SPECIFICATIONS. CLEAN RECYCLED CRUSHED CONCRETE MAY BE USED IF APPROVED BY GEOTECH ENGINEER OF RECORD. SURFACE PREPARATION - NOTIFY CONTRACTOR OF UNSATISFACTORY CONDITIONS. DO NOT BEGIN

PAVING WORK UNTIL DEFICIENT SUBBASE AREAS HAVE BEEN CORRECTED AND ARE READY TO RECEIVE

CODES AND STANDARDS — THE PLACING, CONSTRUCTION AND COMPOSITION OF THE ASPHALTIC BASE COURSE AND ASPHALTIC CONCRETE SURFACING SHALL BE IN ACCORDANCE WITH THE REQUIREMENTS OF SECTIONS 450, 455, 460 AND 465 OF THE STATE OF WISCONSIN STANDARD SPECIFICATIONS FOR HIGHWAY AND STRUCTURE CONSTRUCTION, EDITION OF 2005. HEREAFTER, THIS PUBLICATION WILL BE REFERRED TO AS STATE HIGHWAY SPECIFICATIONS.

WEATHER LIMITATIONS - APPLY TACK COATS WHEN AMBIENT TEMPERATURE IS ABOVE 50° F (10° C) AND WHEN TEMPERATURE HAS NOT BEEN BELOW 35° F (1° C) FOR 12 HOURS IMMEDIATELY PRIOR TO APPLICATION. DO NOT APPLY WHEN BASE IS WET OR CONTAINS EXCESS AMOUNTS OF MOISTURE. CONSTRUCT ASPHALTIC CONCRETE SURFACE COURSE WHEN ATMOSPHERIC TEMPERATURE IS ABOVE 40° F (4° C) AND WHEN BASE IS DRY AND WHEN WEATHER IS NOT RAINY. BASE COURSE MAY BE PLACED WHEN AIR TEMPERATURE IS ABOVE 30° F $(-1^{\circ} C)$.

GRADE CONTROL - ESTABLISH AND MAINTAIN REQUIRED LINES AND ELEVATIONS FOR EACH COURSE CRUSHED AGGREGATE BASE COURSE - THE TOP LAYER OF BASE COURSE SHALL CONFORM TO SECTIONS 301 AND 305, STATE HIGHWAY SPECIFICATIONS. CLEAN RECYCLED CRUSHED CONCRETE MAY

BE USED IF APPROVED BY GEOTECH ENGINEER OF RECORD. BINDER COURSE AGGREGATE - THE AGGREGATE FOR THE BINDER COURSE SHALL CONFORM TO SECTIONS 460.2.7 AND 315, STATE HIGHWAY SPECIFICATIONS. SURFACE COURSE AGGREGATE - THE AGGREGATE FOR THE SURFACE COURSE SHALL CONFORM TO SECTIONS 460.2.7 AND 465, STATE HIGHWAY SPECIFICATIONS. ASPHALTIC MATERIALS - THE ASPHALTIC MATERIALS SHALL CONFORM TO SECTION 455 AND 460, SURFACE PREPARATION - NOTIFY CONTRACTOR OF UNSATISFACTORY CONDITIONS. DO NOT BEGIN

PAVING WORK UNTIL DEFICIENT SUBBASE AREAS HAVE BEEN CORRECTED AND ARE READY TO RECEIVE

PAVEMENT STRIPING NOTES

- 1. CONTRACTOR SHALL CONSULT STRIPING COLOR WITH OWNER PRIOR TO CONSTRUCTION. 2. PROVIDE CONTRACTOR GRADE ACRYLIC, STRIPING PAINT FOR NEW ASPHALT OR COATED ASPHALT. ALI STRIPING SHALL BE APPLIED IN ACCORDANCE WITH MANUFACTURER'S SPECIFICATIONS.
- 3. THOROUGHLY CLEAN SURFACES FREE OF DIRT, SAND, GRAVEL, OIL AND OTHER FOREIGN MATTER. CONTRACTOR RESPONSIBLE TO INSPECT PAVEMENT SURFACES FOR CONDITIONS AND DEFECTS THAT WILL ADVERSELY AFFECT QUALITY OF WORK, AND WHICH CANNOT BE PUT INTO AN ACCEPTABLE CONDITION THROUGH NORMAL PREPARATORY WORK AS SPECIFIED.
- 4. DO NOT PLACE MARKING OVER UNSOUND PAVEMENTS. IF THESE CONDITIONS EXIST, NOTIFY OWNER. 15. ALL FIELD/DRAIN TILE ENCOUNTERED DURING CONSTRUCTION OPERATIONS SHALL BE IMMEDIATELY STARTING INSTALLATION CONSTITUTES CONTRACTOR'S ACCEPTANCE OF SURFACE AS SUITABLE FOR
- 5. LAYOUT MARKINGS USING GUIDE LINES, TEMPLATES AND FORMS. STENCILS AND TEMPLATES SHALL BE PROFESSIONALLY MADE TO INDUSTRY STANDARDS. "FREE HAND" PAINTING OF ARROWS, SYMBOLS, OR WORDING SHALL NOT BE ALLOWED. APPLY STRIPES STRAIGHT AND EVEN.
- 6. PROTECT ADJACENT CURBS, WALKS, FENCES, AND OTHER ITEMS FROM RECEIVING PAINT. 7. APPLY MARKING PAINT AT A RATE OF ONE (1) GALLON PER THREE TO FOUR HUNDRED (300-400)
- LINEAL FEET OF FOUR (4) INCH WIDE STRIPES. (OR TO MFG. SPECIFICATIONS) 8. BARRICADE MARKED AREAS DURING INSTALLATION AND UNTIL THE MARKING PAINT IS DRIED AND READY
- 9. ALL HANDICAPPED ACCESSIBLE PARKING SHALL BE LOCATED PER 2009 IBC 1106.6

PAVEMENT THICKNESS NOTES

ALL PAVING SHALL CONFORM TO "STATE OF WISCONSIN STANDARD SPECIFICATIONS FOR HIGHWAY & STRUCTURE CONSTRUCTION - CURRENT EDITION AND ADDENDUM, APPLICABLE CITY OF WAUWATOSA ORDINANCES, AND THE GEOTECHNICAL ENGINEERING SERVICES REPORT PREPARED BY CGC INC., DATED

** FINAL PAVEMENT DESIGN TO BE DETERMINED BY OWNER BASED ON GEOTECHNICAL ENGINEER OF RECORD RECOMMENDATIONS. ALL PAVING SHALL BE PERFORMED IN ACCORDANCE WITH THE GEOTECHNICAL ENGINEER OF RECORDS RECOMMENDATIONS AS SPECIFIED IN THE SAID GEOTECHNICAL REPORT.

MINIMUM PAVEMENT STRUCTURE

HEAVY DUTY ASPHALT PAVEMENT 4-1/2" ASPHALTIC CONCRETE (2 LIFTS, 3" BINDER, 1-1/2" SURFACE) UPPER LAYER (1.75" SURFACE, 5LT 58.28 S) LOWER LAYER (2.25" BINDER, 4LT 58.28 S) 11" CRUSHED AGGREGATE BASE COURSE (1-1/4" DENSE GRADED LIMESTONE) CLEAN RECYCLED CRUSHED CONCRETE MAY BE USED IF APPROVED BY GEOTECH ENGINEER OF RECORD.

LIGHT DUTY ASPHALT PAVEMENT 3" ASPHALTIC CONCRETE (2 LIFTS, 1-1/2" BINDER, 1-1/2" SURFACE) UPPER LAYER (1.5" SURFACE, 5LT 58.28 S) LOWER LAYER (1.5" BINDER, 4LT 58.28 S) 9" CRUSHED AGGREGATE BASE COURSE (1-1/4" DENSE GRADED LIMESTONE) CLEAN RECYCLED CRUSHED CONCRETE MAY BE USED IF APPROVED BY GEOTECH

ENGINEER OF RECORD. CONCRETE SIDEWALK AND STOOPS 5" CONCRETE

ENGINEER OF RECORD.

6" CRUSHED AGGREGATE BASE COURSE CLEAN RECYCLED CRUSHED CONCRETE MAY BE USED IF APPROVED BY GEOTECH ENGINEER OF RECORD.

CONCRETE PAVEMENT (DRIVEWAY APPROACH) 7" CONCRETE 6" CRUSHED AGGREGATE BASE COURSE (1-1/4" DENSE GRADED LIMESTONE) CLEAN RECYCLED CRUSHED CONCRETE MAY BE USED IF APPROVED BY GÉOTECH

PRE-DEVELOPMENT (PROPERTY* LIMIT): PERVIOUS - 34,691 SF (51.3% GREEN SPACE) IMPERVIOUS - 32,954 SF POST-DEVELOPMENT (PROPERTY* LIMIT):

PERVIOUS - 28,311 SF (41.9% GREEN SPACE) IMPERVIOUS - 39,334 SF

* PROPERTY BASED ON SURVEY BY OTHER.

GENERAL NOTES AND SPECIFICATIONS

WITHIN THE PLANS AND SPECIFICATIONS SHALL BE COMPLETED IN ACCORDANCE WITH ALL REQUIREMENTS FROM LOCAL, STATE, FEDERAL OR OTHER GOVERNING AGENCY'S LAWS, REGULATIONS,

FEEL IS NECESSARY FOR THE PROPER EVALUATION OF THE SITE FOR PURPOSES OF PLANNING,

3. THE CONTRACTOR IS RESPONSIBLE TO REVIEW AND UNDERSTAND ALL COMPONENTS OF THE PLANS

AND SPECIFICATIONS, INCLUDING FIELD VERIFYING SOIL CONDITIONS, PRIOR TO SUBMISSION OF A BID

THE CONTRACTOR SHALL PROMPTLY REPORT ANY ERRORS OR AMBIGUITIES DISCOVERED AS PART OF

5. THE CONTRACTOR IS SOLELY RESPONSIBLE FOR THE COMPUTATION OF QUANTITIES AND WORK REQUIRED TO COMPLETE THIS PROJECT. THE CONTRACTOR'S BID SHALL BE BASED ON THEIR OWN

3. QUESTIONS/CLARIFICATIONS WILL BE INTERPRETED BY ENGINEER/OWNER PRIOR TO THE AWARD OF

PRIOR TO START OF WORK, CONTRACTOR SHALL BE COMPLETELY FAMILIAR WITH ALL CONDITIONS (

THE SITE, AND SHALL ACCOUNT FOR CONDITIONS THAT AFFECT, OR MAY AFFECT CONSTRUCTION

INCLUDING, BUT NOT LIMITED TO, LIMITATIONS OF WORK ACCESS, SPACE LIMITATIONS, OVERHEAD

OBSTRUCTIONS. TRAFFIC PATTERNS, LOCAL REQUIREMENTS, ADJACENT ACTIVITIES, ETC. FAILURE TO

. COMMENCEMENT OF CONSTRUCTION SHALL EXPLICITLY CONFIRM THAT THE CONTRACTOR HAS REVIEWED THE PLANS AND SPECIFICATIONS IN THEIR ENTIRETY AND CERTIFIES THAT THEIR SUBMITTED BID PROPOSAL CONTAINS PROVISIONS TO COMPLETE THE PROJECT, WITH THE EXCEPTION OF UNFORESEEN

FIELD CONDITIONS; ALL APPLICABLE PERMITS HAVE BEEN OBTAINED; AND CONTRACTOR UNDERSTANDS

THE AWARD OF CONTRACT, ENGINEER SHALL BE NOTIFIED IN WRITING IMMEDIATELY AND CONSTRUCTION OF ITEMS AFFECTED BY THE DISCREPANCIES/CONFLICTS SHALL NOT COMMENCE, OR CONTINUE, UNTIL

A WRITTEN RESPONSE FROM ENGINEER/OWNER IS DISTRIBUTED. IN THE EVENT OF A CONFLICT

BETWEEN REFERENCED CODES, STANDARDS, SPECIFICATIONS AND PLANS, THE ONE ESTABLISHING THE

COMPLETE THE PROJECT. OBTAINING PERMITS, OR DELAYS IN OBTAINING PERMITS, IS NOT CAUSE FOR

DELAY OF THE CONTRACT OR SCHEDULE. CONTRACTOR SHALL COMPLY WITH ALL PERMIT

10. THE CONTRACTOR SHALL, AT ITS OWN EXPENSE, OBTAIN ALL NECESSARY PERMITS AND LICENSES TO

11. THE CONTRACTOR SHALL NOTIFY ALL INTERESTED GOVERNING AGENCIES, UTILITY COMPANIES AFFECTED

12. SAFETY IS THE SOLE RESPONSIBILITY OF THE CONTRACTOR. THE CONTRACTOR SHALL BE RESPONSIBLE

13. CONTRACTOR SHALL KEEP THE JOBSITE CLEAN AND ORDERLY AT ALL TIMES. ALL LOCATIONS OF THE SITE SHALL BE KEPT IN A WORKING MANNER SUCH THAT DEBRIS IS REMOVED CONTINUOUSLY AND

14. THE CONTRACTOR SHALL INDEMNIFY THE OWNER, JSD, AND THEIR AGENTS FROM ALL LIABILITY

INVOLVED WITH THE CONSTRUCTION, INSTALLATION, AND TESTING OF THE WORK ON THIS PROJECT.

REPORTED TO ENGINEER/OWNER. TILES ORIGINATING OUTSIDE THE PROJECT LIMITS SHALL BE RECONNECTED OR REPOUTED TO MAINTAIN DRAINAGE, ENGINEER/OWNER SHALL DETERMINE THE MOST FAVORABLE METHOD OF RE-ESTABLISHMENT OF OFFSITE DRAINAGE. IF TILE IS ENCOUNTERED DURING

TRENCH EXCAVATIONS, RE-ESTABLISHING TILE FUNCTIONALITY SHALL BE CONSIDERED AN INCIDENTAL

16. ALL WORK WITHIN CITY RIGHT-OF-WAY AND CITY EASEMENTS TO BE IN ACCORDANCE WITH CURRENT

17. LIMITS OF FINAL CITY STREET PAVEMENT AND CURB AND GUTTER REMOVAL AND REPLACEMENTS TO

18. PROPOSED PAVEMENT RESTORATION LIMITS IN CITY STREET FOR DRIVEWAY APPROACH REMOVALS ARE SHOWN ARE MINIMUM AREAS. THE CITY REQUIRES PAVEMENT PATCHES TO BE WIDTH TO MATCH

19. ALL WORK WITHIN THE PUBLIC RIGHT OF WAY REQUIRES A STREET OCCUPANCY PERMIT FROM THE

CITY STANDARD SPECIFICATIONS AND DETAILS. CONTRACTOR TO NOTIFY CITY ENGINEERING DEPT. 5

ALL RESPECTIVE CONTRACTORS OPERATE UNDER GENERAL "GOOD HOUSEKEEPING."

TO INITIATE, INSTITUTE, ENFORCE, MAINTAIN, AND SUPERVISE ALL SAFETY PRECAUTIONS AND JOB SITE

BY THIS CONSTRUCTION PROJECT, AND "DIGGER'S HOTLINE" IN ADVANCE OF CONSTRUCTION TO

COMPLY WITH ALL JURISDICTIONAL ORDINANCES/CODES/RULES/ETC., PERMIT STIPULATIONS, AND OTHER APPLICABLE STANDARDS. CONTRACTOR IS RESPONSIBLE TO DETERMINE WHICH

9. SHOULD ANY DISCREPANCIES OR CONFLICTS IN THE PLANS OR SPECIFICATIONS BE DISCOVERED AFTER

CONTRACT. IN NO WAY SHALL WORD-OF-MOUTH DIALOG CONSTITUTE AN OFFICIAL RESPONSE.

CONTRACT. ENGINEER/OWNER WILL SUBMIT OFFICIAL RESPONSES IN WRITING. INTERPRETATIONS

RESENTED IN OFFICÍAL RESPONSES SHALL BE BINDING ON ALL PARTIES ASSOCIATED WITH THE

COMPUTATIONS AND UNDER NO CIRCUMSTANCES BE BASED ON THE ENGINEER'S ESTIMATE.

JURISDICTIONAL ORDINANCES/CODES/RULES/ETC., AND THE OWNER'S DIRECTION.

THEIR REVIEW OF PLANS, SPECIFICATIONS, REPORTS AND FIELD INVESTIGATIONS.

CONSIDER SITE CONDITIONS SHALL NOT BE CAUSE FOR CLAIM OF JOB EXTRAS.

ALL OF THE REQUIREMENTS OF THE PROJECT.

MOST STRINGENT REQUIREMENTS SHALL BE FOLLOWED.

ORDINANCES/CODES/RULES/ETC. ARE APPLICABLE.

SAFETY PROGRAMS IN CONNECTION WITH THE WORK.

DAYS PRIOR TO WORK IN CITY RIGHT OF WAY.

LENGTH, OR TO CENTERLINE OF STREET.


BE MARKED BY CITY ENGINEERING STAFF IN FIELD.

BIDDING, OR CONSTRUCTING THE PROJECT AT NO ADDITIONAL COST TO THE OWNER.

PRE-DEVELOPMENT ONSITE PARKING STALLS: TOTAL PARKING STALLS - 30 ADA PARKING STALLS - 4 STANDARD PARKING STALLS - 21 NON-STRIPED PARKING STALLS - 5 POST-DEVELOPMENT ONSITE PARKING STALLS: TOTAL PARKING STALLS - 45 ADA PARKING STALLS - 4 STANDARD PARKING STALLS - 41 BIKE PARKING STALLS - 6

LEGEND

STORM MANHOLE CATCH BASIN ROUND -----RD------ ROOF DRAIN CATCH BASIN SQUARE FIRE HYDRANT WATER VALVE T UNDERGROUND TELEPHONE GAS VALVE X LIGHT POLE -----OH-------OVERHEAD UTILITY TELEPHONE PEDESTAL ELECTRICAL MANHOLE 18" STANDARD CURB AND GUTTER SIGN 18" HIGH SIDE CURB AND GUTTER Ø POWER POLE --- GUY WIRE CONIFEROUS TREE

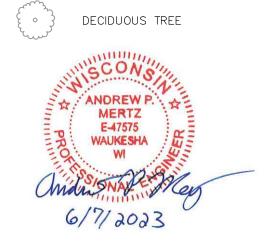



north

P. 262.513.0666

JSD PROJ. NO.: 22-11646

JSD PROJ. MGR.: RWI

Call 811 or (800) 242-8511 Milwaukee Area (262) 432-7910 Hearing Impaired TDD (800) 542-2289

www.DiggersHotline.com

ENGINEERS

PROJECT ADDRESS:

PROJECT NAME St. John's Evangelical Lutheran Church STREET ADDRESS 7809 Harwood Ave. CITY/ STATE / ZIP Wauwatosa, WI 53213

ALL WORK TO BE COMPLETED AS SHOWN, AND IN ACCORDANCE WITH THE LATEST EDITION OF THE

Engineer: Reviewed By: APM RWI LANDSCAPE PLAN

Sheet Number:

RCHITECT



01-DECIDUOUS TREES	CODE	QTY	BOTANICAL / COMMON NAME	CONT	SIZE
	SSM	2	Acer miyabei 'Morton' TM / State Street Miyabei Maple	B & B	2.5"Cal
	AFRM	8	Acer rubrum 'Autumn Flame' / Autumn Flame Red Maple	B & B	2.5"Cal
	SMH	4	Gleditsia triacanthos inermis 'Shademaster' TM / Shademaster Locust	B & B	2.5"Cal
03-ORNAMENTAL TREES	CODE	QTY	BOTANICAL / COMMON NAME	CONT	SIZE
	RHS	2	Amelanchier x grandiflora 'Robin Hill' / Robin Hill Apple Serviceberry	B & B	6' Tall (Multi—Stem)
	HRB	4	Betula nigra 'Cully' TM / Heritage River Birch	B & B	7' Tall (Multi-Stem)
\odot	АМ	1	Magnolia x 'Ann' / Ann Magnolia	B & B	2"Cal
4-UPRIGHT EVERGREEN SHRUB	CODE	QTY	BOTANICAL / COMMON NAME	CONT	SIZE
	то	10	Thuja occidentalis 'Emerald' / Emerald Arborvitae	B & B	4' Tall
	EA	13	Thuja occidentalis 'Emerald' / Emerald Arborvitae	B & B	4' Tall
DECIDUOUS SHRUBS	CODE	QTY	BOTANICAL / COMMON NAME	CONT	SIZE
	АН	8	Hydrangea arborescens 'Annabelle' / Annabelle Hydrangea	Cont.	#3
+	DNB	6	Physocarpus opulifolius 'Monlo' TM / Diabolo Purple Ninebark	B & B	36" Tall
\odot	GLS	47	Rhus aromatica 'Gro-Low' / Gro-Low Fragrant Sumac	Cont.	#3
	GFS	20	Spiraea japonica 'Goldflame' / Goldflame Japanese Spirea	Cont.	#3
\odot	GMS	8	Spiraea japonica 'Goldmound' / Goldmound Japanese Spirea	Cont.	#3
\odot	DKL	5	Syringa meyeri 'Palibin' / Dwarf Korean Lilac	B & B	24" Tall
(.)	CPL	6	Syringa vulgaris / Common Lilac	B & B	36" Tall
EVERGREEN SHRUBS	CODE	QTY	BOTANICAL / COMMON NAME	CONT	SIZE
3 + £	КСЈ	9	Juniperus chinensis 'Kallays Compact' / Kallay Compact Pfitzer Juniper	Cont.	#5
**	EY	21	Taxus x media 'Everlow' / Everlow Yew	B & B	24" Tall
PERENNIALS & GRASSES	CODE	QTY	BOTANICAL / COMMON NAME	CONT	SIZE
€;3	MTD	69	Hemerocallis x 'Mary Todd' / Mary Todd Daylily	Cont.	#1
Ž.,	SWD	6	Hemerocallis x 'Summer Wine' / Summer Wine Daylily	Cont.	#1
	AFH	8	Hosta x 'Autumn Frost' / Autumn Frost Plantain Lily	Cont.	#1
*	HMSG	50	Panicum virgatum 'Heavy Metal' / Heavy Metal Switch Grass	Cont.	#1
	-	•			

BIORENTION BASIN PLUGS

Botanical Name	Common Name	Spacing	Quantity
Permanent Grasses:			
Carex grayii	Common Bur Sedge	12" O.C.	48
Carex stipata	Common Fox Sedge	12" O.C.	48
Panicum virgatum	Switch Grass	12" O.C.	48
Spartina pectinata	Prairie Cord Grass	12" O.C.	48
Forbs:			
Aster novae-angilae	New England Aster	12" O.C.	24
Asclepias incarnata	Swamp Milkweed	12" O.C.	24
Echinacea purpurea	Broad-Leaved Purple Coneflower	12" O.C.	24
Eryngium yuccifolium	Rattlesnake Master	12" O.C.	24
Eupatorium maculatum	Spotted Joe-Pye Weed	12" O.C.	24
Liatris spicata	Marsh Blazing Star	12" O.C.	24
Lobelia cardinalis	Cardinal Flower	12" O.C.	24
Monarda fistulosa	Wild Bergamot	12" O.C.	24
Penstemon digitalis	Foxglove Beardtongue	12" O.C.	24
Pycnanthemum virginianum	Common Mountain Mint	12" O.C.	24
Ratibida pinnata	Yellow Coneflower	12" O.C.	24
Rudbeckia hirta	Black-Eyed Susan	12" O.C.	24
Veronicastrum virginianum	Culver's Root	12" O.C.	24
Zizia aurea	Golden Alexanders	12" O.C.	24



Landscape Requirement:	2 Deciduous Trees + 8 Shrubs per 50 LF
Calculation:	80 LF / 50 = 1.6
Calculation.	(1.6 x 2 Trees = 3.2 Trees) + (1.6 x 8 Shrubs = 12.8 Shrubs)
Required:	4 Trees + 13 Shrubs
•	•
Provided:	4 Trees + 24 Shrubs + 24 Perennials
Sec. 24.12.020 PERI	METER VEHICULAR ACCESS AREA (EAST) (100
Landscape Requirement:	2 Deciduous Trees + 8 Shrubs per 50 LF
Calculation:	100 LF / 50 = 2
	(2 x 2 Trees = 4 Trees) + (2 x 8 Shrubs = 16 Shrubs)
Required:	4 Trees + 16 Shrubs
Provided:	4 Trees + 21 Shrubs + 21 Perennials
Sec. 24.12.030 INTE	RIOR VEHICULAR ACCESS AREA (NORTH) (7,
Landscape Requirement:	At least 10% must be landscaped
	At least 1 tree per 180 SF of required interior landscape area
Calculation:	7,720 x 10% = 772
	772 / 180 = 4.3
Required:	772 of interior landscape area + 5 trees
Provided:	3(200 SF)+1(210 SF)=810 SF of interior landscape area + 5 tree
Sec. 24.12.030 INTE	RIOR VEHICULAR ACCESS AREA (EAST) (7,39
Sec. 24.12.030 INTE	RIOR VEHICULAR ACCESS AREA (EAST) (7,39 At least 10% must be landscaped

Landscape Requirement:	2 Deciduous Trees + 8 Shrubs per 50 LF			
Calculation:	80 LF / 50 = 1.6			
	(1.6 x 2 Trees = 3.2 Trees) + (1.6 x 8 Shrubs = 12.8 Shrubs)			
Required:	4 Trees + 13 Shrubs			
Provided:	4 Trees + 24 Shrubs + 24 Perennials			
Sec. 24.12.020 PERI	METER VEHICULAR ACCESS AREA (EAST) (10			
Landscape Requirement:	2 Deciduous Trees + 8 Shrubs per 50 LF			
Calculation:	100 LF / 50 = 2			
	(2 x 2 Trees = 4 Trees) + (2 x 8 Shrubs = 16 Shrubs)			
Required:	4 Trees + 16 Shrubs			
Provided:	4 Trees + 21 Shrubs + 21 Perennials			
	4 WCCS , EL SWADS , EL PERSONAIS			
	· · · · · · · · · · · · · · · · · · ·			
Sec. 24.12.030 INTE	RIOR VEHICULAR ACCESS AREA (NORTH) (7)			
Sec. 24.12.030 INTE Landscape Requirement:				
	RIOR VEHICULAR ACCESS AREA (NORTH) (7			
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Landscape Requirement: Calculation: Required: Provided:	RIOR VEHICULAR ACCESS AREA (NORTH) (7) At least 10% must be landscaped At least 1 tree per 180 SF of required interior landscape area 7,720 x 10% = 772 772 / 180 = 4.3 772 of interior landscape area + 5 trees			
Landscape Requirement: Calculation: Required: Provided:	RIOR VEHICULAR ACCESS AREA (NORTH) (7) At least 10% must be landscaped At least 1 tree per 180 SF of required interior landscape area 7,720 x 10% = 772 772 / 180 = 4.3 772 of interior landscape area + 5 trees 3(200 SF)+1(210 SF)=810 SF of interior landscape area + 5 tree			
Landscape Requirement: Calculation: Required: Provided: Sec. 24.12.030 INTE	RIOR VEHICULAR ACCESS AREA (NORTH) (7) At least 10% must be landscaped At least 1 tree per 180 SF of required interior landscape area 7,720 x 10% = 772 772 / 180 = 4.3 772 of interior landscape area + 5 trees 3(200 SF)+1(210 SF)=810 SF of interior landscape area + 5 tree RIOR VEHICULAR ACCESS AREA (EAST) (7,39)			
Landscape Requirement: Calculation: Required: Provided: Sec. 24.12.030 INTE	RIOR VEHICULAR ACCESS AREA (NORTH) (7) At least 10% must be landscaped At least 1 tree per 180 SF of required interior landscape area 7,720 x 10% = 772 772 / 180 = 4.3 772 of interior landscape area + 5 trees 3(200 SF)+1(210 SF)=810 SF of interior landscape area + 5 tree RIOR VEHICULAR ACCESS AREA (EAST) (7,39) At least 10% must be landscaped			

Landscape Requirement:	2 Deciduous Trees + 8 Shrubs per 50 LF
Calculation:	80 LF / 50 = 1.6
	(1.6 x 2 Trees = 3.2 Trees) + (1.6 x 8 Shrubs = 12.8 Shrubs)
Required:	4 Trees + 13 Shrubs
Provided:	4 Trees + 24 Shrubs + 24 Perennials
Sec. 24.12.020 PERI	METER VEHICULAR ACCESS AREA (EAST) (100 LF)
Landscape Requirement:	2 Deciduous Trees + 8 Shrubs per 50 LF
Calculation:	100 LF / 50 = 2
	(2 x 2 Trees = 4 Trees) + (2 x 8 Shrubs = 16 Shrubs)
Required:	4 Trees + 16 Shrubs
Provided:	4 Trees + 21 Shrubs + 21 Perennials
Sec. 24.12.030 INTE	RIOR VEHICULAR ACCESS AREA (NORTH) (7,720 SF
Landscape Requirement:	At least 10% must be landscaped
	At least 1 tree per 180 SF of required interior landscape area
Calculation:	7,720 x 10% = 772
	772 / 180 = 4.3
Required:	772 of interior landscape area + 5 trees
	2/200 SEL: 1/210 SEL-910 SE of interior landsone and the face
Provided:	3(200 SF)+1(210 SF)=810 SF of interior landscape area + 5 trees
	RIOR VEHICULAR ACCESS AREA (EAST) (7,395 SF)
Sec. 24.12.030 INTE	RIOR VEHICULAR ACCESS AREA (EAST) (7,395 SF)
Sec. 24.12.030 INTE	RIOR VEHICULAR ACCESS AREA (EAST) (7,395 SF) At least 10% must be landscaped

740 of interior landscape area + 5 trees

3(200 SF)+1(280 SF)= 880 SF of interior landscape area + 5 trees

(S)	SANITARY SEWER MANHOLE	SAN	SANITARY SEWER
(ST)	STORM MANHOLE	W	WATER MAIN
\oplus	CATCH BASIN ROUND	ST	STORM SEWER
\blacksquare	CATCH BASIN SQUARE	RD	ROOF DRAIN
\Diamond	FIRE HYDRANT	G	UNDERGROUND GAS
M	WATER VALVE	——Е——	UNDERGROUND ELECTRIC
	GAS VALVE	——Т	UNDERGROUND TELEPHONE
X	LIGHT POLE	—— FIB ——	UNDERGROUND FIBER OPTICS
T	TELEPHONE PEDESTAL	——— OH———	OVERHEAD UTILITY
E	ELECTRICAL MANHOLE	SF	SILT FENCE
-0-	SIGN		18" STANDARD CURB AND GUTT
Ø	POWER POLE		18" HIGH SIDE CURB AND GUTT
	GUY WIRE		ALUMINUM LANDSCAPE EDGING
100 M	EX. CONIFEROUS TREE		DECORATIVE STONE MULCH
المرسي			BIORETENTION BASIN PLUGS NO-MOW FESCUE SEED MIX
€ ° }	EX. DECIDUOUS TREE	L+ + + + + + + + + + + + + + + + + + +	BLUEGRASS BLEND SOD





JSD PROJ. NO.: 22-11646 www.DiggersHotline.com JSD PROJ. MGR.: RWI LANDSCAPE PLAN

4. DRAWING FOR REVIEW - NOT FOR CONSTRUCTION UNLESS OTHERWISE NOTED IN THE TITLE BLOCK. CONTRACTOR

INSTALLATION (IF APPLICABLE), AND FINISH GRADING ARE COMPLETE

GENERAL NOTES

(2) DKL ¬

110.00 TW 109.50 BW

111.72± TW-110.25 BW

INTERIOR VEHICULAR ACCESS AREA

ALL PLANTING BEDS TO RECEIVE 3" HARDWOOD SHREDDED BARK MULCH OVER WEED FABRIC,

BETWEEN TURF AND PLANTING AREA, OR BARK

MAINTENANCE STRIP TO BE 3" STONE MULCH OVER WEED FABRIC WITH ALUMINUM EDGING.

EXCEPT IN PERENNIAL PLANTING AREAS, BORDERED WITH ALUMINUM EDGING

FFE MATCH

CONTRACTOR NOTES:

SHREDDED HARDWOOD BARK MULCH TO BE INSTALLED IN ALL PLANTING AREAS UNLESS OTHERWISE DEPICTED.

ALL DISTURBED AREAS SHALL RECEIVE BLUEGRASS SEED (TYP) UNLESS OTHERWISE DEPTICTED.

INTERIOR VEHICULAR ACCESS AREA (7,395 SF)

5. THE LANDSCAPE CONTRACTOR SHALL COORDINATE ALL FINE GRADING AND TOPSOILING WITH GENERAL 6. REFER TO "LANDSCAPE DETAILS AND NOTES" SHEET FOR ADDITIONAL DETAILS, NOTES AND SPECIFICATION INFORMATION INCLUDING MATERIALS, GUARANTEE AND EXECUTION RELATED TO LANDSCAPE PLAN

ALL WORK IN THE ROW SHALL BE IN ACCORDANCE WITH THE MUNICIPAL STANDARD SPECIFICATIONS FOR PUBLIC WORKS CONSTRUCTION.

3. JSD SHALL BE HELD HARMLESS AND DOES NOT WARRANT ANY DEVIATIONS BY THE OWNER/CONTRACTOR

FROM THE APPROVED CONSTRUCTION PLANS THAT MAY RESULT IN DISCIPLINARY ACTIONS BY ANY OR ALL REGULATORY AGENCIES.


1. REFER TO THE EXISTING CONDITIONS SURVEY FOR EXISTING CONDITIONS NOTES AND LEGEND.


7. CONTRACTOR SHALL REVIEW SITE CONDITIONS FOR UTILITY CONFLICTS, DRAINAGE ISSUES, SUBSURFACE ROCK, AND PLANT PLACEMENT CONFLICTS PRIOR TO PLANT INSTALLATION. REPORT ANY CONDITIONS THAT MAY HAVE ADVERSE IMPACT ON PLANTING OPERATIONS TO LANDSCAPE ARCHITECT

8. DO NOT COMMENCE PLANTING OPERATIONS UNTIL ALL ADJACENT SITE IMPROVEMENTS, IRRIGATION

Required:

Provided:

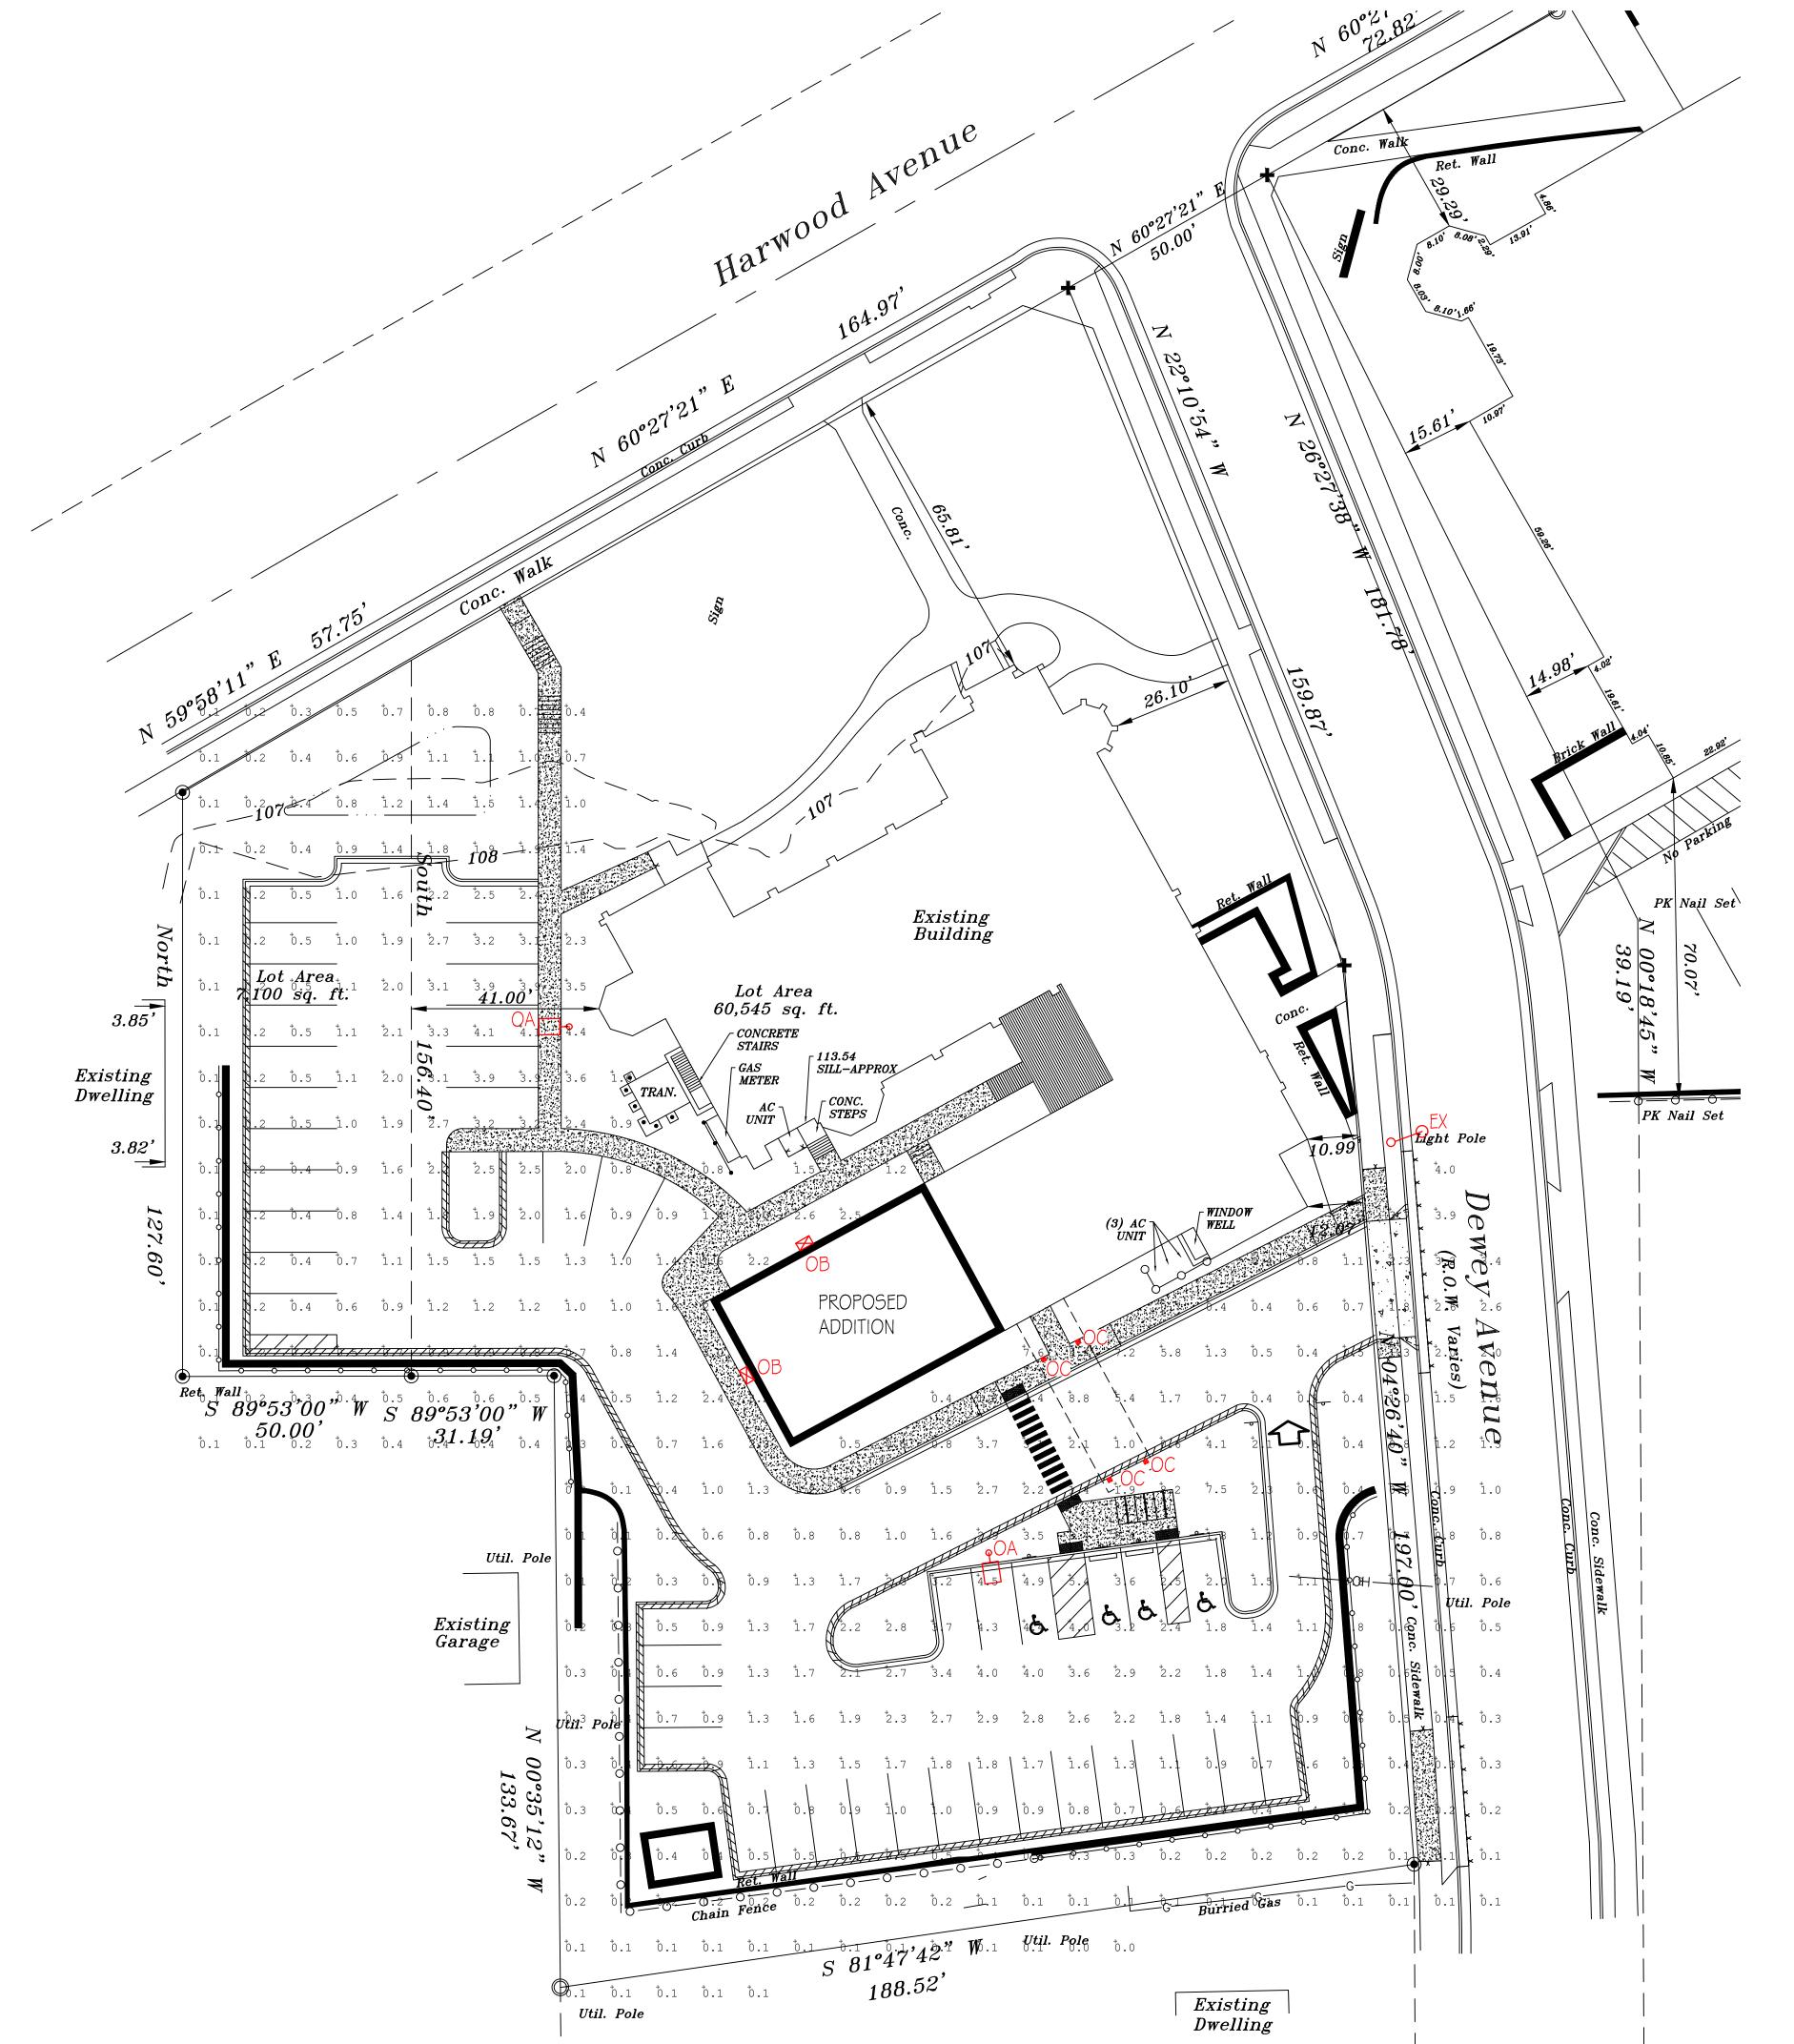

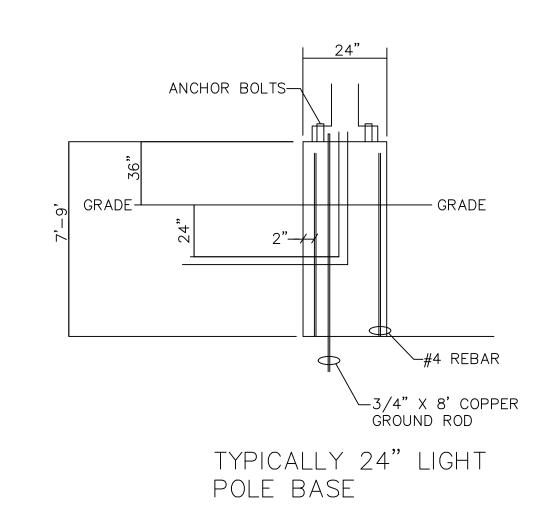

	,		ST. JOHN'S WAUWATOSA						
SYMBOL/TYPE	DESCRIPTION	MAKE	FIXTURE SCHEDULE LIGHTING FIXTURE CATALOG NO. I	QTY I	LAMP DATA TYPE	CEILING TYPE	MOUNTING HEIGHT	VOLTAGE	SEE NOTE
		LITTONIA	FIXTURE: DSX0 LED P7 40K 700RI T3M MVOLT SPA DDBXD DDBXD G1 POLE: SSS 20'4C DM19AS DDBXD		171W EACH LED		23'-0" POLE	UNV	1
		LITHONIA	WDGE2 LED P3 40K 70CRI T3M MVOLT PBBW DDBXD		32W EACH LED		12'-0" AFG	UNV	1
OC 🛛	LED WALL LIGHT	AMERLUX	D485 TA AVI2 SY 30K 700M CLB W/ WBR04 CLB		38W LED		10'-0" AFG	UNV	
EX 0	EXISTING STREET LIGHT								2
	OA 🖳 OB 🔀 OC 🛛	OA OL LED POLE LIGHT W/ 20' POLE ON A 3' TALL POLE BASE OB LED WALL PACK OC LED WALL LIGHT	OA O- LED POLE LIGHT W/ 20' POLE ON A 3' TALL POLE BASE OB LED WALL PACK LITHONIA OC LED WALL LIGHT AMERLUX	SYMBOL/TYPE DESCRIPTION MAKE CATALOG NO. LED POLE LIGHT W/ 20' POLE ON A 3' TALL POLE BASE OB LED WALL PACK LED WALL LIGHT AMERLUX LED WALL LIGHT FIXTURE SCHEDULE LIGHTING FIXTURE CATALOG NO. FIXTURE: DSX0 LED P7 40K 700RI T3M M/0LT SPA DDBXD DDBX0 G1 POLE: SSS 20' 4C DM19AS DDBXD DDBX0 G1 POLE: SSS 20' 4C DM19AS DDBXD AMERLUX D485 TA AVI2 SY 30K 700M CLB W/ WBR04 CLB	SYMBOL/TYPE DESCRIPTION OA O DESCRIPTION LED POLE LIGHT W/ 20' POLE ON A 3' TALL POLE BASE OB LED WALL PACK LED WALL LIGHT AMERIUX FIXTURE SCHEDULE LIGHTING FIXTURE CATALOG NO. QTY LITHONIA FIXTURE: DSX0 LED P7 40K 70CRI T3M MV0LT SPA DDBXD DDBXD G1 POLE: SSS 20' 4C DM19AS DDBXD LED WALL LIGHT AMERIUX AMERIUX D485 TA AVI2 SY 30K 700M CLB W/ WBR04 CLB	SYMBOL/TYPE DESCRIPTION OA ID LED POLE LIGHT W/ 20' POLE ON A 3' TALL POLE BASE OB LED WALL PACK LED WALL LIGHT AMERLUX FIXTURE SCHEDULE LIGHTING FIXTURE CATALOG NO. QTY TYPE FIXTURE: DSX0 LED P7 40K 700RI T3M MV0LT SPA D0BX0 DDBX0 GI POLE: SSS 20' 4C DMI9AS DDBX0 TO ID WALL LIGHT AMERLUX D485 TA AVI2 SY 30K 700M CLB W/ WBR04 CLB 38W LED 38W LED	SYMBOL/TYPE DESCRIPTION OA - DESCRIPTION DESCRIPTION MAKE CATALOG NO. CATALOG NO. CATALOG NO. CATALOG NO. CATALOG NO. DESCRIPTION MAKE CATALOG NO. CA	SYMBOL/TYPE DESCRIPTION MAKE CATALOG NO. UED POLE LIGHT W/ 20' POLE ON A 3' TALL POLE BASE OB LED WALL PACK LITHONIA WDGE2 LED P3 40K 70CRI T3M MVOLT PADDBXD OC LED WALL LIGHT AMERLUX D485 TA AVI2 SY 30K 700M CLB W/ WBR04 CLB DESCRIPTION LAMP DATA CEILING TYPE MOUNTING HEIGHT TYPE 171W EACH LED 171W EACH LED 171W EACH LED 172'-0" AFG 172'-0" AFG 172'-0" AFG	SYMBOL/TYPE DESCRIPTION SYMBOL/TYPE DESCRIPTION DES

LIGHTING NOTES:

1. MULTIPLE PARTS ARE NEEDED TO ASSEMBLE AS A COMPLETE FIXTURE.
SEE INSTALLATION INSTRUCTIONS
2. EXISTING POLE LIGHT ADDED INTO CALCULATION FOR REPRESENTATION OF CONTRIBUTED LIGHT


UNDERGROUND NOTES:

---- underground electrical raceway min. Depth of 18" a.f.g.

Calculation Summary							
Label	CalcType	Units	Avg	Max	Min	Avg/Min	Max/Min
Site	Illuminance	Fc	1.31	9.4	0.0	N.A.	N.A.

DISCLAIMER: CALCULATIONS HAVE BEEN PERFORMED ACCORDING TO IESNA & CIE STANDARDS AND GOOD PRACTICE. SOME DIFFERENCES BETWEEN MEASURED VALUES AND CALCULATED RESULTS MAY OCCUR DUE TO TOLERANCES IN CALCULATION METHODS, TESTING PROCEDURES, COMPONENT PERFORMANCE, MEASUREMENT TECHNIQUES AND FIELD CONDITIONS SUCH AS VOLTAGE AND TEMPERATURE VARIATIONS. INPUT DATA USED TO GENERATE THE ATTACHED CALCULATIONS SUCH AS ROOM DIMENSIONS,

REFLECTANCES, FURNITURE AND ARCHITECTURAL ELEMENTS SIGNIFICANTLY AFFECT THE LIGHTING CALCULATIONS. IF THE REAL ENVIRONMENT CONDITIONS DO NOT MATCH THE INPUT DATA, DIFFERENCES WILL OCCUR BETWEEN MEASURED VALUES AND CALCULATED VALUES.

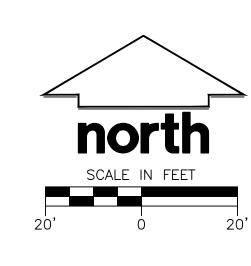

	REVISIONS SCEEDU	LE
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No.	Revision	Date

GIRAFFE ELECTRIC II, INC.

2025 S WEST AVENUE WAUKESHA, WI

53189 262-549-6500 FAX 262-549-6503

PROJECT ADDRESS: ST. JOHN'S EV. LUTHERAN CHURCH 7809 HARWOOD AVE. WAUWATOSA, W 53213


DATE: 6/5/23

DRAWN BY: JDG REVISIONS:

SHEET TITLE: SITE LIGHTING PHOTOMETRICS PLAN


PROJECT NUMBER:


SCALE: 1"=20'-0"

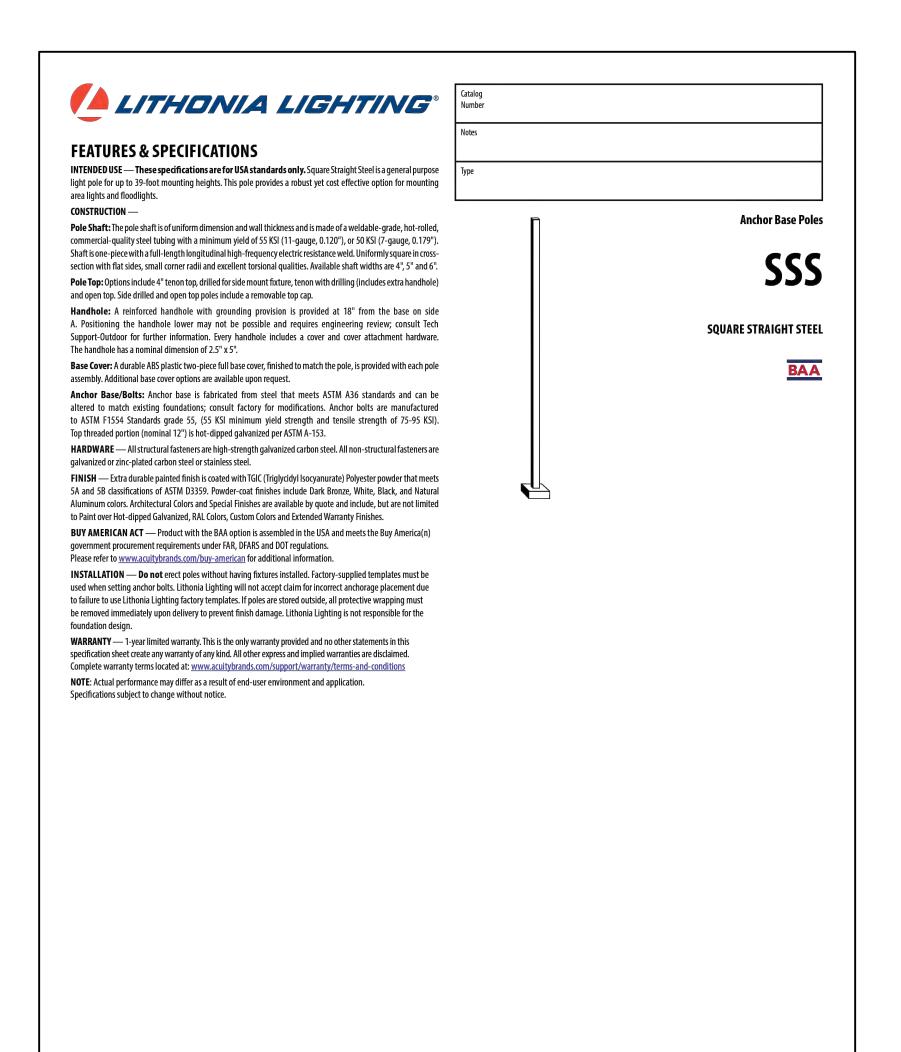



POLE-SSS


OUTDOOR

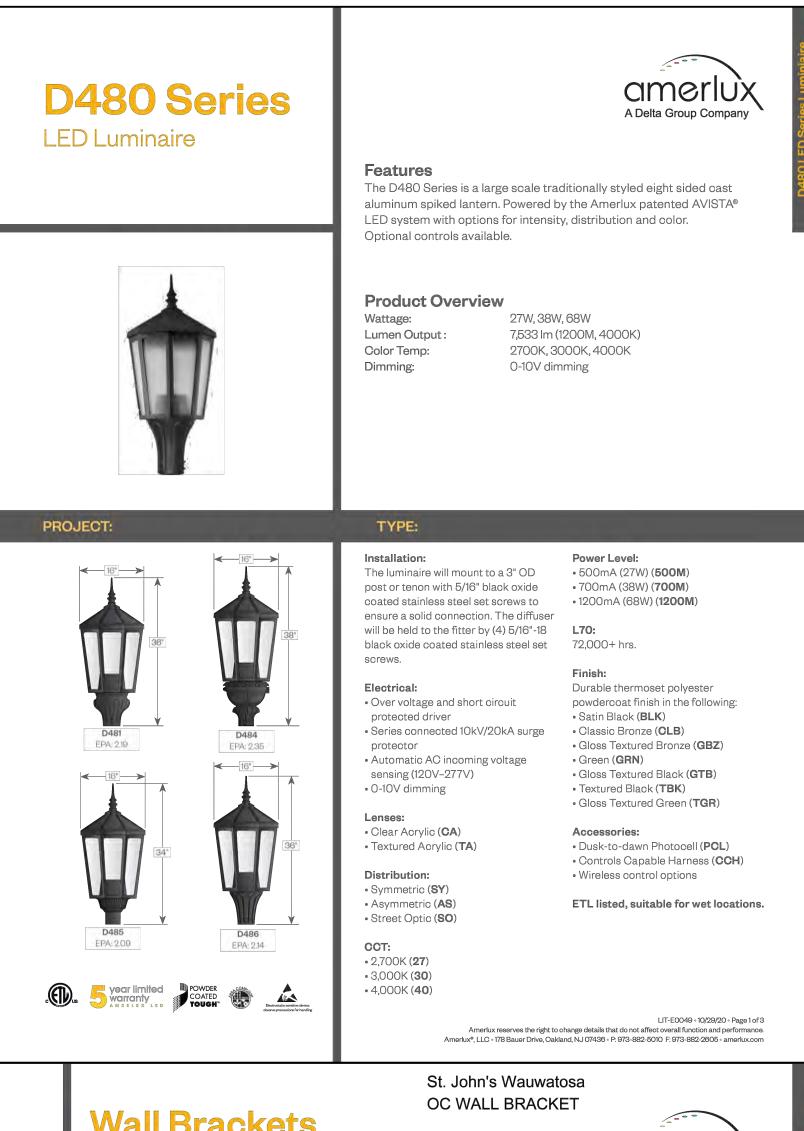

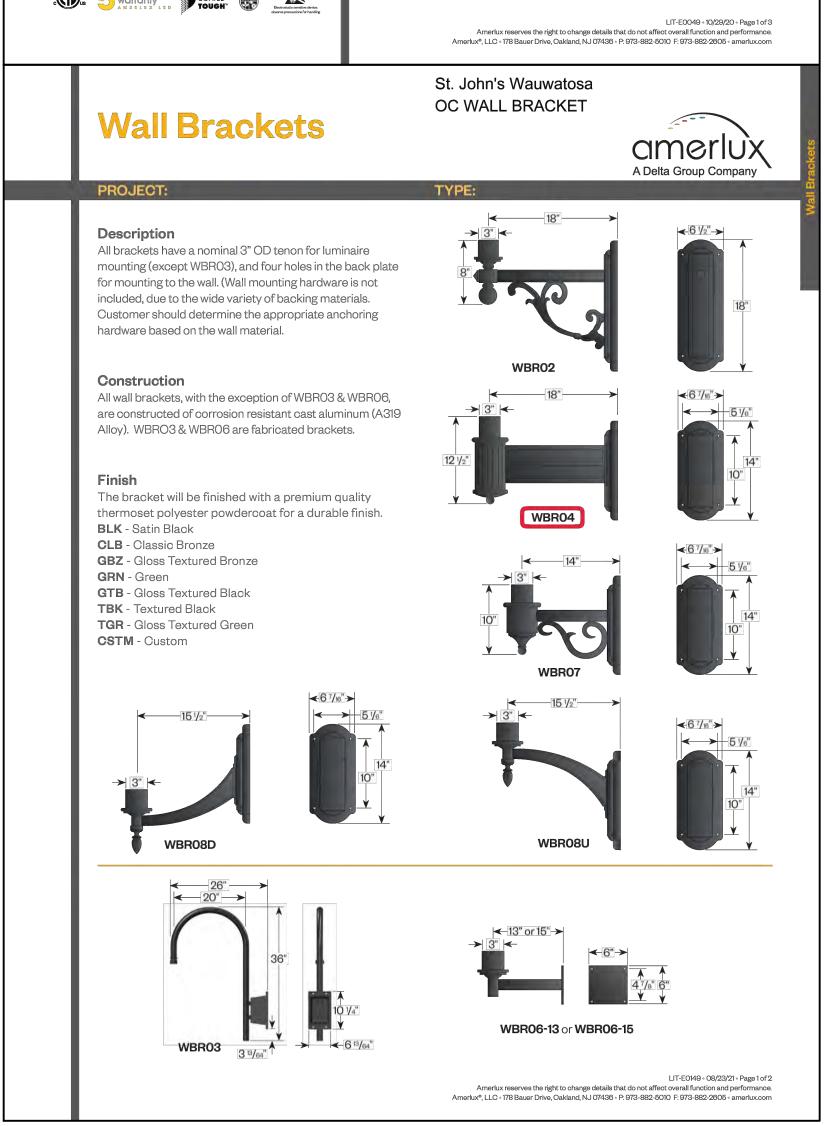

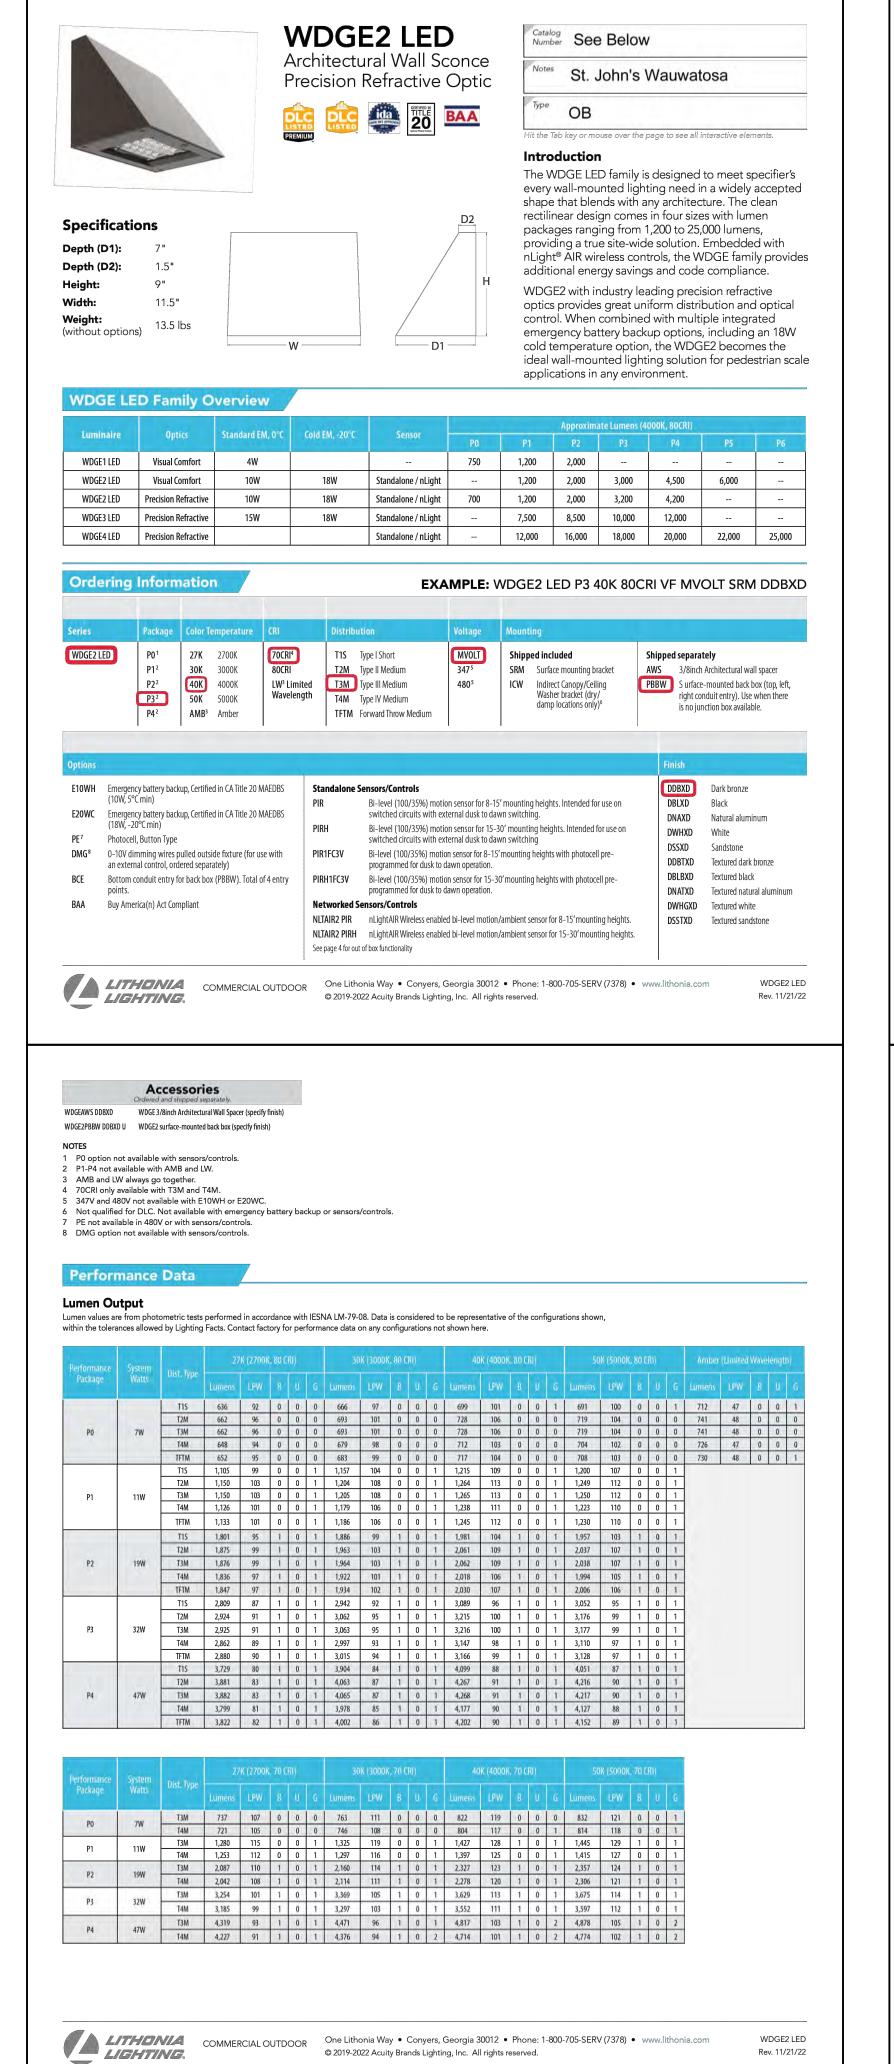

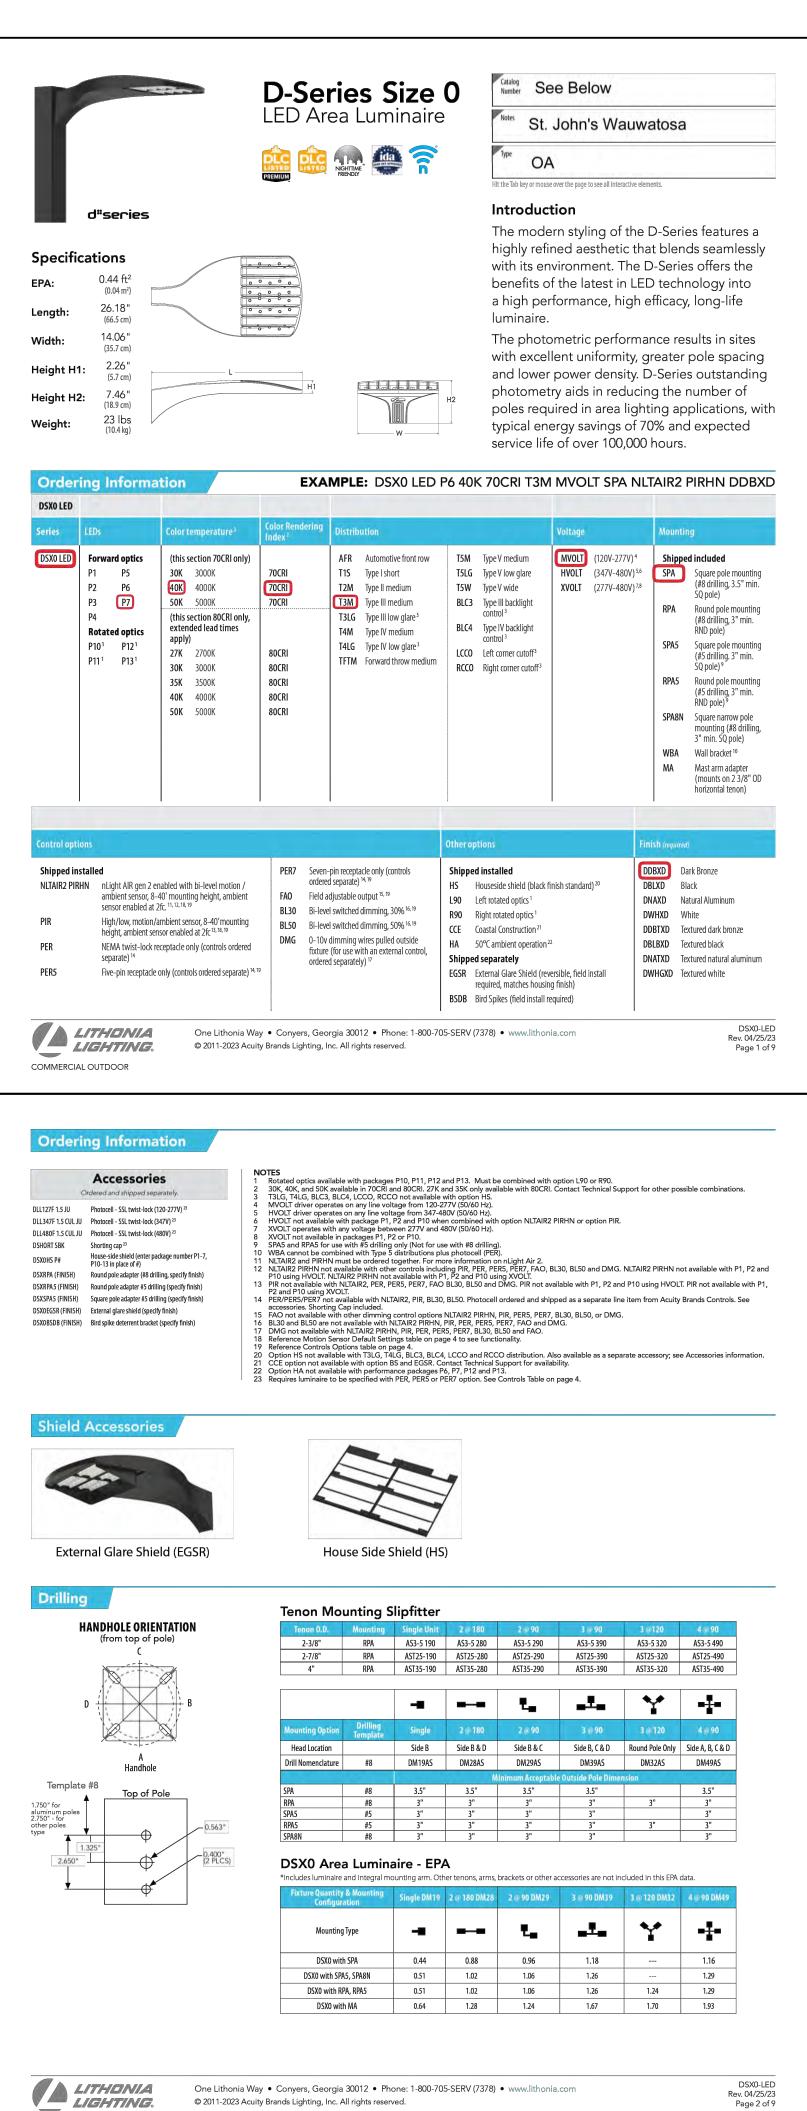

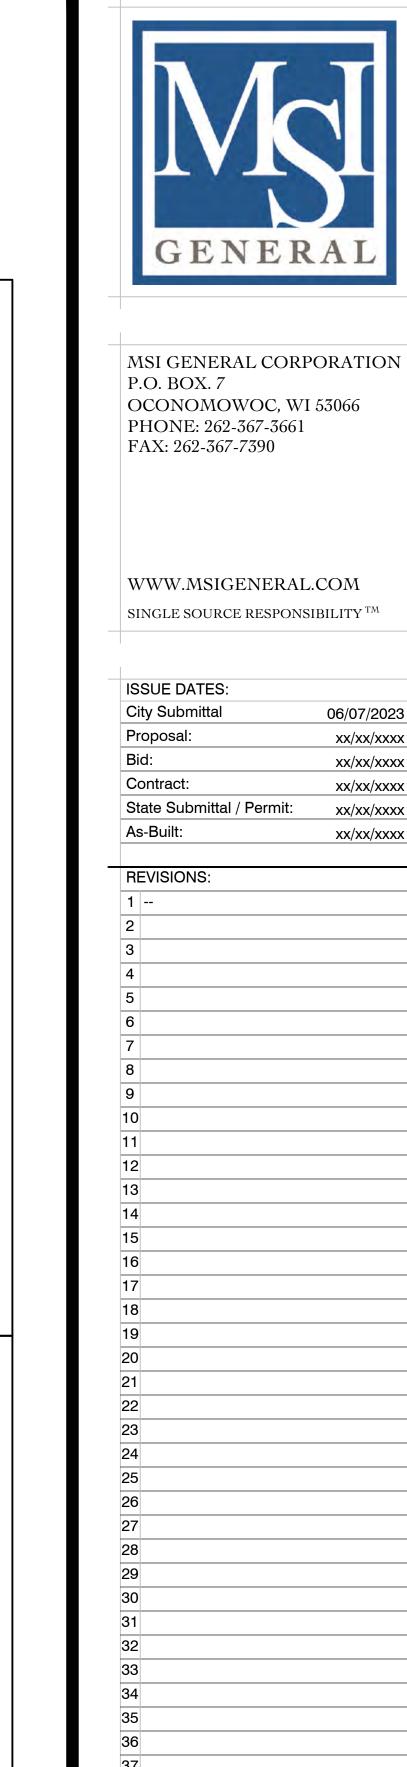

LIGHTING SPECS E-200 P13586

ALL WORK TO BE COMPLETED AS SHOWN, AND IN

ACCORDANCE WITH THE LATEST EDITION OF THE

MSI GENERAL MASTER SPECIFICATION

PROJECT NAME

STREET ADDRESS 7809 Harwood Ave. CITY/ STATE / ZIP

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Rev. 11/21/22

COMMERCIAL OUTDOOR

08/08/2023


LANDSCAPE DESIGN XXX

PROJECT NUMBER:
P13586

GENERAL NOTES - FLOOR PLAN(S)

A. MOISTURE RESISTANT GWB AT ALL LOCATIONS EXPOSED TO MOISTURE (BATHROOMS, JANITOR/PLUMING ROOMS, KITCHENS, ETC. AND EXTERIOR WINDOW AND DOOR HEAD AND JAMB RETURNS)



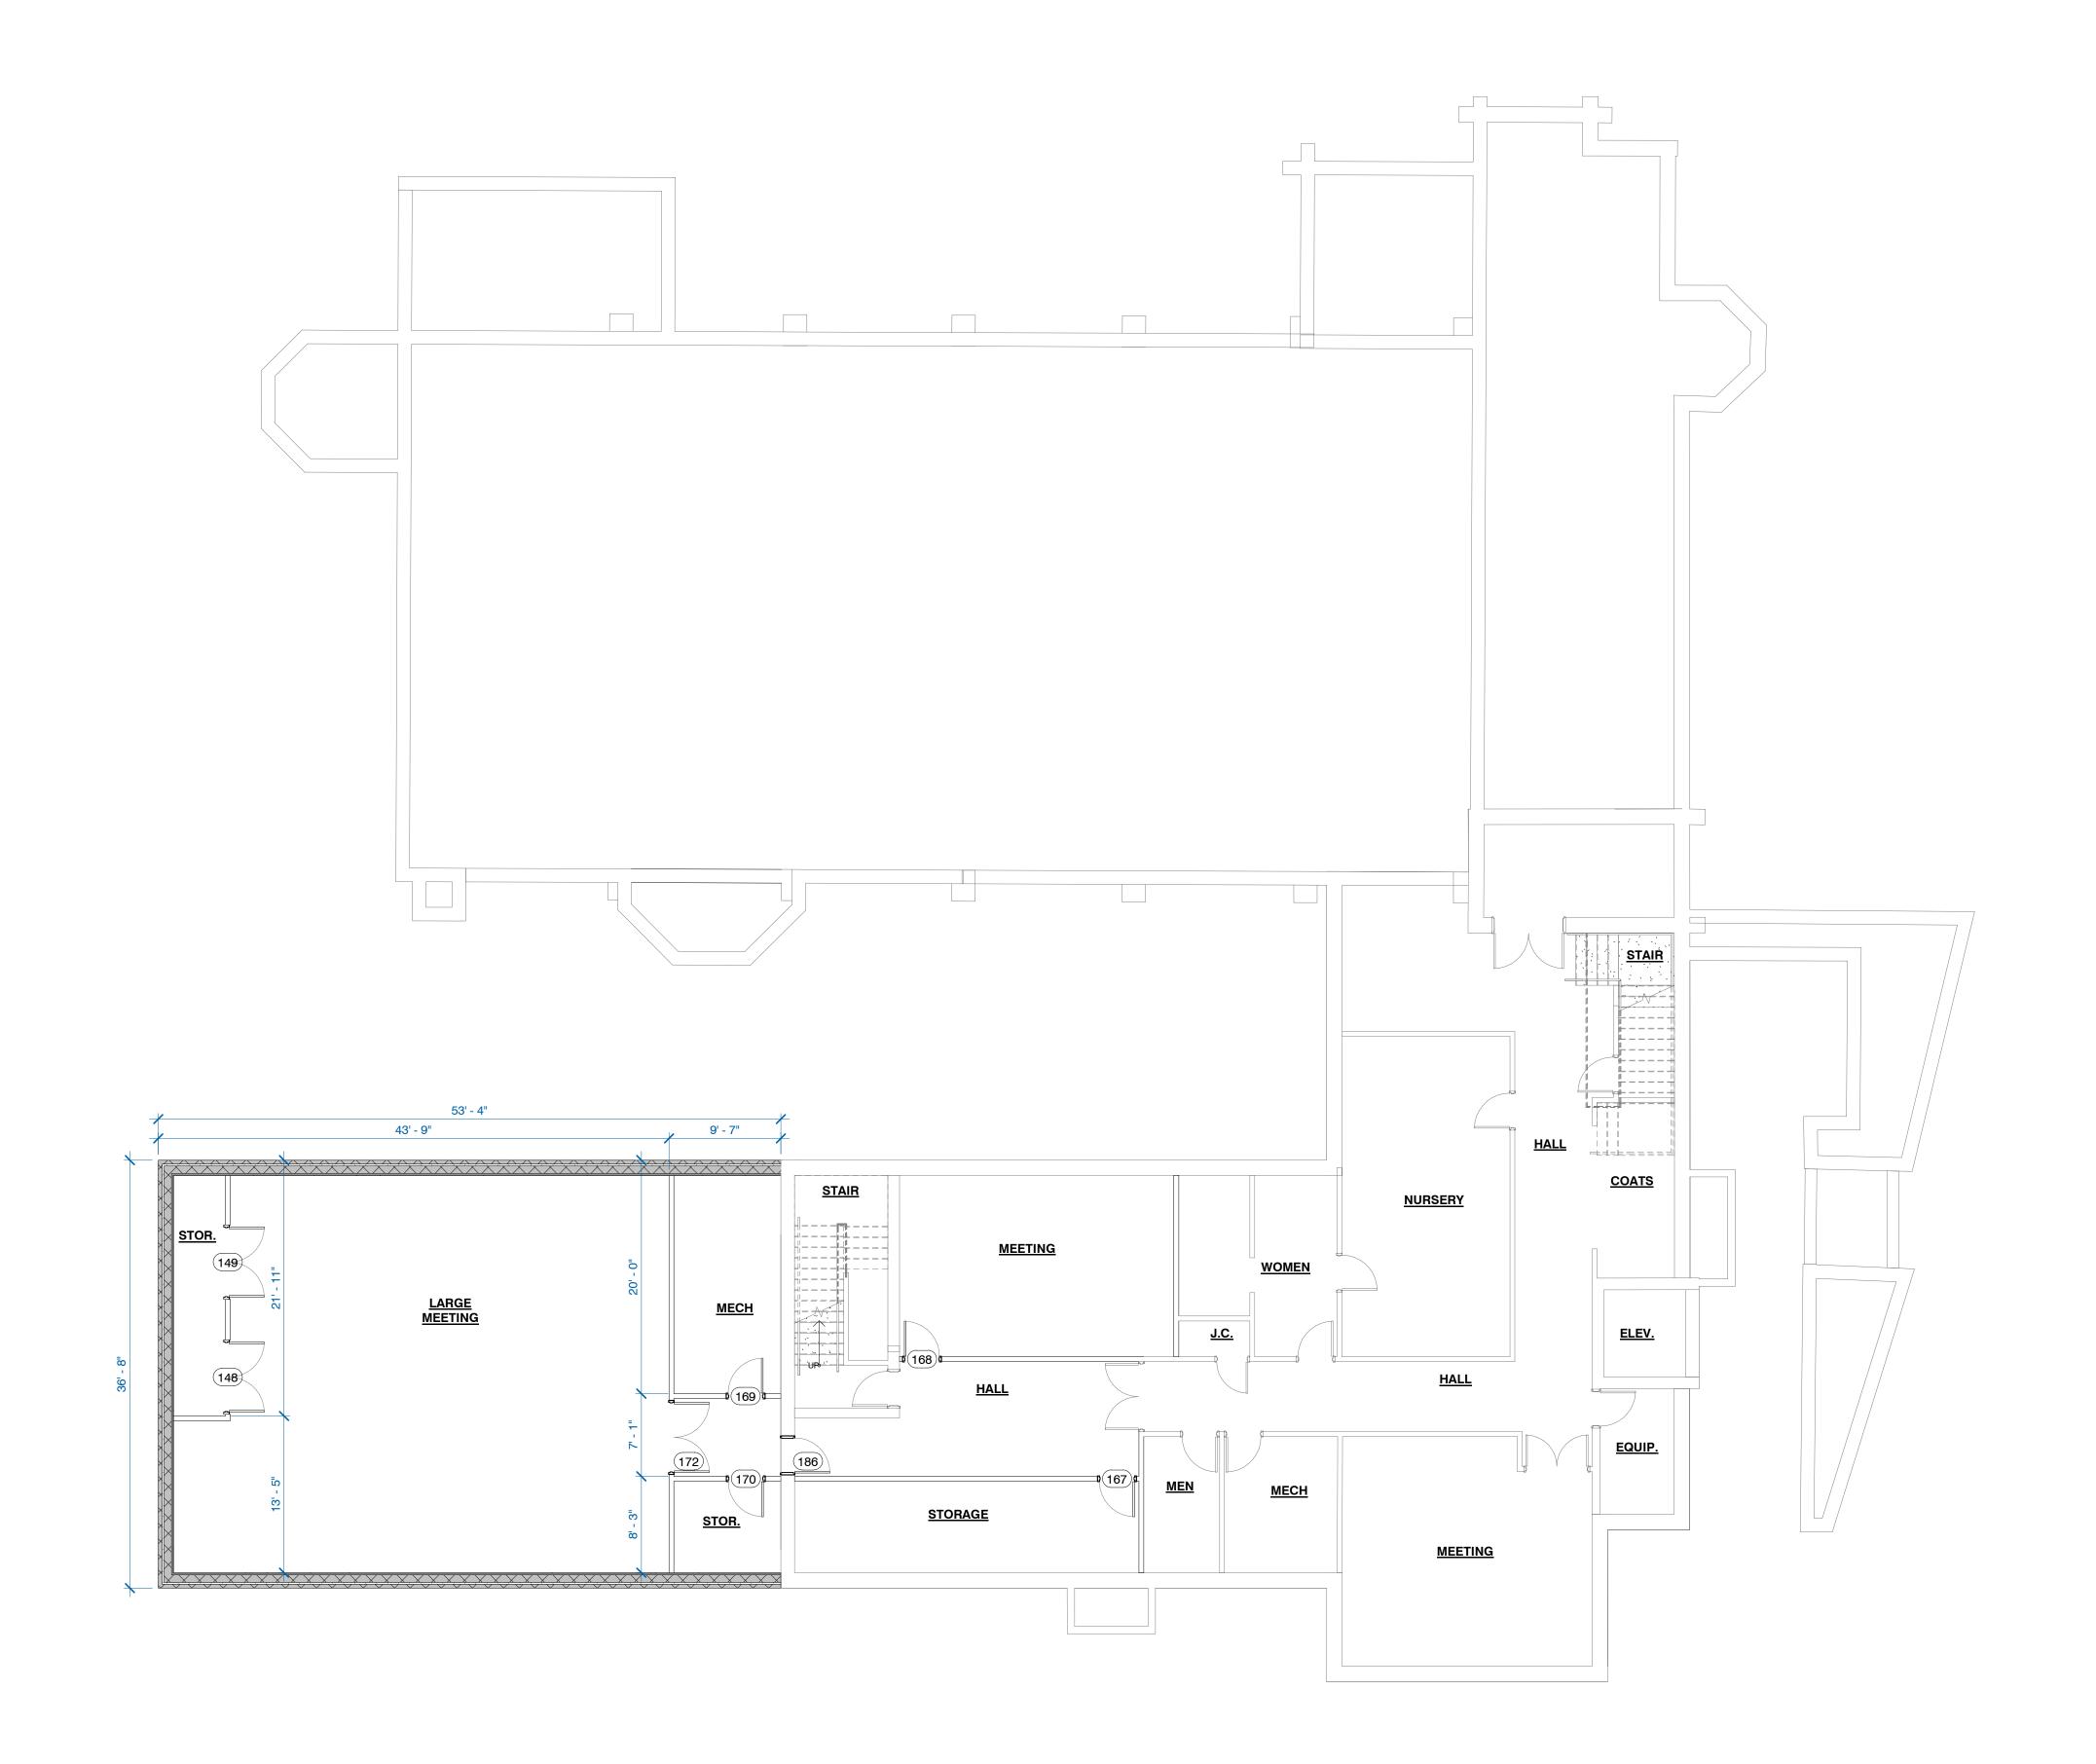

CONTRACTORS

ARCHITECTS

08/08/2023

PROJECT DESCRIPTION
NEW FACILITY

7809 HARWOOD AVE

WAUWATOSA, WISCONSIN 53213

ALL WORK TO BE COMPLETED AS SHOWN, AND IN ACCORDANCE WITH THE LATEST EDITION OF THE MSI GENERAL MASTER SPECIFICATION



STRUCTURAL ENGINEER XXX LANDSCAPE DESIGN XXX

DESIGN
ARCHITECT CIVIL ENGINEER: REVIEWED BY
XXX XXX XXX

FIRST FLOOR PLAN

A-11

PROJECT NUMBER:
P13586



A. MOISTURE RESISTANT GWB AT ALL LOCATIONS EXPOSED TO MOISTURE (BATHROOMS, JANITOR/PLUMING ROOMS, KITCHENS, ETC. AND EXTERIOR WINDOW AND DOOR HEAD AND JAMB RETURNS)

SHEET NOTES - FLOOR PLAN(S) NOTE: THESE NOTES APPLY ONLY TO THIS SHEET

DESCRIPTION O1 COMPOSITE DECK WITH COMPOSITE DECORATIVE RAILING ON TREATED SUB STRUCTURE POSTS.

GENERAL **DESIGNBUILD** MSI GENERAL CORPORATION W215 E. WISCONSIN AVE. NASHOTAH, WI 53058 262.367.3661 | MSIGENERAL.COM

SINGLE SOURCE RESPONSIBILITY DESIGNING EXCELLENCE. BUILDING TRUST TM

MILESTONE ISSUE DATES

LOCAL DESIGN REVIEW SET:

BUDGET SET:

PROPOSAL SET:

REVISIONS:

CONSTRUCTION SET: RECORD DRAWING SET

A-201 1



ST. JOHN'S EV. LUTHERAN CHURCH EXISTING EAST ELEVATION





08/08/2023

MSI GENERAL CORPORATION

W215 E. WISCONSIN AVE.

NASHOTAH, WI 53058

262.367.3661 | MSIGENERAL.COM

SINGLE SOURCE RESPONSIBILITY
DESIGNING EXCELLENCE. BUILDING TRUST TM

MILESTONE ISSUE DATES

LOCAL DESIGN REVIEW SET:

PROPOSAL SET:

CONSTRUCTION SET:


RECORD DRAWING SET

REVISIONS:

CONTRACTORS

ARCHITECT

ALL WORK TO BE COMPLETED AS SHOWN, AND IN ACCORDANCE WITH THE LATEST EDITION OF

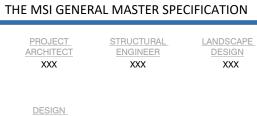


DESIGN ARCHITECT CIVIL ENGINEER: REVIEWED BY XXX XXX XXX

EXTERIOR ELEVATIONS


SHEET NUMBER: **A-201**

PROJECT NUMBER: P13586

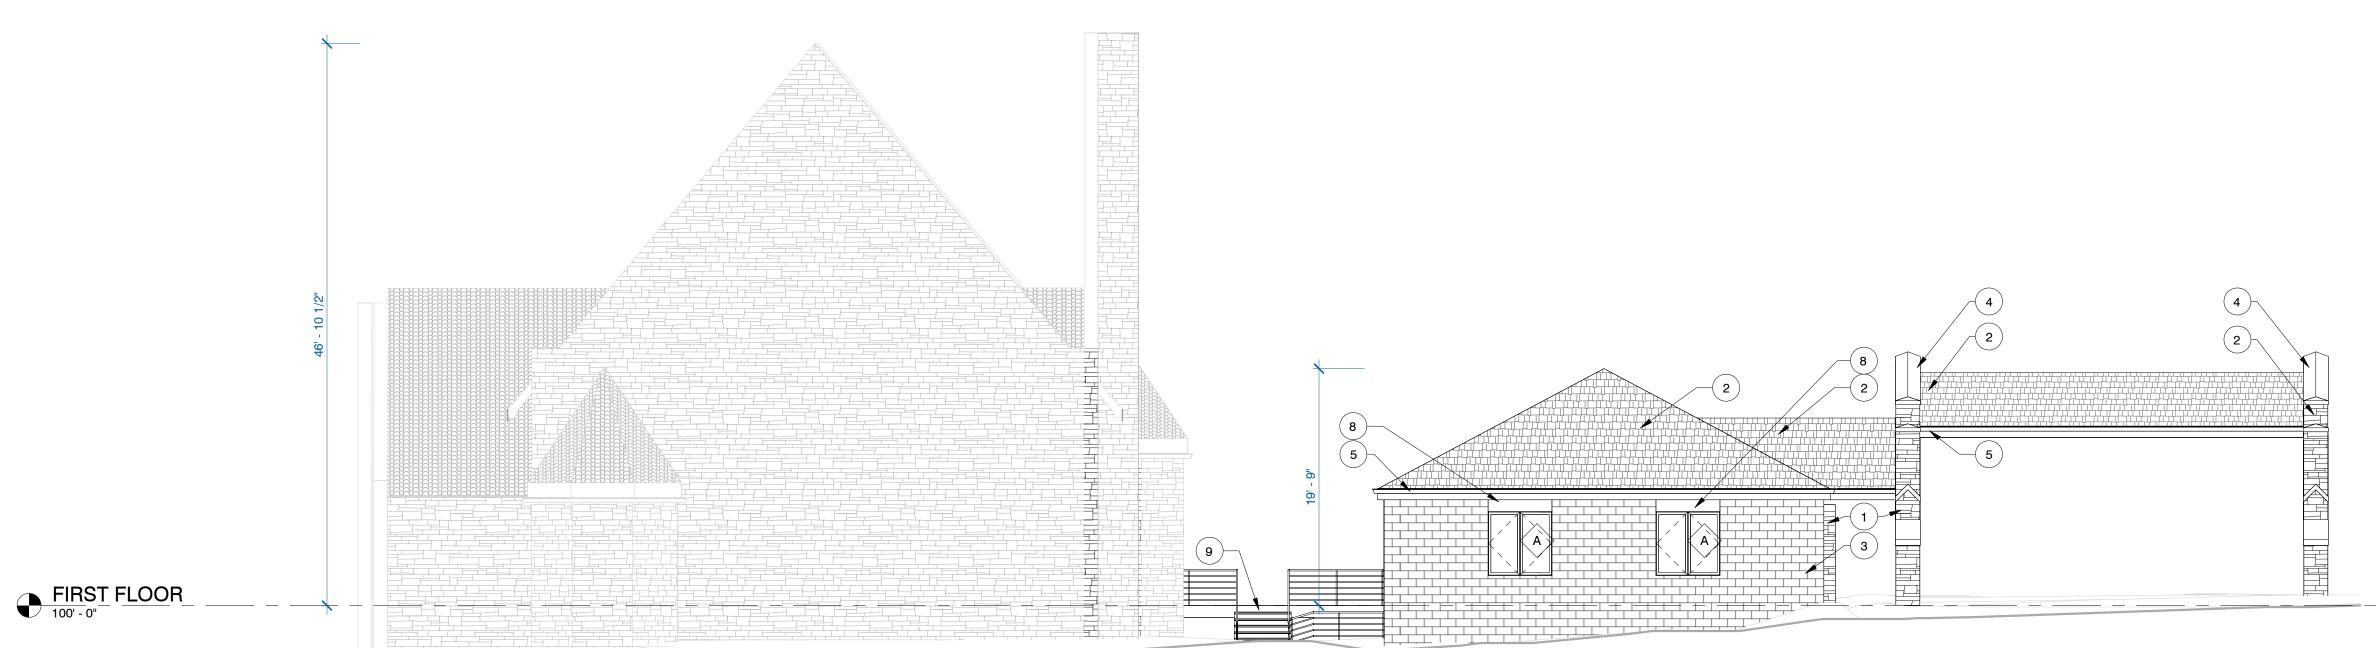

SOUTH ELEVATION

1/8" = 1'-0"

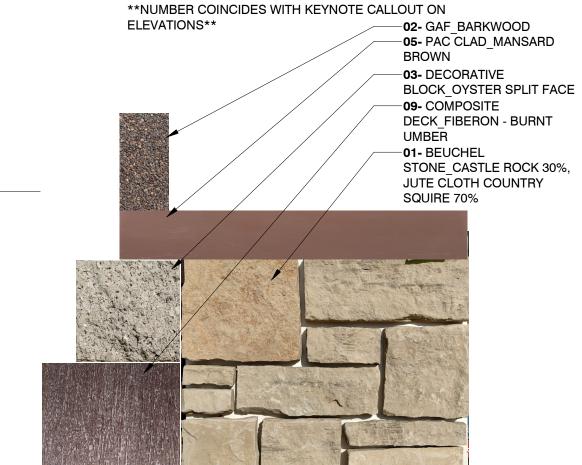

GENERAL NOTES - EXT. ELEVATION(S)

A. LIMESTONE AND MORTAR ASHLAR PATTERN TO APPEAR SEAMLESS BETWEEN OLD AND NEW CONSTRUCTION AS MUCH AS POSSIBLE.

B. ALL COLORS TO BE SUBMITTED FOR ARCHITECT APPROVAL

SHEET NOTES - EXT. ELEVATIONS

NOTE: THESE NOTES APPLY ONLY TO THIS SHEET

DESCRIPTION

LANNON STONE VENEER ON CONCRETE BLOCK BACKUP TO APPROXIMATE EXISTING CONDITION.

ALUMINUM GUTTER AND DOWNSPOUT WITH PAINTED FASCIA

PREFINISHED ALUMINUM REVEAL TO APPRIXMATE EXISTING

COMPOSITE DECK WITH COMPOSITE DECORATIVE RAILING ON TREATED SUB STRUCTURE POSTS.

CLASS B SHINGLE ROOF TO MATCH TO APPROXIMATE EXISTING COLOR AND LOOK OF EXISTING SHINGLES

SPLIT FACE CONCRETE BLOCK TO APPROXIMATE EXISTING

4 4" CUT STONE COPING TO APPROXIMATE EXISTING COLOR.

ADJACENT BLOCK WALL COLOR.

TO APPROXIMATE EXISTING CONDITION.

CONDITION

ALL MATERIALS TO APPROXIMATE EXISTING CONDITIONS IN COLOR, TEXTURE AND QUALITY AS APPLICABLE


MATERIAL LEGEND

3" = 1'-0"

FIRST FLOOR	
2 WEST ELEVATION 1/8" = 1'-0"	

JMBER: 202	
NUMBER:	P13586

WINDOW SCHEDULE WINDOW SIZE ROUGH OPENING WIDTH HEIGHT WIDTH HEIGHT **MANUFACTURER** MODEL# GLAZING COMMENTS DESCRIPTION MARK QTY. STYLE OPERABLE CASEMENT WOOD WINDOW WITH 34 6 <varies> 2' - 0" 2' - 8" 5' - 4" PREFINISHED ALUMINUM EXTERIOR CLADDING OPERABLE CASEMENT WOOD WINDOW WITH 5' - 4" | 5' - 4 1/2" | 5' - 4 1/2" PREFINISHED ALUMINUM EXTERIOR CLADDING OPERABLE CASEMENT WOOD WINDOW WITH PREFINISHED ALUMINUM EXTERIOR CLADDING 2' - 8" | 5' - 4" | 2' - 8 1/2" | 5' - 4 1/2"

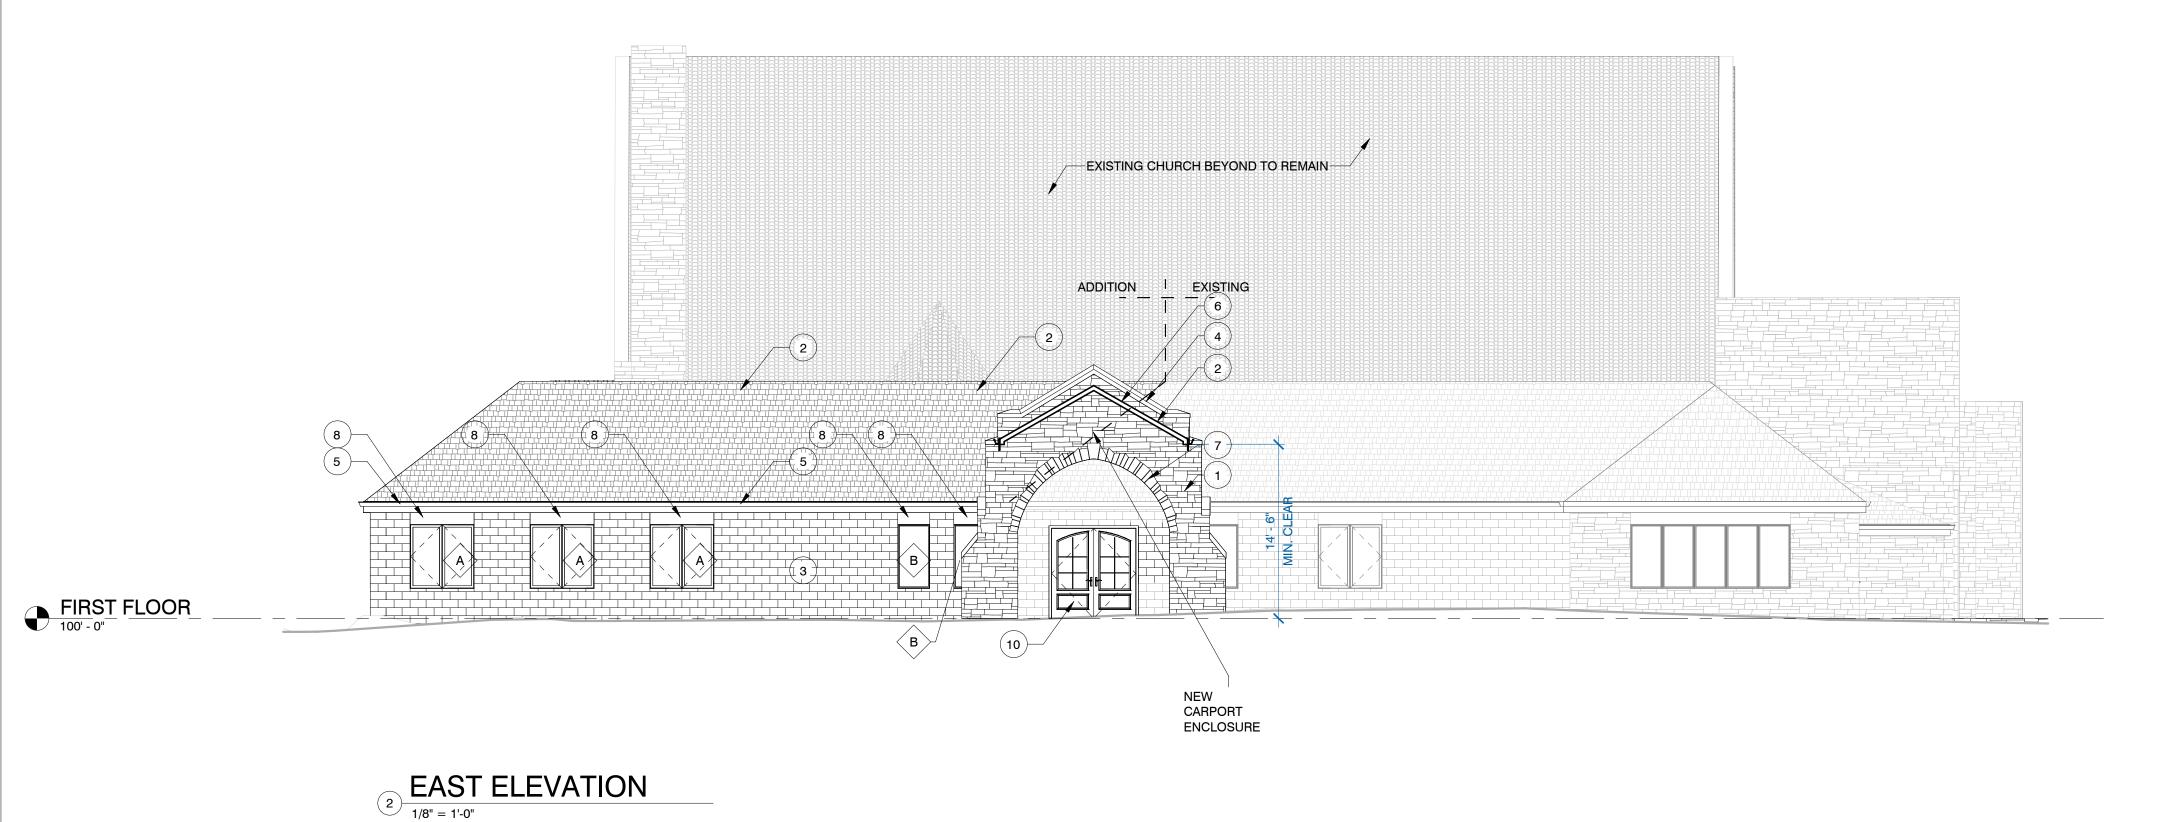


GENERAL NOTES - EXT. ELEVATION(S) A. LIMESTONE AND MORTAR ASHLAR PATTERN TO APPEAR SEAMLESS BETWEEN OLD AND NEW CONSTRUCTION AS MUCH AS POSSIBLE.

B. ALL COLORS TO BE SUBMITTED FOR ARCHITECT APPROVAL

SHEET NOTES - EXT. ELEVATIONS NOTE: THESE NOTES APPLY ONLY TO THIS SHEET DESCRIPTION

- LANNON STONE VENEER ON CONCRETE BLOCK BACKUP TO APPROXIMATE EXISTING CONDITION. CLASS B SHINGLE ROOF TO MATCH TO APPROXIMATE EXISTING COLOR AND LOOK OF EXISTING SHINGLES
- SPLIT FACE CONCRETE BLOCK TO APPROXIMATE EXISTING ADJACENT BLOCK WALL COLOR. 4 4" CUT STONE COPING TO APPROXIMATE EXISTING COLOR.
- ALUMINUM GUTTER AND DOWNSPOUT WITH PAINTED FASCIA 5 ALUMINUM GUITER AND DOTTION.
 TO APPROXIMATE EXISTING CONDITION. STEEL BEAM WITH SCISSOR TRUSS, UNDERSIDE OF T&G PAINTED WOOD.
- PREFINISHED ALUMINUM REVEAL TO APPRIXMATE EXISTING 10 PRE-FINISHED DECORATIVE GLAZED INSULATED ENTRY DOOR

7 LANNON CUT STONE SELF SUPPORTING ARCHWAY

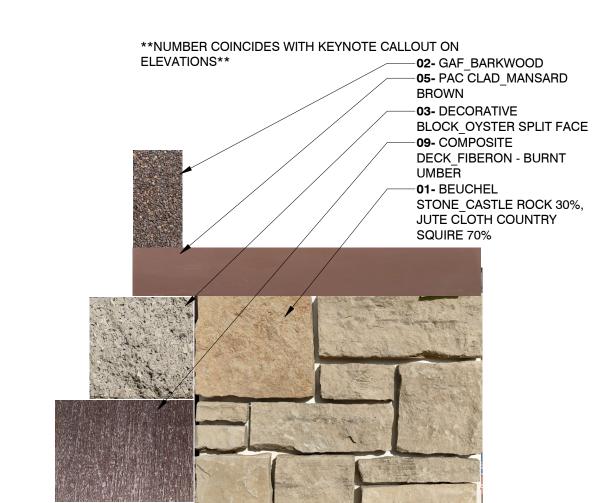

ALL MATERIALS TO APPROXIMATE EXISTING CONDITIONS IN COLOR, TEXTURE AND QUALITY AS APPLICABLE

MATERIAL LEGEND



MSI GENERAL CORPORATION W215 E. WISCONSIN AVE. NASHOTAH, WI 53058

262.367.3661 | MSIGENERAL.COM

SINGLE SOURCE RESPONSIBILITY				
DESIGNING EXCELLENCE. BUILDING TRUST TM				
MILESTONE ISSUE DATES				
PRELIMINARY SET:				
BUDGET SET:				
LOCAL DESIGN REVIEW SET:	08/08/2023			
PROPOSAL SET:				
CONSTRUCTION SET:				
RECORD DRAWING SET:				
REVISIONS:				

CONSULTANT LOGO	

KEY PLAN


ST. JOHN'S WAUWATOSA CHURCH ADDITION

PROJECT DESCRIPTIO
NEW FACILITY

7809 HARWOOD AVE

WAUWATOSA, WISCONSIN 53213

ALL WORK TO BE COMPLETED AS SHOWN, AND IN ACCORDANCE WITH THE LATEST EDITION OF THE MSI GENERAL MASTER SPECIFICATION

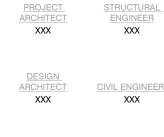

DESIGN
ARCHITECT CIVIL ENGINEER: REVIEWED BY
XXX XXX XXX

LANDSCAPE DESIGN XXX

EXTERIOR ELEVATIONS

SHEET NU P13586



SOUTH ELEVATION



SOUTHWEST ELEVATION



PATIO ELEVATION

N.T.S.

EXTERIOR RENDERINGS



MSI GENERAL CORPORATION P.O. BOX. 7 OCONOMOWOC, WI 53066 PHONE: 262-367-3661 FAX: 262-367-7390

WWW.MSIGENERAL.COM
SINGLE SOURCE RESPONSIBILITY TM

ISSUE DATES:	
LOCAL DESIGN REVIEW SET:	08/08/2023
Proposal:	xx/xx/xxxx
Bid:	xx/xx/xxxx
Contract:	xx/xx/xxxx
State Submittal / Permit:	xx/xx/xxxx
As-Built:	xx/xx/xxxx
REVISIONS:	

ST. JOHN'S WAUWATOSA

PROJECT ADDRESS:

PROJECT NAME
St. John's Evangelical Lutheran Church
STREET ADDRESS
7809 Harwood Ave.
CITY/ STATE / ZIP
Wauwatosa, WI 53213

ALL WORK TO BE COMPLETED AS SHOWN, AND IN
ACCORDANCE WITH THE LATEST EDITION OF THE
MSI GENERAL MASTER SPECIFICATION

Architect: Engineer: Reviewed By:

AMH -- -Sheet Title:

EXTERIOR RENDERINGS

A-203

P13586