
#### Project Sheet Legend:

LGD0.1	LEGEND SHEET
AGL0.2	ACCESSIBILITY SHEET
SD1.1	PROPOSED SITE PLAN
SD1.2	PROPOSED GRADING PLAN
SD1.3	PROPOSED PLAZA CROSS-SECTION AND DETAILS
SD1.4	PROPOSED HARDSCAPE MATERIALS
LSP1.1	PROPOSED LANDSCAPE PLAN
LSP1.2	PROPOSED LANDSCAPE DETAILS
LGT1.1	PROPOSED LIGHTING PLAN
LGT1.2	PROPOSED PROJECT LIGHT FIXTURES
LGT1.3	PROPOSED PROJECT LIGHT FIXTURES

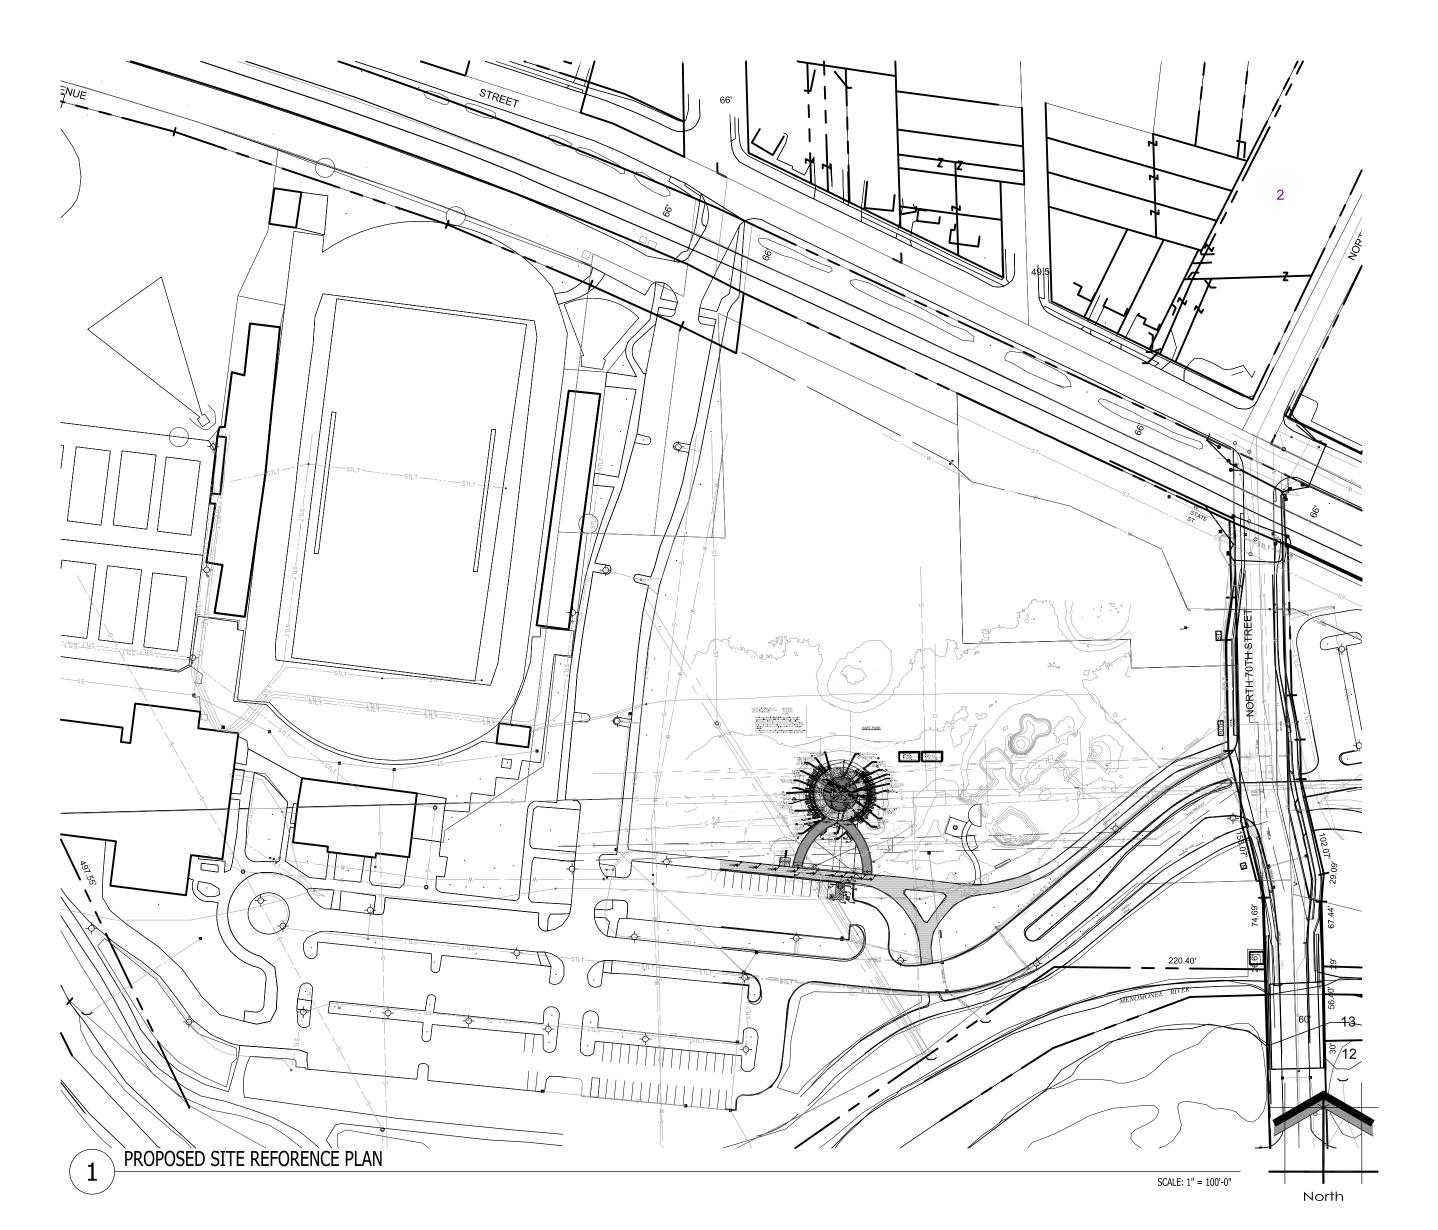

#### **GENERAL SITE NOTES:**

- 1. ALL PAVING RADII SHALL BE 5'-0" UNLESS NOTED OTHERWISE.
- PROVIDE CONCRETE SIDEWALKS AS INDICATED ON PLAN.
- UTILITY DESIGN AND WORK BY DESIGN / BUILD CONTRACTOR.
- 4. GRADING AT ACCESSIBLE ROUTE TO COMPLY WITH COMM, CH. 69 DESIGN GUIDELINES.
- 5. FINISHED FLOOR ELEVATION = 100'-0" ON ARCHITECTURAL DRAWINGS VERIFY ACTUAL ELEVATION WITH DESIGN / BUILD CONTRACTOR
- 6. SITE ENGINEERING (ELECTRICAL, STORM WATER DRAINAGE, ETC.) BY DESIGN / BUILD CONTRACTOR.
- 7. ALL PROPERTY LINE BEARINGS AND LENGTHS BASED ON OWNER PROVIDED DATA.
- 8. VERIFY EXACT PLAZA PLACEMENT WITH DESIGN / BUILD CONTRACTOR.
- 9. CONSTRUCTION SITE EROSION AND SEDIMENTATION CONTROL SHALL COMPLY WITH THE REQUIREMENTS OF THE CITY OF WAUWATOSA AND SHALL EMPLOY EROSION CONTROL
- METHODS AS SHOWN AND SPECIFIED IN THE DEPARTMENT OF NATURAL RESOURCES WISCONSIN CONSTRUCTION SITE BEST MANAGEMENT PRACTICES HANDBOOK (BMP 10. MANDEROSTON CONTROL MEASURES SHALL BE ADJUSTED TO MEET FIELD CONDITIONS AT THE TIME OF CONSTRUCTION AND SHALL BE INSTALLED PRIOR TO ANY GRADING OR DISTURBANCE OF EXISTING SURFACE MATERIAL ON THE SITE.
- 11. PERIODIC INSPECTION AND MAINTENANCE OF ALL EROSION CONTROL STRUCTURES SHALL BE PROVIDED TO INSURE INTENDED PURPOSE IS ACCOMPLISHED. CONTRACTOR SHALL
- BE RESPONSIBLE FOR CLEANUP AND REMOVAL OF ALL SEDIMENT LEAVING PROPERTY. EROSION CONTROL MEASURES SHALL BE IN WORKING CONDITION AT END OF EACH WORK
- 12. SAY FENCE SHALL BE INSTALLED IN ALL LOCATIONS WHERE POTENTIAL RUNOFF AND CONTAMINATION MAY OCCUR.
- 13. EROSION CONTROL MEASURES SHALL BE MAINTAINED ON A CONTINUING BASIS UNTIL SITE IS FULLY STABILIZED. 14. ALL EROSION AND SEDIMENT CONTROL PRACTICES TO BE CHECKED FOR STABILITY AND OPERATION FOLLOWING EVERY RUNOFF-PRODUCTION RAINFALL EVENT. ANY
- NEEDED REPAIRS REPAIRS SHALL SHALL BE MADE IMMEDIATELY TO MAINTAIN ALL PROTECTION AS DESIGNED.
- 15. SEDIMENT IS TO BE REMOVED FROM BEHIND THE SEDIMENT FENCE WHEN IT BECOMES .05 FEET DEEP AT THE FENCE. REPAIR THE FENCE AS NECESSARY TO MAINTAIN BARRIER. 16. SEE ALL RELATED DETAILS AND REMAINING SHEETS SPECIFICATION FOR ADDITIONAL INFORMATION AND HOW IT RELATES TO THE SCOPE OF THE PROJECT.

#### EXISTING CONDITIONS GENERAL NOTES

- INFORMATION PERTAINING TO EXISTING CONDITIONS GIVEN ON THESE LANDSCAPE DRAWINGS REPRESENTS TO THE BEST OF OUR KNOWLEDGE THE ACTUAL EXISTING FIELD CONDITIONS. INSITE LANDSCAPE DESIGN, INC. MAKES NO WARRANTY AS TO THEIR ACCURACY. CONTRACTOR TO FIELD VERIFY EXISTING CONDITIONS IMPERATIVE TO THEIR NEW WORK, REPORT ANY DISCREPANCIES BETWEEN THE DRAWINGS AND FIELD CONDITIONS TO THE LANDSCAPE ARCHITECT FOR REVIEW. ANY WORK PERFORMED PRIOR TO RESOLUTION OF DISCREPANCIES BY THE LANDSCAPE ARCHITECT IS SUBJECT TO REMOVAL AND REPLACEMENT AT NO ADDITIONAL COST TO THE CONTRACT.
- THE LOCATIONS OF EXISTING UTILITY INSTALLATIONS AS SHOWN ON THIS PLAN ARE APPROXIMATE. THERE MAY BE UNDERGROUND UTILITY INSTALLATIONS WITHIN THE PROJECT AREA OF DISTURBANCE THAT ARE NOT SHOWN. THE CONTRACTOR SHALL BE RESPONSIBLE FOR VERIFYING THE EXISTENCE AND LOCATION OF ALL UNDERGROUND UTILITIES.
- VERIFY ALL EXISTING CONDITIONS, DIMENSIONS, AND ALIGNMENT OF WALLS. BRING ANY DISCREPANCIES TO THE LANDSCAPE ARCHITECTS ATTENTION PRIOR TO FABRICATION /
- 4. VERIFY LOCATION OF ACCESS PANELS W/ MECHANICAL AND ELECTRICAL EQUIPMENT FOR ACCESSIBILITY OF MECHANICAL & ELECTRICAL ITEMS. VERIFY LOCATIONS OF ALL BURIED UTILITIES AND STRUCTURES AND LOCATIONS OF ALL OVERHEAD WIRES.
- M VERIFY LOCATION OF ALL EXISTING EASEMENTS. INSITE LANDSCAPE DESIGN, INC, ASSUMES NO RESPONSIBILITY FOR DAMAGES, LIABILITY OR COSTS RESULTING FROM CHANGES OR ALTERATIONS MADE TO THIS PLAN WITHOUT

#### THE EXPRESSED WRITTEN CONSENT OF INSITE LANDSCAPE DESIGN, INC.

SITE DEMOLITION GENERAL NOTES:

- INFORMATION PERTAINING TO EXISTING CONDITIONS GIVEN ON THESE SITE IMPROVEMENT DRAWINGS REPRESENTS TO THE BEST OF OUR KNOWLEDGE THE ACTUAL EXISTING FIELD CONDITIONS. INSITE LANDSCAPE DESIGN, INC. MAKES NO WARRANTY AS TO THEIR ACCURACY. CONTRACTOR TO FIELD VERIFY EXISTING CONDITIONS IMPERATIVE TO THEIR NEW WORK. REPORT ANY DISCREPANCIES BETWEEN THE DRAWINGS AND FIELD CONDITIONS TO THE ARCHITECT FOR REVIEW. ANY WORK PERFORMED PRIOR TO RESOLUTION OF DISCREPANCIES BY THE LANDSCAPE ARCHITECT IS SUBJECT TO REMOVAL AND REPLACEMENT AT NO ADDITIONAL COST TO
- 2. ALL EXISTING CONDITIONS SHALL BE REMOVED AS REQUIRED TO ACCOMMODATE PROPOSED CONSTRUCTION, WHETHER OR NOT NOTED ON DEMOLITION PLAN. (COORDINATE WITH MECH. & ELEC. DRAWINGS)
- 3. SURFACES ADJACENT TO REMOVAL AREAS SHALL BE PATCHED AND CLEANED. NEW CONSTRUCTION TO MATCH EXISTING ADJACENT SURFACES / FINISHES (UNLESS
- NOTED OTHERWISE) 4. PROVIDE DUST CONTROL AND/OR TEMPORARY BARRIERS / PARTITIONS AS REQUIRED BETWEEN CONSTRUCTION AREAS
- 5. PROVIDE A SAFE PASSAGE THROUGH AND/OR AROUND CONSTRUCTION AREAS AS REQUIRED TO MAINTAIN INGRESS/EGREES AT SHARED ACCESS POINT FOR
- 6. KEEP NOISE TO A LEVEL ACCEPTABLE TO OWNER. AND IN COMPLIANCE WITH LOCAL ORDINANCES.
- 7. REFER MECHANICAL & ELECTRICAL DRAWINGS FOR ADDITIONAL DEMOLITION NOTES.

#### SITE GRADING PLAN GENERAL NOTES

- PROVIDE PERVIOUS SIDEWALKS AS INDICATED ON PLANS. REFER TO DETAILS FOR ADDITIONAL INFORMATION.
- UTILITY DESIGN AND WORK BY DESIGN / BUILD CONTRACTOR. GRADING AT ACCESSIBLE ROUTE TO COMPLY WITH COMM. CH. 69 DESIGN GUIDELINES.
- FINISHED FLOOR ELEVATION = 1040'-0" ON ARCHITECTURAL DRAWINGS VERIFY ACTUAL ELEVATION WITH DESIGN / BUILD CONTRACTOR
- ALL PROPERTY LINE BEARINGS AND LENGTHS BASED ON OWNER AND DESIGN / BUILD CONTRACTOR PROVIDED DATA.
- VERIFY EXACT BUILDING PLACEMENT WITH GENERAL CONTRACTOR AND PROVIDED CIVIL ENGINEERING INFORMATION. FOR DEMOLITION INFORMATION REFER TO ARCHITECTURAL DRAWINGS AND SD1.3
- CONSTRUCTION SITE EROSION AND SEDIMENTATION CONTROL SHALL COMPLY WITH THE REQUIREMENTS OF THE COUNTY AND SHALL EMPLOY EROSION CONTROL METHODS AS SHOWN AND SPECIFIED IN THE DEPARTMENT OF NATURAL RESOURCES WISCONSIN CONSTRUCTION SITE BEST MANAGEMENT PRACTICES HANDBOOK (BMP HANDBOOK).
- ALL FROSION CONTROL MEASURES SHALL BE ADJUSTED TO MEET FIELD CONDITIONS AT THE TIME OF CONSTRUCTION AND SHALL BE INSTALLED PRIOR TO ANY GRADING OR DISTURBANCE OF EXISTING SURFACE MATERIAL ON THE SITE.
- 10. PERIODIC INSPECTION AND MAINTENANCE OF ALL EROSION CONTROL STRUCTURES SHALL BE PROVIDED TO INSURE INTENDED PURPOSE IS ACCOMPLISHED CONTRACTOR SHALL BE RESPONSIBLE FOR CLEANUP AND REMOVAL OF ALL SEDIMENT LEAVING PROPERTY. EROSION CONTROL MEASURES SHALL BE IN WORKING
- 11. SILT FENCE SHALL BE INSTALLED IN ALL LOCATIONS WHERE POTENTIAL RUNOFF AND CONTAMINATION MAY OCCUR.

12. EROSION CONTROL MEASURES SHALL BE MAINTAINED ON A CONTINUING BASIS UNTIL SITE IS FULLY STABILIZED

- 13. ALL EROSION AND SEDIMENT CONTROL PRACTICES TO BE CHECKED FOR STABILITY AND OPERATION FOLLOWING EVERY RUNOFF-PRODUCTION RAINFALL EVENT. ANY NEEDED REPAIRS REPAIRS SHALL SHALL BE MADE IMMEDIATELY TO MAINTAIN ALL PROTECTION AS DESIGNED.
- 14. SEDIMENT IS TO BE REMOVED FROM BEHIND THE SEDIMENT FENCE WHEN IT BECOMES .05 FEET DEEP AT THE FENCE. REPAIR THE FENCE AS NECESSARY TO MAINTAIN
- 15. SEE ALL RELATED DETAILS AND REMAINING SHEETS SPECIFICATION FOR ADDITIONAL INFORMATION AND HOW IT RELATES TO THE SCOPE OF THE PROJECT. 16. ADDITIONAL GRADING OF GRASSED OR LANDSCAPED AREAS MAY BE REQUIRED DUE TO THE PLUMBING, SANITARY OR OTHER UNDERGROUND UTILITY WORK - REVIEW
- DOCUMENTS IN THEIR ENTIRETY TO DETERMINE FULL SCOPE OF WORK. 17. CONSTRUCTION LIMITS - FENCING AS REQUIRED. 18. ALL CONSTRUCTION, CONSTRUCTION TRAFFIC, DELIVERIES STORAGE OF MATERIALS, VEHICLES DUMPSTERS AND OTHER CONSTRUCTION RELATED ITEMS ARE TO BE
- LOCATED IN THIS AREA ONLY. PROTECT AND SURROUND AREA AS NECESSARY. 19. CONSTRUCTION ENTRY - RESTRICTED TO CONSTRUCTION PERSONNEL. CONSTRUCTION DELIVERIES AND PERSONNEL ARE TO USE THIS ENTRANCE ONLY.

#### SILT FENCE CONSTRUCTION:


- 1. CONSTRUCT SILT FENCE AROUND THE DISTURBED AREAS AS SHOWN ON PLAN, SHEET SD1.2, TO PREVENT SEDIMENT FROM BEING WASHED INTO STORM WATER
- LOCATE SUPPORT POSTS DOWN SLOPE OF FILTER FABRIC TO HELP SUPPORT FENCING

WITHIN THE PROJECT AREA THAT ARE NOT SHOWN.

- WHEN JOINTS ARE NECESSARY, SECURELY FASTEN THE FILTER FABRIC AT A SUPPORT POST AND OVERLAP SLICE TO THE NEXT POST. 4. SEDIMENT CONTROL FILTER FABRIC DESIGNED TO IMPEDE SILT FUN-OFF AND PREVENT TOP SOIL EROSION TO CONSIST OF NYLON POLYESTER, PROPYLENE, OR ETHYLENE
- YAM. MUST MEET WISDOT SPECIFICATIONS AND STANDARDS OF A MINIMUM 50 Ib./LINEAR INCH GRAB TENSILE STRENGTH, A MINIMUM FLOW RATE OF 0.3 GALS./SQ. FT., AND SHOULD CONTAIN ULTRAVIOLET RAY INHIBITORS AND STABILIZERS.

Call before you dig

- 5. SEDIMENT CONTROL FILTER FABRIC SHALL BE ANCHORED BY SPREADING 8" OF FABRIC IN A 4"x4" TRENCH. LOOSE DIRT TO BE COMPACTED BACK IN TRENCH ON TOP
- SEDIMENT CONTROL FILTER FABRIC SHALL BE FASTENED TO THE UP-SLOPE SIDE OF 2"x2"x3'-0" PINE POSTS. POSTS TO BE SPACED A MAXIMUM OF 6'-0" APART. 7. PROVIDE INLET GRATE SCREENS AS NEEDED, FIELD LOCATE ALL WITHIN AREA OF CONSTRUCTION SITE SILT FENCE, REFER TO DETAILS 2/SD1.2 - 5SD1.2

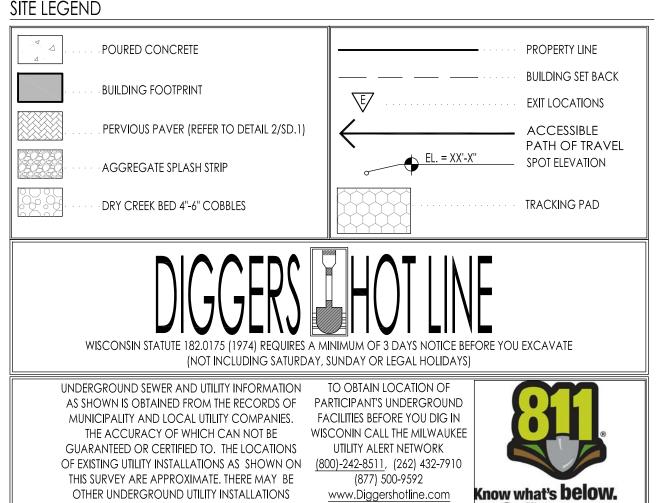

#### LANDSCAPE PLAN GENERAL NOTES

#### PLANT MATERIAL SHOWN ON LANDSCAPE PLAN IS DEPICTED AT MATURE GROWTH.

- 1. AT LEAST SEVENTY-TWO HOURS PRIOR TO ANY EXCAVATION, CONTRACTOR SHALL VERIFY UTILITY LOCATIONS AS GIVEN BY THE ELECTRIC, GAS, TELEPHONE, WATER, SEWER, AND CABLE TELEVISION COMPANIES, UTILITIES OR ENTITIES. REVIEW WITH OWNER'S REPRESENTATIVE SITE MECHANICAL, SITE ELECTRICAL AND LIGHTING, SITE GRADING AND DRAINAGE, SITE IRRIGATION AND ALL OTHER DRAWINGS PERTAINING TO UNDERGROUND UTILITY LOCATIONS. RECORD SET OF INFORMATION THE SAME AS IN POSSESSION OF OWNER'S REPRESENTATIVE. ALSO REVIEW OWNER'S "MARK SETS" OF ALL OF THESE DRAWINGS IN POSSESSION OF THE CONTRACTOR OR OWNER. MARK ALL SUCH UTILITIES ON THE SITE PRIOR TO COMMENCING. COORDINATE WITH OWNER BEFORE AND DURING CONSTRUCTION. REPAIR ANY DAMAGE TO ANY SYSTEM THAT IS CAUSED BY LANDSCAPE CONTRACTOR AT NO COST TO OWNER.
- 2. ALL PLANTINGS SPECIFIED FOR THE WAUWATOSA VETERANS MEMORIAL PLAZA PROJECT PLANTING TABLES SHALL COMPLY WITH STANDARDS AS DESCRIBED IN AMERICAN STANDARD OF NURSERY STOCK ANSI Z60.1 2014 AND ANSI STANDARDS FOR PLANTING 2012.
- ALL DEVIATIONS FROM THE APPROVED WAUWATOSA VETERANS MEMORIAL PLAZA PROJECT PLANS SHALL BE NOTED ON THE RECORD DRAWINGS BY THE CONTRACTOR AND MAY BE EXECUTED ONLY WITH PRIOR APPROVAL FROM THE LANDSCAPE ARCHITECT AND OWNER'S REPRESENTATIVE. VERBAL AGREEMENTS OR REVISIONS WITHOUT A CHANGE ORDER WILL NOT BE RECOGNIZED BY LANDSCAPE ARCHITECT AND OWNER.
- 4. ALL PLANTS MUST BE BID AND SELECTED PER THE SPECIES SPECIFIED ON THE PLANS. ANY SPECIES SUBSTITUTIONS MUST BE APPROVED IN WRITING BY LANDSCAPE ARCHITECT. THE SIZES OF PLANT MATERIAL LISTED HEREIN IS A MINIMUM ACCEPTABLE SIZE. ADDITIONALLY, IF EXCESSIVE PRUNING REDUCES THE CROWN THE PLANT SHALL BE REPLACED.
- 5. PROTECT PUBLIC FROM CONSTRUCTION WITH BARRIERS AND BARRICADES.
- 6. ALL AREAS THAT WERE DISTURBED DURING CONSTRUCTION AND AREAS NOT COVERED WITH PAVEMENT, BUILDING, PLANTING BEDS, OR TREE PITS ARE TO BE TOPSOILED 3" DEEP (MIN.) AND SHALL BE SODDED/SEEDED WITH SPECIFIED LAWN GRASS. LANDSCAPE CONTRACTOR SHALL INCLUDE COST PER SQUARE YARD FOR ADDITIONAL SEED OPERATIONS AS MAY BE POSSIBLY REQUIRED TO REESTABLISH ADJACENT TURF GRASS AREAS WHICH MAY BECOME DAMAGED DURING THE CONSTRUCTION PROCESS OR TO REPAIR DAMAGE DONE BY OTHERS.
- CONTRACTOR IS RESPONSIBLE FOR FURNISHING ALL MATERIALS, TOOLS, EQUIPMENT, LABOR, AND PLANTS NECESSARY FOR PROPER PLANTING AND INSTALLATION OF ALL LANDSCAPE MATERIAL.
- 8. QUANTITIES ON PLANT MATERIALS LIST ARE FOR CONVENIENCE OF BIDDING ONLY. CONTRACTOR IS RESPONSIBLE FOR ALL PLANTS SHOWN ON LANDSCAPE PLANS AND COVERAGE OF ALL AREAS DELINEATED. THE PLANS ARE TO SUPERSEDE THE PLANT LIST IN ALL CASES.
- 9. CONTRACTOR IS RESPONSIBLE FOR ALL ESTIMATING AND BIDDING, ALL AREAS, QUANTITIES MATERIALS SHOULD BE FIELD VERIFIED WITH SITE CONDITION.
- 10. WHERE DISCREPANCIES OCCUR BETWEEN THE LANDSCAPE PLANS AND/OR ARCHITECTURAL AND/OR THE CIVIL DRAWINGS (AND ANY OTHER SITE DRAWINGS) THE DISCREPANCIES MUST BE BROUGHT TO THE LANDSCAPE ARCHITECTS ATTENTION FOR COORDINATION AND RESOLUTION.
- 11. ALL DISEASED, NOXIOUS OR INAPPROPRIATE MATERIALS SHALL BE REMOVED FROM THE PROPOSED SITE PRIOR TO THE START OF CONSTRUCTION AND DURING THE MAINTENANCE PERIOD.
- 12. GENERAL CONTRACTOR SHALL LEAVE THE SITE FREE OF CONSTRUCTION DEBRIS.
- 13. ALL LAWN AND PLANTING AREAS SHALL SLOPE TO DRAIN A MINIMUM OF 2% UNLESS NOTED OTHERWISE AND REVIEWED WITH OWNER'S REPRESENTATIVE FOR FINAL APPROVAL.
- 14. FINISH GRADES FOR SHRUB AND GROUND COVER AREAS SHALL BE HELD 1" BELOW TOP OF ADJACENT PAVEMENTS AND CURBS, UNLESS NOTED OTHERWISE ON THE PLANS. REFER TO LSP1.2 FOR FURTHER INFORMATION.
- 15. ALL PERENNIAL, ANNUAL AND GROUND COVER AREAS TO RECEIVE A BLEND OF ORGANIC SOIL AMENDMENTS PRIOR TO PLANTING. TILL THE FOLLOWING MATERIALS INTO EXISTING TOPSOIL TO A DEPTH OF APPROXIMATELY 8". A DEPTH OF 12" IN TREE PITS. PROPORTIONS AND QUANTITIES MAY REQUIRE ADJUSTMENT DEPENDING ON THE CONDITION OF EXISTING SOIL. REFER TO LSP1.2 FOR FURTHER
  - PER EVERY 100 SQUARE FEET ADD: ONE 2 CUBIC FOOT BALE OF PEAT MOSS, 2 POUNDS OF 5 -10 -5 GARDEN FERTILIZER, 1/4 CUBIC YARD OF COMPOSTED MANURE OR OTHER COMPOSTED, ORGANIC
- 16. ALL SHRUBS TO BE POCKET PLANTED WITH A 50/50 MIX OF COMPOSTED, ORGANIC MATERIAL AND EXISTING SOIL. INSTALL TOPSOIL INTO ALL BEDS AS NEEDED TO ACHIEVE PROPER GRADE. REMOVE ALL EXCESSIVE GRAVEL, CLAY AND STONES. REFER TO LSP1.2 FOR FURTHER INFORMATION.
- 17. PLANT ALL TREES SLIGHTLY HIGHER THAN FINISHED GRADE AT ROOT FLARE. BACK FILL HOLE WITH 2/3 EXISTING TOPSOIL AND ORGANIC SOIL AMENDMENTS SPECIFIED IN NOTE 15. AVOID ANY AIR POCKETS. DISCARD ANY GRAVEL CLAY OR STONES. REFER TO LSP1.2 FOR FURTHER INFORMATION.
- 18. ALL TREES TO BE INSTALLED, STAKED AND GUYED ACCORDING TO DETAILS. REFER TO ANSI STANDARDS FOR PLANTING 2012 AND DETAILS ON LSP1.2 FOR FURTHER INFORMATION.
- 19. PROVIDE A 4'-0" 5'-0" DIAMETER MULCH RING AT THE ROOT BALL FLARE OF ALL LAWN TREES.

DAMAGE OR COVER PLANTS. REFER TO LSP1.2 FOR FURTHER INFORMATION.

- 20. ALL PLANTINGS TO BE WATERED AT THE TIME OF PLANTING, THROUGHOUT CONSTRUCTION AND UPON COMPLETION OF PROJECT AS REQUIRED.
- 21. WHERE SPECIFIED, ALL PLANT BEDS, PITS AND TREE RINGS ARE TO RECEIVE A MINIMUM OF 2" 3" DRESSING OF SHREDDED HARDWOODM OAK BARK MULCH SHAVINGS FREE OF GROWTH, WEEDS, FOREIGN MATTER DETRIMENTAL TO PLANT LIFE OR GERMINATION INHIBITING INGREDIENTS. LANDSCAPE CONTRACTOR TO PROVIDE A SAMPLE TO OWNER FOR APPROVAL. CONTRACTOR TO TAKE CARE WITH INSTALLATION NOT TO
- 22. LAWN INSTALLATION: CONTRACTOR TO FURNISH AND PREPARE TOPSOIL (3" MIN) AND SEED BED (REMOVE ALL STONES 1" OR LARGER), APPLY STARTER FERTILIZER AND SEED UNIFORMLY. PROVIDE A MULCH COVERING SUITABLE TO GERMINATE AND ESTABLISH TURF. EROSION CONTROL MESH SHOULD BE USED IN SWALES AND STEEP GRADES WHERE APPLICABLE. METHODS OF INSTALLATION MAY VARY AT THE DISCRETION OF CONTRACTOR. IT IS HIS/HER RESPONSIBILITY TO ESTABLISH AND GUARANTEE A SMOOTH, UNIFORM,

QUALITY TURF. IF STRAW MULCH IS USED AS A COVERING, A TACKIFIER MAY BE NECESSARY TO AVOID WIND

- 23. DELUXE 50 GRASS SEED MIX REINDER'S (800) 785-3301
- 20% KENTUCKY BLUE GRASS
- 15% NEWPORT KENTUCKY BLUE GRASS 15% SR 2100 Kentucky Bluegrass
- 25% Creeping Red Fescue 15% Replicator Perennial Ryegrass
- 10% Fiesta 4 Perennial Ryegrass APPLY AT A RATE OF 200 POUNDS PER ACRE. REFER TO SUPPLIERS SPECIFICATIONS & INSTALLATION CUT SHEETS FOR FURTHER FORMATION
- 24. DURING THE INITIAL "30 DAY MAINTENANCE PERIOD" THE LANDSCAPE CONTRACTOR IS REQUIRED TO PROVIDE AND ON-GOING PLEASANT VISUAL ENVIRONMENT WHEREAS ANY PLANT WHICH IS NOT RESPONDING TO TRANSPLANTING OR THRIVING SHALL IMMEDIATELY BE REPLACED. NEW LAWNS SHALL BE WATERED AND REPAIRED AND WEEDS MUST CONSTANTLY BE REMOVED, NO EXCEPTIONS WILL BE GRANTED. MAINTENANCE NOTE
  - MAINTENANCE IS THE RESPONSIBILITY OF THE PROPERTY OWNER TO MAINTAIN REQUIRED LANDSCAPING IN ACCORDANCE WITH THE MUNICIPALITY'S PROPERTY MAINTENANCE CODE AND AN APPROVED MAINTENANCE PLAN. THE MAINTENANCE MUST INCLUDE, AT A MINIMUM, METHODS FOR PROVIDING THE FOLLOWING:
  - NECESSARY IRRIGATION (if REQUIRED)
  - INTEGRATED PEST MANAGEMENT, PROPER FERTILIZATION
  - TREE CARE AND PRUNING, SHRUB TIP CLIPPING AND SHAPING AS REQUIRED
  - REPLACEMENT OF LOST VEGETATION, AND ALL DISEASED, DAMAGED, OR DEAD MATERIAL WILL BE
  - REPLACED BY THE END OF THE FOLLOWING PLANTING SEASON IN PERPETUITY. WEED MANAGEMENT AND BED CARE.
- 25. ALL NEWLY PLANTED TREES AND SHRUBS ARE TO RECEIVE AN APPLICATION OF AN ANTI-TRANSPLANT SPRAY THAT WILL EFFECTIVELY REDUCE THE WATER LOSS OF TRANSPIRATION OF PLANT MATERIAL AND REDUCE THE STRESS OF TRANSPLANTATION. IT IS RECOMMENDED AS PART OF THE ONGOING MAINTENANCE THAT ANY BROADLEAF EVERGREEN AND CONIFEROUS TREE AND SHRUBS (EXCLUDING ARBORVITAE) RECEIVE AN APPLICATION OF AN ANTI-DESICCANT SPRAY TO REDUCE THE LOSS OF MOISTURE DUE TO WINTER DESICCATION.
- 26. MAINTENANCE. THE OWNER SHALL TEND AND MAINTAIN ALL PLANT MATERIALS IN A HEALTHY GROWING CONDITION AS PER THE APPROVED PLAN. PLANTINGS SHALL BE REPLACED WHEN NECESSARY AND KEPT FREE FROM REFUSE & DEBRIS. ALL PLANTING MATERIAL WHICH IS DYING OR DAMAGED BEYOND RECOVERY SHALL BE REPLACED WITHIN SIX (6) MONTHS OR BY THE NEXT PLANTING SEASON, WHICHEVER COMES FIRST. CONTRACTOR TO PROVIDE 1 YEAR PLANT MATERIAL WARRANTY.

Landscape Consulting & Master Planning Design Sevices

11525 W. North Avenue, Suite 1B Wauwatosa, WI 53226 Tel (414) 476-1204 www.insitedesigninc.com mdavis@insitedesigninc.com

Project for:

#### WAUWATOSA **VETERANS COMMITTEE**

Wauwatosa, WI

#### WAUWATOSA **VETERANS MEMORIAL** at HART PARK

72nd Street - Hart Park Wauwatosa, WI 53226

Issuance and Revisions:

06/05/23	Client Review Submittal
06/29/23	Parks Dept Prelim Meeting
07/17/23	Parks Dept Meeting
08/28/23	Client Review Submittal
09/20/23	Phase I Construction Document Submittal

|Number | Description

Design Review

Board Submittal

Revisions based on

Comments / Design

Staff Review

**Review Board** 

Re-Submittal

COPYRIGHT InSite Landscape Design Inc. 2020 ALL RIGHTS RESERVED THIS DRAWING IS NOT TO BE REPRODUCED, CHANGED, COPIED OR ASSIGNED TO ANY THIRD PARTY IN ANY FORM OR MANNER WITHOUT FIRST OBTAINING THE EXPRESSED WRITTEN PERMISSION OF InSite Landscape Design, Inc. THE CLIENT AGREES TO INDEMNIFY AND HOLD THE InSite Landscape Design Inc. HARMLESS FROM ANY DAMAGES, LIABILITY, OR COST, INCLUDING ATTORNEY'S FEES AND COSTS OF DEFENSE ARISING FROM ANY CHANGES OR ALTERATIONS MADE BY ANYONE OTHER THAN THE InSite Landscape Design Inc., OR FROM ANY REUSE OF THE DRAWINGS OR DATA

WITHOUT THE PRIOR WRITTEN CONSENT OF THE

InSite Landscape Design Inc.

PROPOSED PLAZA PLAN SET GENERAL NOTES AND SITE INFORMATION,

Date of Drawing:	09/09/25
Scale:	1" = 20'-0"
Drawn By:	MCD
Job Number:	L23-025


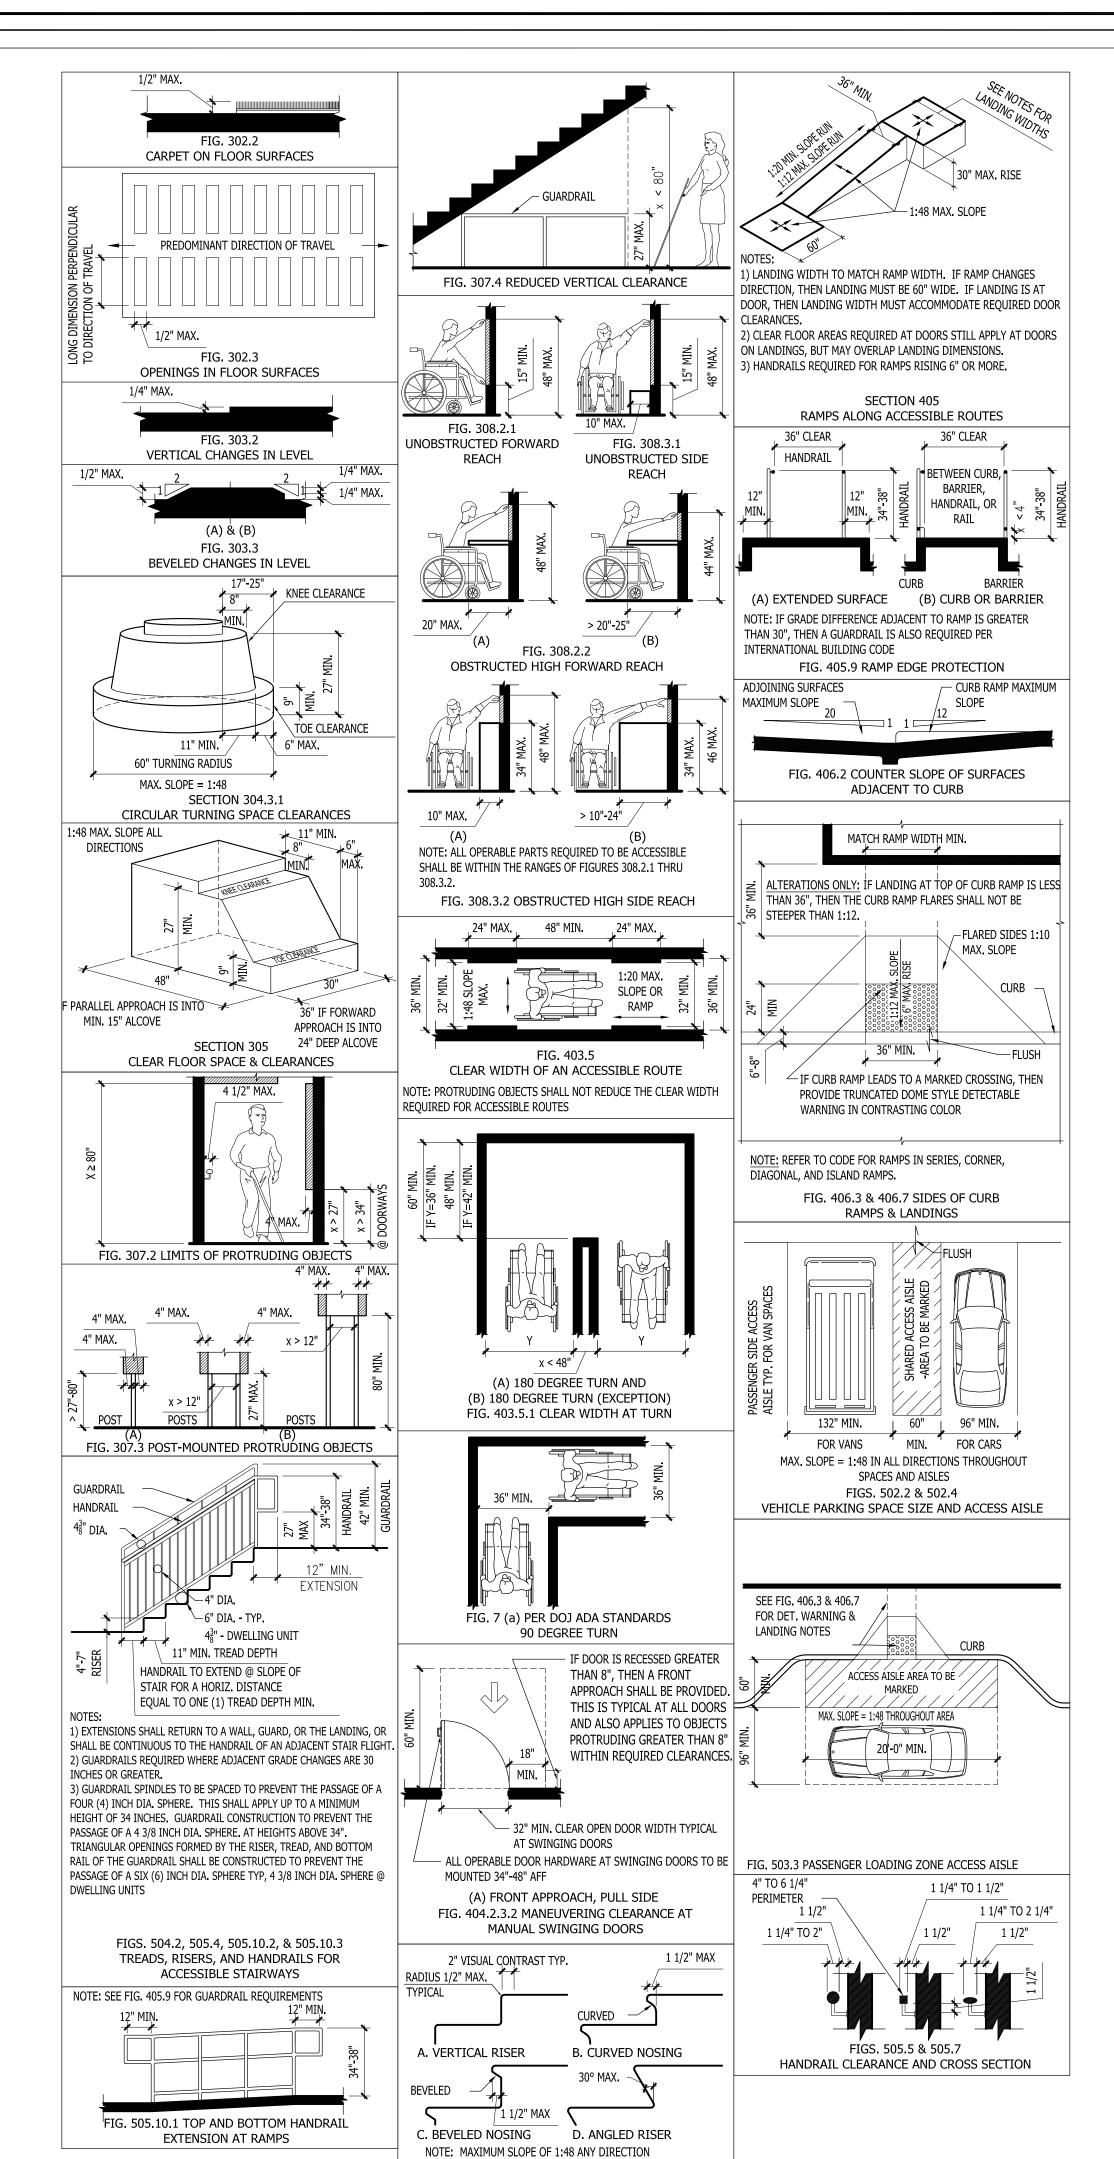


FIG. 504.5 STAIR NOSINGS

ITEMS SHOWN ON THIS SHEET DO NOT NECESSARILY REPRESENT WORK BEING COMPLETED UNDER THIS CONTRACT. SEE OTHER SHEETS FOR SCOPE OF WORK. MATERIAL ON THIS SHEET IS TAKEN DIRECTLY FROM THE FOLLOWING SOURCES: -ICC/ANSI A117.1-2003 INTERNATIONAL CODE COUNCIL AMERICAN NATIONAL STANDARD INSTITUTE -2010 ADA STANDARDS - SEP. 15TH, 2010 DEPARTMENT OF JUSTICE CODE OF FEDERAL REGULATIONS ADA STANDARDS FOR ACCESSIBLE DESIGN -ACCESSIBILITY GUIDELINES JULY 23, 2004 UNITED STATES ACCESS BOARD AMERICANS WITH DISABILITIES ACT AND ARCHITECTURAL BARRIERS ACT ACCESSIBILITY GUIDELINES THE MATERIAL THOUGH IS NOT IN ITS ORIGINAL ENTIRETY AND THE INTENT OF THIS PAGE IS TO POINT OUT THE MOST IMPORTANT & PREVALENT ISSUES STATED IN THE ABOVE MENTIONED SOURCES. IT IS THE CONTRACTOR'S RESPONSIBILITY TO FOLLOW THE ORIGINAL SOURCES TO THEIR ENTIRETY.

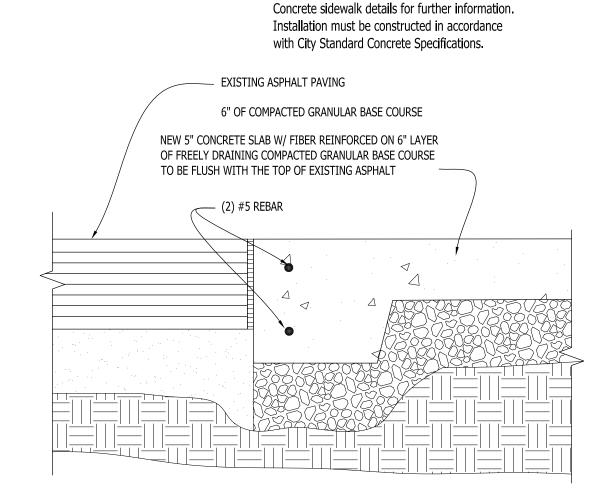


CONCRETE INSTALLER NOTE:

Concrete Contractor to refer to City standard


NEW REINFORCED CONCRETE/EXISTING ASPHALT JOINT SCALE: 1 1/2" = 1'-0"

> CONCRETE INSTALLER NOTE: Concrete Contractor to refer to City standard Concrete sidewalk details for further information. Installation must be constructed in accordance with City Standard Concrete Specifications.

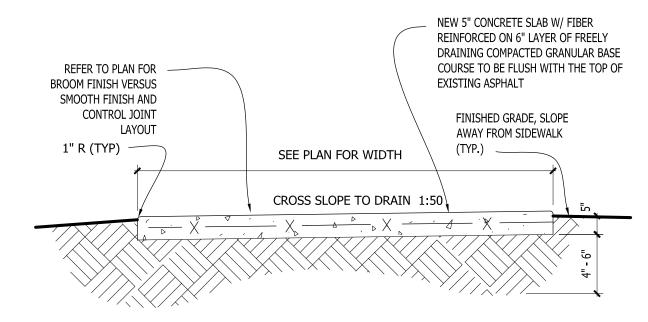


CONCRETE SIDEWALK CROSSSECTION

SCALE: 1/2"=1'-0"

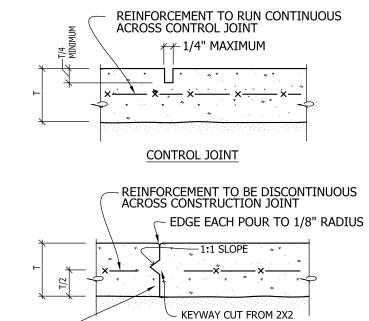

- BREAK THE BOND BTW. NEW AND PREVIOUSLY PLACED SLABS BY SPRAYING OR PAINTING THE EXPOSED SIDE OF JOINT WITH A CURING COMPOUND, ASPHALTIC EMULSION OR FORM OIL

1) SLABS TO BE PLACED USING THE LONG STRIP CONSTRUCTION METHOD. 2) REFER TO GENERAL NOTES, SPECIFICATIONS AND / OR DRAWINGS FOR SUBGRADE PREPARATION REQUIREMENTS. 3) SLAB REINFORCEMENT, IF OTHER THAN WWF, SHALL BE CHAIRED BY SOIL SUPPORTED SLAB BOLSTERS.

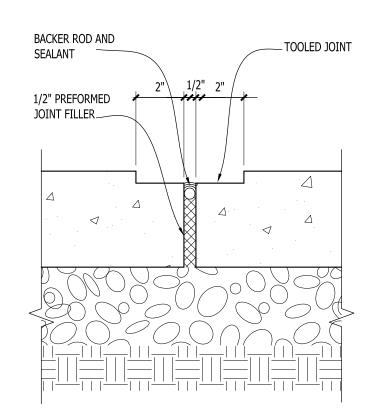



Landscape Architecture & Master Planning Design Consulting

11525 W. North Avenue Suite 1B Wauwatosa, WI 53226 Tel (414) 476-1204 www.insitelandscape.com mdavis@insitelandscape.com

Project for:

WAUWATOSA VETERANS COMMITTEE

Wauwatosa, WI

<u>Project:</u>

## WAUWATOSA VETERANS MEMORIAL at HART PARK

Wauwatosa, WI 53226

Issuance and Revisions:

Date	Number	Description
06/05/23		Client Reviev Submittal
06/29/23		Parks Dept Prelim Meeti
07/17/23		Parks Dept Meeting
08/28/23		Client Review Submittal
09/20/23		Phase I Construction Document Submittal

09/09/25 Revisions based on Staff Review Comments / Design Review Board Re-Submittal

Design Review

**Board Submittal** 

COPYRIGHT InSite Landscape Design Inc. 2013 ALL RIGHTS RESERVED THIS DRAWING IS NOT TO BE REPRODUCED, CHANGED, COPIED OR ASSIGNED TO ANY THIRD PARTY IN ANY FORM OR MANNER WITHOUT FIRST OBTAINING THE EXPRESSED WRITTEN PERMISSION OF InSite Landscape Design Inc. THE CLIENT AGREES TO INDEMNIFY AND HOLD THE LANDSCAPE ARCHITECT HARMLESS FROM ANY DAMAGES, LIABILITY, OR COST, INCLUDING ATTORNEY'S FEES AND COSTS OF DEFENSE ARISING FROM ANY CHANGES OR ALTERATIONS MADE BY ANYONE OTHER THAN THE LANDSCAPE ARCHITECT, OR FROM ANY REUSE OF THE DRAWINGS OR DATA WITHOUT THE PRIOR WRITTEN CONSENT OF THE

LANDSCAPE ARCHITECT.


Sheet Title:

08/26/25

**ACCESIBILITY GUIDELINES** AND SITE DETAILS

Date of Drawing:	09/09/25
Scale:	As Noted
Drawn By:	MCD
Job Number:	L23-025

Sheet Number:

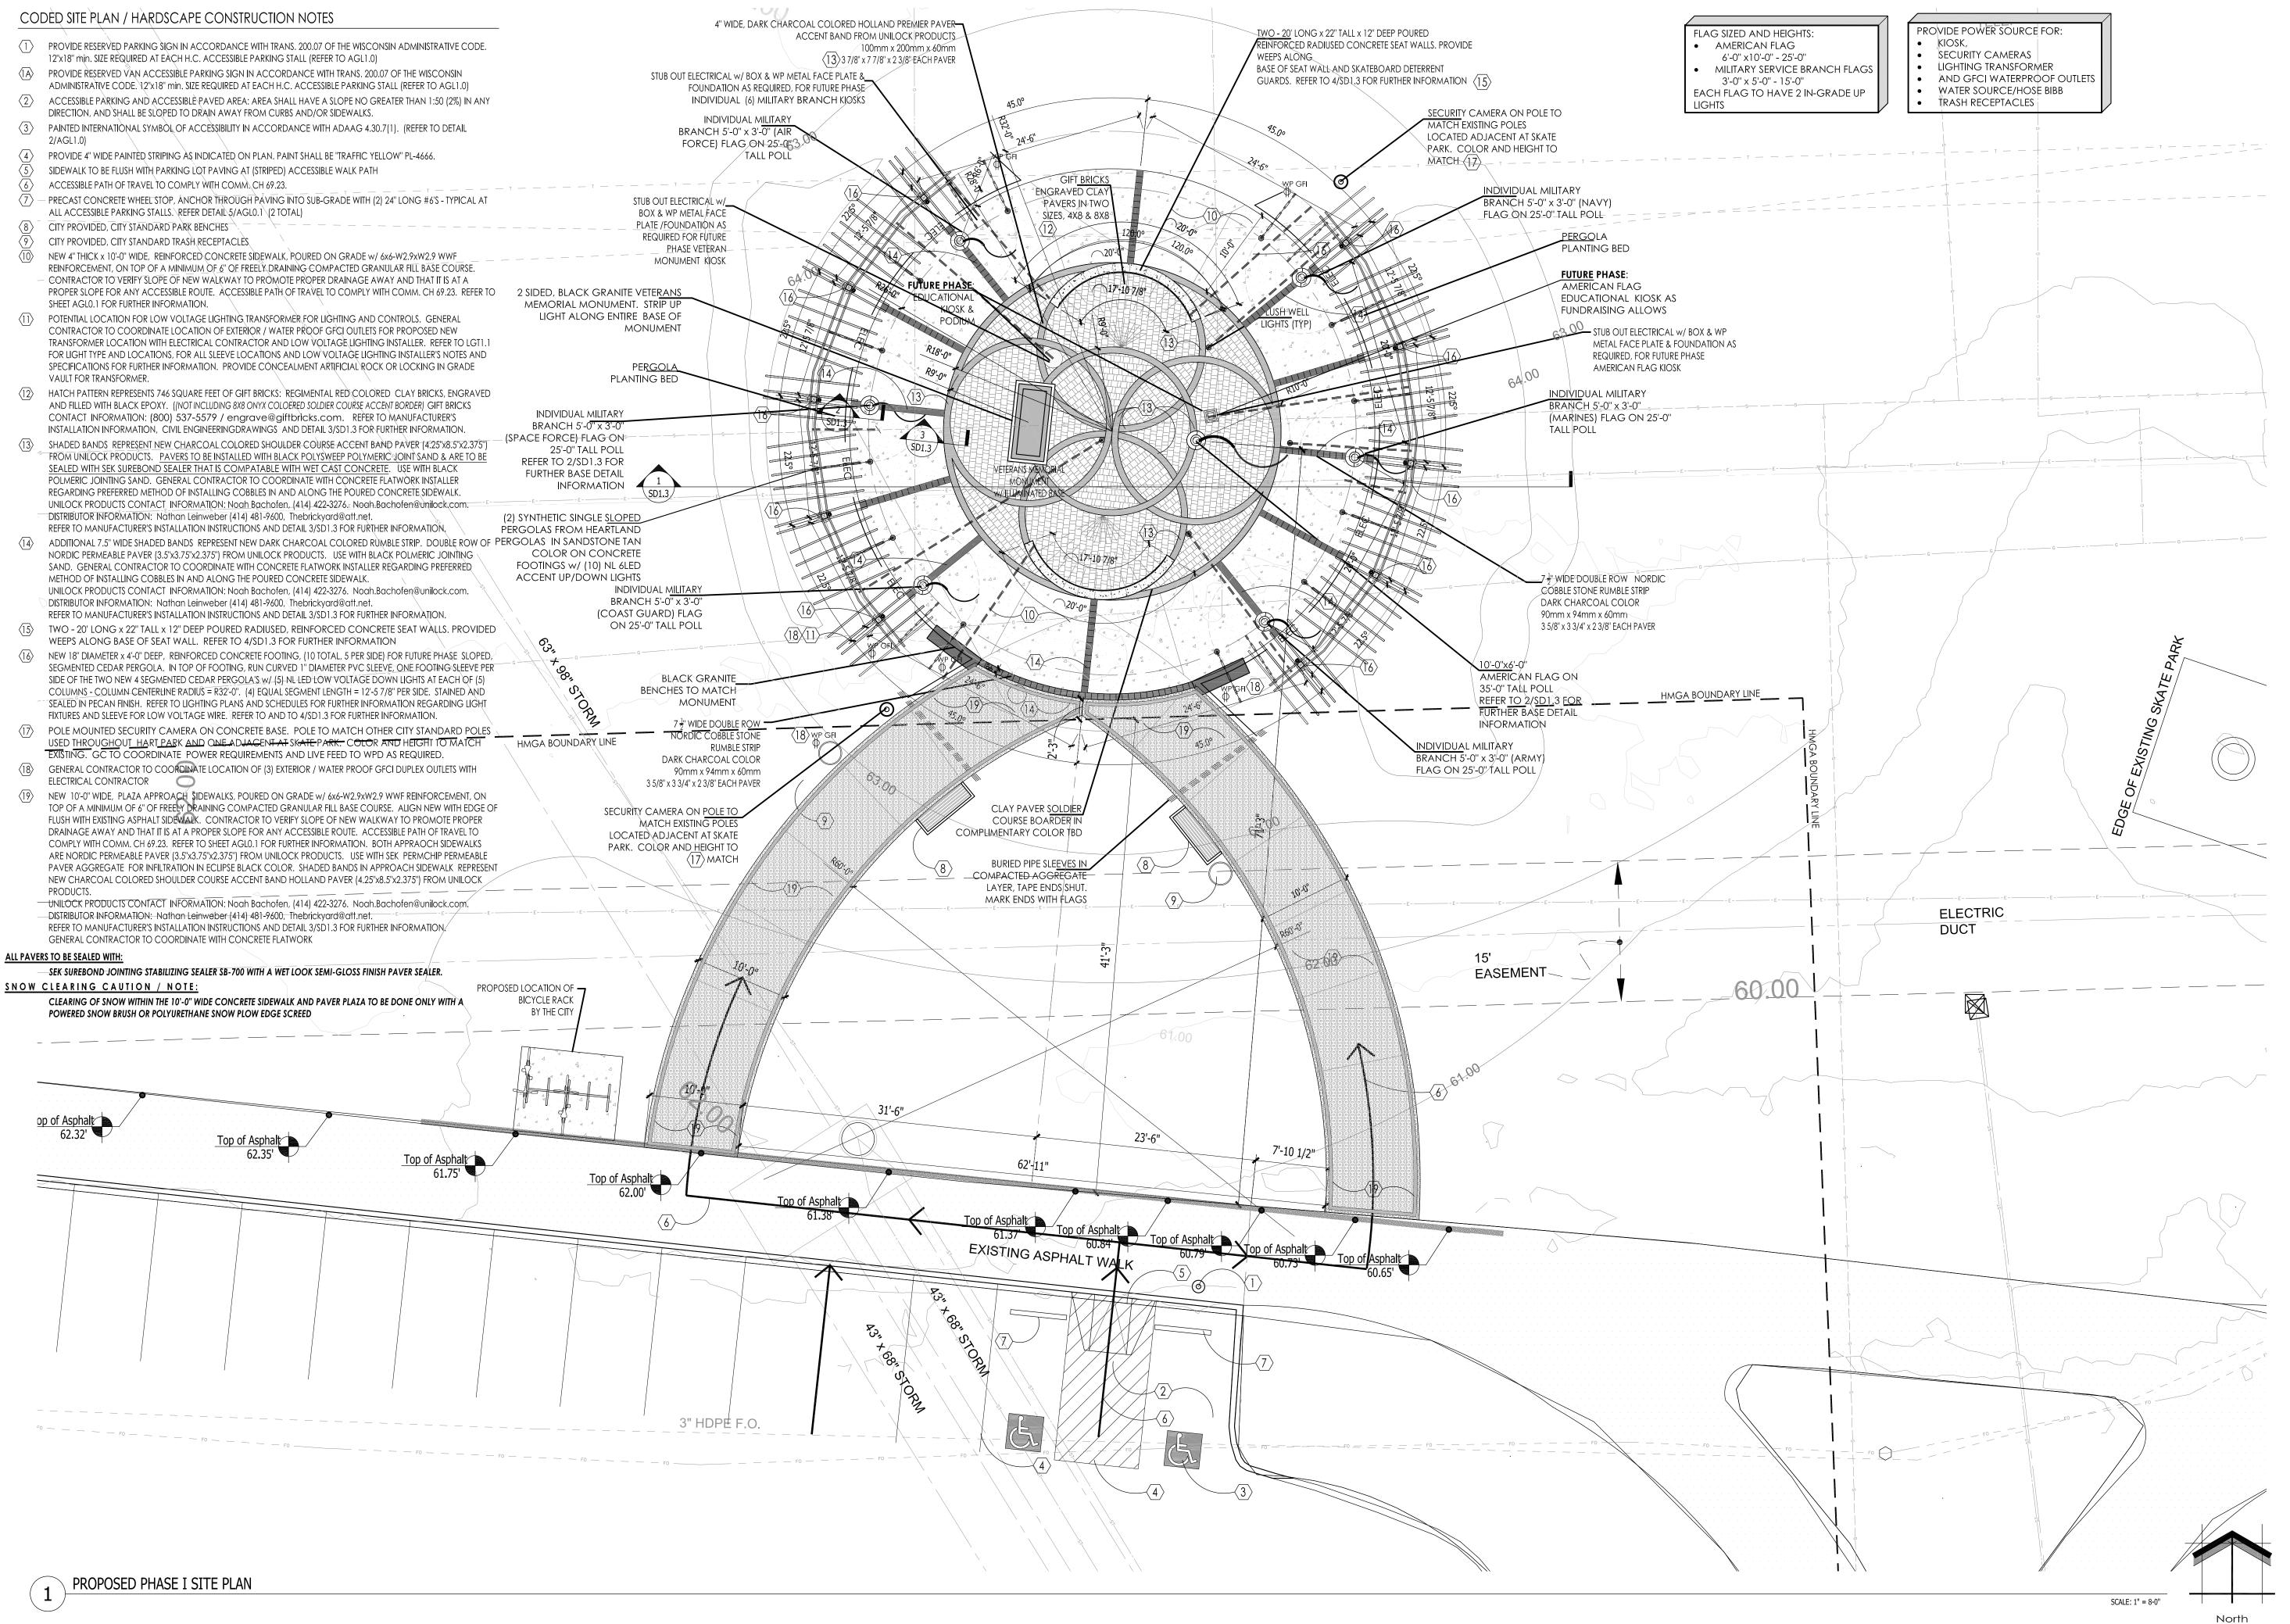

INS TE

Landscape Consulting & Master Planning Design Sevices

11525 W. North Avenue, Suite 1B Wauwatosa, WI 53226 Tel (414) 476-1204 www.insitedesigninc.com mdavis@insitedesigninc.com

Project for:

# WAUWATOSA VETERANS COMMITTEE

Wauwatosa, WI

roject:

# WAUWATOSA VETERANS MEMORIAL at HART PARK

72nd Street - Hart Park Wauwatosa, WI 53226

<u>Issuance and Revisions:</u>

Date	Number	Description
06/05/23		Client Review Submittal
06/29/23		Parks Dept Prelim Meeting
07/17/23		Parks Dept Meeting
08/28/23		Client Review Submittal
09/20/23		Phase I Construction Document Submittal
08/26/25		Design Review Board Submittal
09/09/25		Revisions based on Staff Review Comments / Design Review Board

COPYRIGHT InSite Landscape Design Inc. 2020
ALL RIGHTS RESERVED
THIS DRAWING IS NOT TO BE REPRODUCED,
CHANGED, COPIED OR ASSIGNED TO ANY THIRD
PARTY IN ANY FORM OR MANNER WITHOUT FIRST
OBTAINING THE EXPRESSED WRITTEN PERMISSION
OF InSite Landscape Design, Inc. THE CLIENT AGREES
TO INDEMNIFY AND HOLD THE Insite Landscape
Design Inc. HARMLESS FROM ANY DAMAGES,
LIABILITY, OR COST, INCLUDING ATTORNEYS FEES
AND COSTS OF DEFENSE ARISING FROM ANY
CHANGES OR ALTERATIONS MADE BY ANYONE
OTHER THAN THE InSite Landscape Design Inc., OR
FROM ANY REUSE OF THE DRAWINGS OR DATA
WITHOUT THE PRIOR WRITTEN CONSENT OF THE

Re-Submittal


Sheet Title:

PROPOSED LANDSCAPE PLAN, GENERAL NOTES, AND PLANT MATERIAL TABLE

InSite Landscape Design Inc.

Date of Drawing:	09/09/25
Scale:	1" = 8'-0"
Drawn By:	MCD
Job Number:	L23-025
Sheet Number:	

SD1.1

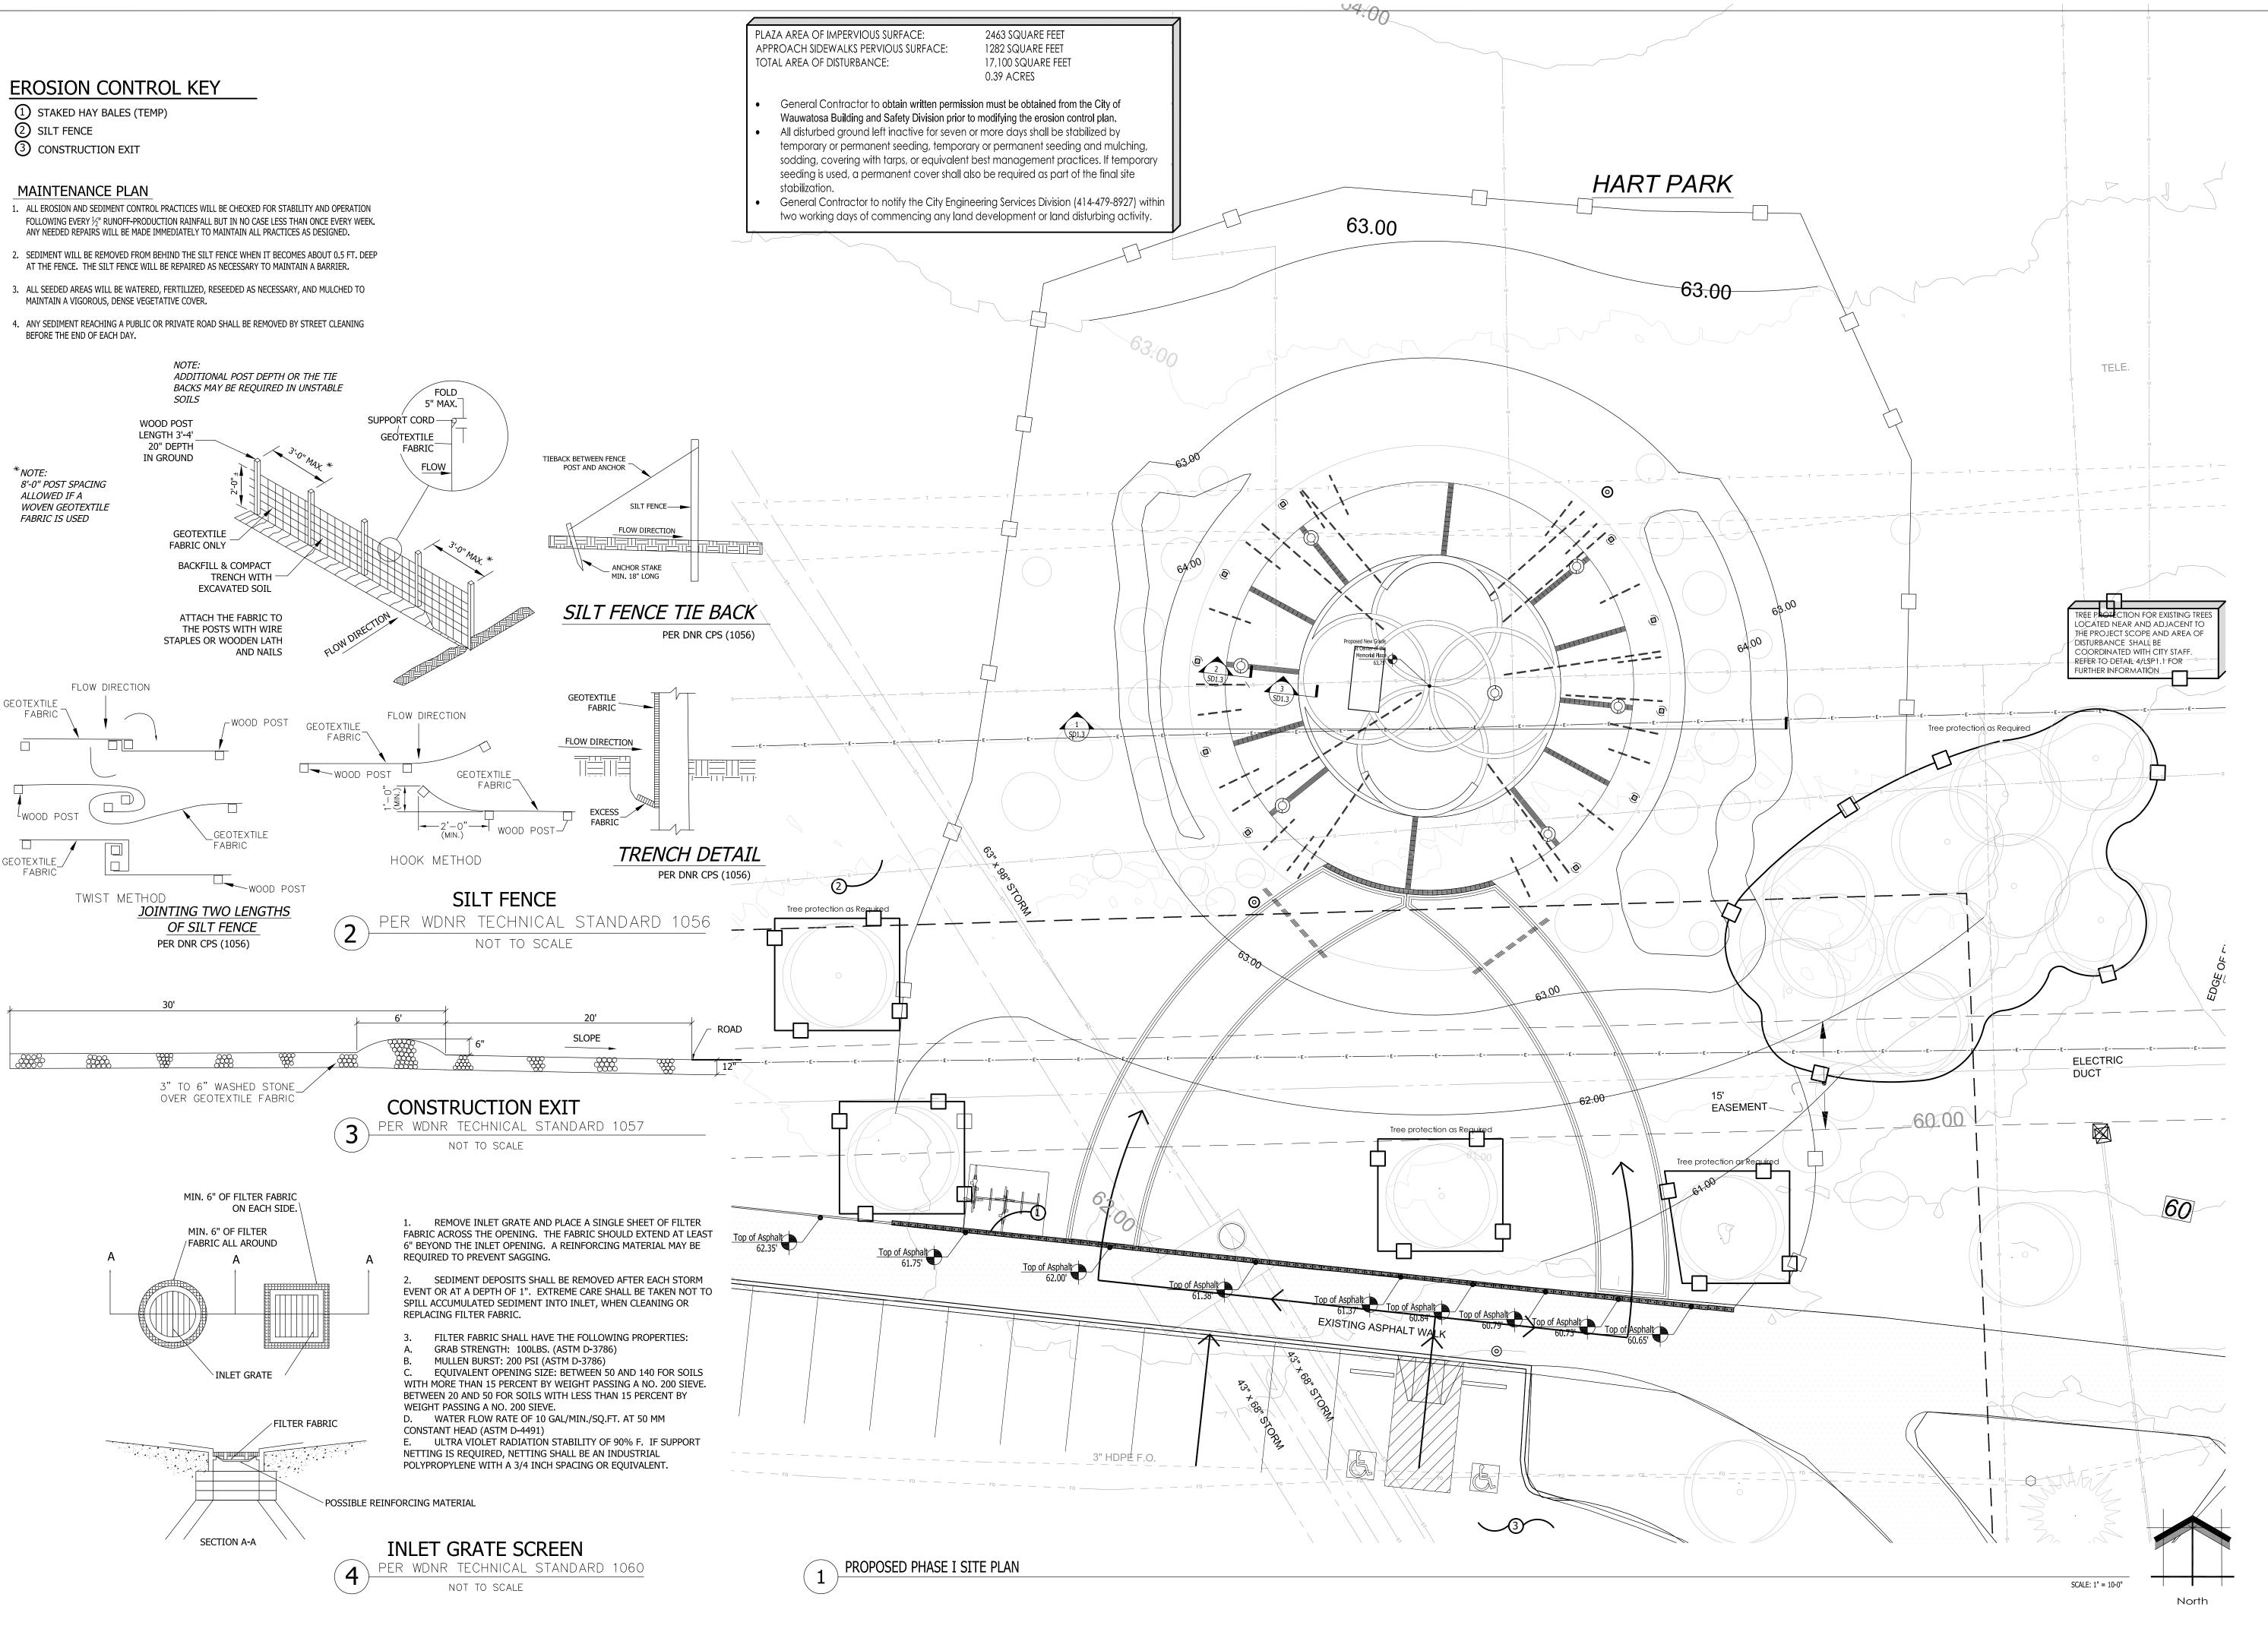

INS TE

Landscape Consulting & Master Planning Design Sevices

11525 W. North Avenue, Suite 1B Wauwatosa, WI 53226 Tel (414) 476-1204 www.insitedesigninc.com mdavis@insitedesigninc.com

Project for:

# WAUWATOSA VETERANS COMMITTEE

Wauwatosa, WI

Proiect:

# WAUWATOSA VETERANS MEMORIAL at HART PARK

72nd Street - Hart Park Wauwatosa, WI 53226

<u>Issuance and Revisions:</u>		
Date	Number	Description
06/05/23		Client Review Submittal
06/29/23		Parks Dept Prelim Meeting
07/17/23		Parks Dept Meeting
08/28/23		Client Review Submittal
09/20/23		Phase I Construction Document Submittal
08/26/25		Design Review Board Submittal
09/09/25		Revisions based on Staff Review Comments / Design Review Board Re-Submittal

COPYRIGHT InSite Landscape Design Inc. 2020
ALL RIGHTS RESERVED
THIS DRAWING IS NOT TO BE REPRODUCED,
CHANGED, COPIED OR ASSIGNED TO ANY THIRD
PARTY IN ANY FORM OR MANNER WITHOUT FIRST
OBTAINING THE EXPRESSED WRITTEN PERMISSION
OF InSite Landscape Design, Inc. THE CLIENT AGREES
TO INDEMNIFY AND HOLD THE InSite Landscape
Design Inc. HARMLESS FROM ANY DAMAGES,
LIABILITY, OR COST, INCLUDING ATTORNEY'S FEES
AND COSTS OF DEFENSE ARISING FROM ANY
CHANGES OR ALTERATIONS MADE BY ANYONE
OTHER THAN THE InSite Landscape Design Inc., OR
FROM ANY REUSE OF THE DRAWINGS OR DATA
WITHOUT THE PRIOR WRITTEN CONSENT OF THE
InSite Landscape Design Inc.

Sheet Title:

PROPOSED PHASE I GRADING PLAN, EROSION CONTROL INFORMATION

Date of Drawing:	09/09/25
Scale:	1" = 10'-0"
Drawn By:	MCD
Job Number:	L23-025
Sheet Number:	

SD1.2

LANDSCAPE **Y** DESIGN

Landscape Consulting
& Master Planning Design Sevices

11525 W. North Avenue, Suite 1B Wauwatosa, WI 53226 Tel (414) 476-1204 www.insitedesigninc.com mdavis@insitedesigninc.com

Project for:

#### WAUWATOSA VETERANS COMMITTEE

Wauwatosa, WI

<u>Project:</u>

## WAUWATOSA VETERANS MEMORIAL at HART PARK

72nd Street - Hart Park Wauwatosa, WI 53226

Issuance and Revisions: Number Description Date

06/05/23 Client Review Submittal 06/29/23 Parks Dept Prelim Meeting 07/17/23 Parks Dept 08/28/23 Client Review

Submittal 09/20/23 Phase I Construction Document

08/26/25 09/09/25

Revisions based on Staff Review Comments / Design Review Board Re-Submittal

Submittal

Design Review

Board Submittal

COPYRIGHT InSite Landscape Design Inc. 2020 ALL RIGHTS RESERVED THIS DRAWING IS NOT TO BE REPRODUCED, CHANGED, COPIED OR ASSIGNED TO ANY THIRD PARTY IN ANY FORM OR MANNER WITHOUT FIRST OBTAINING THE EXPRESSED WRITTEN PERMISSION OF InSite Landscape Design, Inc. THE CLIENT AGREES TO INDEMNIFY AND HOLD THE InSite Landscape Design Inc. HARMLESS FROM ANY DAMAGES, LIABILITY, OR COST, INCLUDING ATTORNEY'S FEES AND COSTS OF DEFENSE ARISING FROM ANY CHANGES OR ALTERATIONS MADE BY ANYONE OTHER THAN THE InSite Landscape Design Inc., OR FROM ANY REUSE OF THE DRAWINGS OR DATA

InSite Landscape Design Inc.

**Sheet Title:** 

SECTION AND DETAILS GENERAL NOTES,

ate of Drawing:	09/09/25
cale:	1" = 8'-0"
rawn By:	MCD
ob Number:	L23-025

72nd Street - Hart Park Wauwatosa, WI 53226

Issuance and Revisions: Number Description 06/05/23 Client Review Submittal

06/29/23 Parks Dept Prelim Meeting 07/17/23 Parks Dept 08/28/23 Client Review Submittal 09/20/23 Phase I Construction Document

ALL RIGHTS RESERVED

InSite Landscape Design Inc.

SITE MATERIALS / COMPONENTS

08/26/25

09/09/25

Sheet Title:

PROPOSED PAHSE I

Date of Drawing:

Drawn By:

Job Number:

Submittal

Staff Review

Review Board

Re-Submittal

**TECHNICAL DATA SHEET** 

ASTM C144 Fractured & Angular Different Size Particles Ideal for Segmental Systems

**Superior Strength Polymeric Sand** 

Regular & X-Treme Wide Joint

Gift Bricks® Engraved Clay Brick Colors

Clay pavers offer durability and versatility. They can be: engraved only, engraved with epoxy fill, engraved with paint infill, or engraved with laserblasting. Our most popular product is available in colors shown. These engraved

Admiral

Sizes: 4x8 and 8x8

GIFT BRICKS 4"x8" OR 8"x8" REGIMENTAL RED WITH BLACK EPOXY FILL

clay bricks come in sizes 4 x 8 and 8 x 8. Engraving text can be 14 or 20 characters per line.

Home > Products > Engraved Bricks > Clay Brick > Colors

Gift Bricks® Engraved Clay Brick Colors

Call for a FREE Sample Kit

Toll-Free: 1-800-537-5579

POLYSWEEP ESTIMATED COVERAGE PER 50 LB. BAG:

JOINT SIZE	AREA IN SQ FT	
Up to 1/4"	50 - 75	
1/4" - 1/2"	25 - 50	
1/2" - 3/4"	15 - 25	

Joint Stabilization

**IMPORTANCE OF ASTM C144 SAND:** 

different sizes. This type of sand will create the

water and the curing process is complete.

PolySweep is a blend of polymer binders and native sands

that conform to the ASTM C-144 standard. ASTM C-144 is

a specific gradation of fractured angular sand particles of

necessary structure in the joint that will interlock the


system together once the polymers are activated with


Coverage will vary depending on shape, size & depth of pavers installed. Use in joints up to 3/4".

#### X-TREME WIDE JOINT ESTIMATED COVERAGE PER 50 LB. BAG:

PAVER TYPE	JOINT SIZE	AREA IN SQ FT
Standard	Up to 1/4"	50 - 75
Standard	1/4" - 1/2"	25 - 50
Standard	1/4" - 1/2"	15 - 25
Natural Stone	Up to 2"	15 - 25
Natural Stone	2" - 4"	25 - 35

Coverage will vary depending on shape, size & depth of pavers installed. Use in joints up to 4".

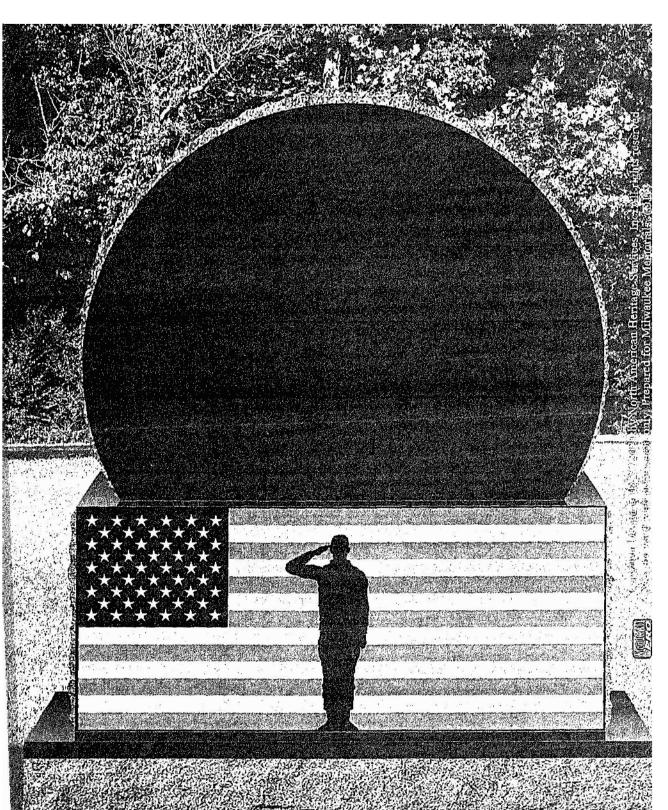

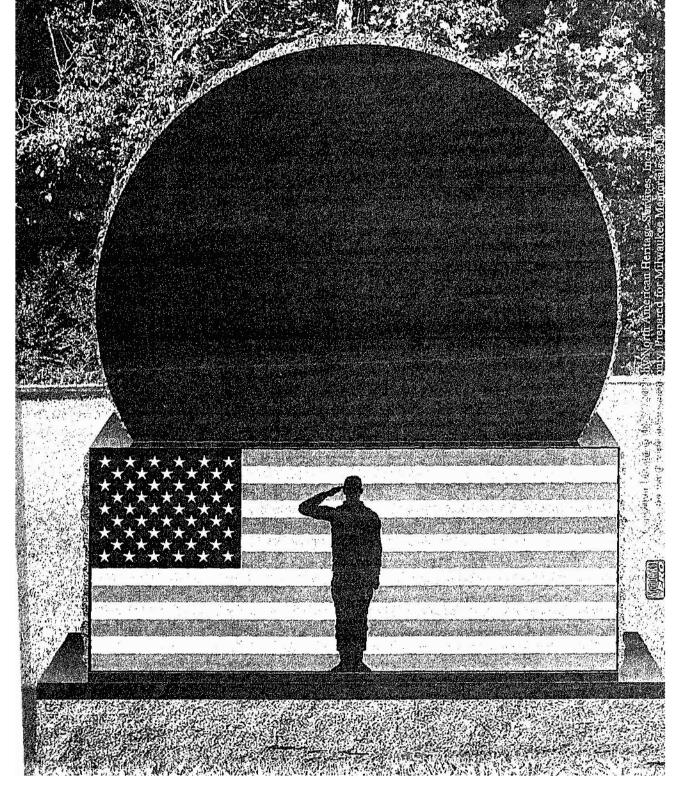



MEMORIAL PLAZA MONUMENT FRONT

UNILOCK

PRODUCT SELECTION

PRODUCT LINE: HOLLANDSTONE™

3 7/8 X 7 7/8 X 2 3/8" (100 X 200 X 60MM)

**Light Duty Vehicular** 

PRODUCT INFORMATION (CONT'D)

98% Standard Proctor Density (SPD).

SPECIAL NOTE:

HOLLANDSTONE™

05/09/25 15:50:39

UNILOCK.COM | 1-800-UNILOCK

PRODUCT INFORMATION

3 7/8x7 7/8" (100x200mm)

standard finish. Available in one size, this paver can be laid in various patterns.

Hollandstone by incorporating Unigranite® or Series™ banding and insets.


Alternative Permeable Bedding Course – 1" thick of 1/4" clear open-graded chip stone – (ASTM No. 8) screeded over base. Special Note: Concrete Direct Overlay – In some areas of the country and in some applications pavers are very successfully

placed directly over concrete. Concrete as a base is in itself quite strong, but it can affect the structural integrity of the paver

particularly in vehicular applications, where the concrete below is sub-par. The following considerations must be taken into

IN HONOR AND MEMORY OF ALL THE MEN AND WOMEN WHO SERVED IN THE ARMED FORCES OF THE UNITED STATES OF AMERICA TO PRESERVE OUR FREEDOM

MEMORIAL PLAZA MONUMENT BACK

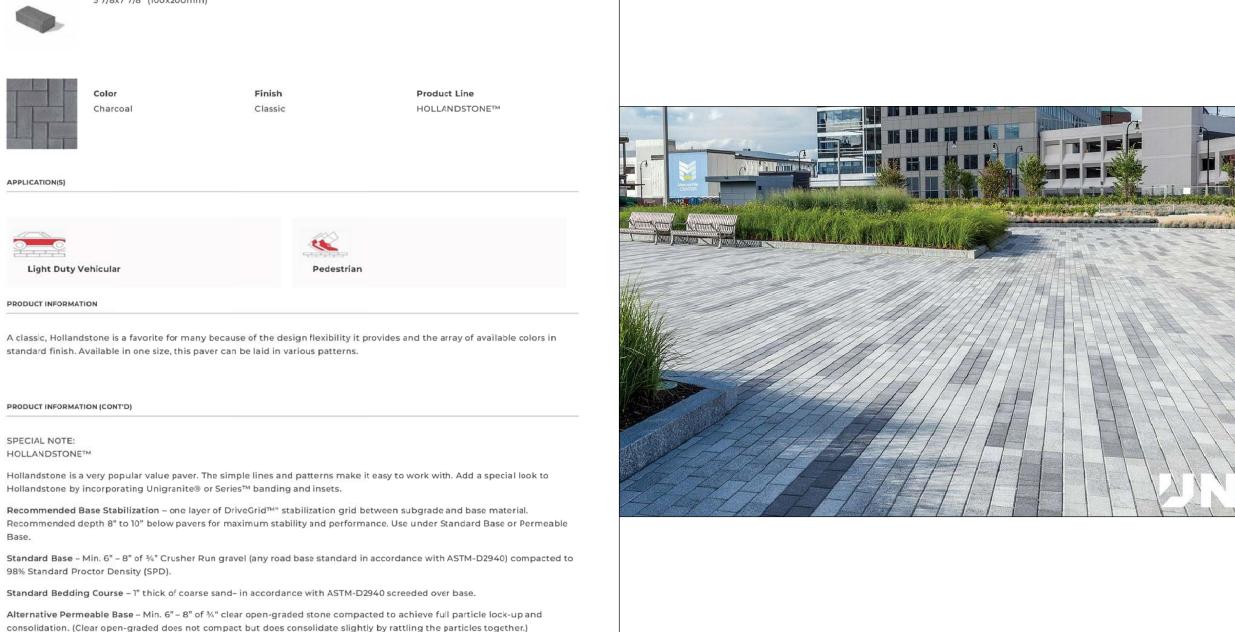

# \ FLAG POLE

#### **Superior Strength Polymeric Sand** Regular & X-Treme Wide Joint

TECHNICAL DATA SHEET Joint Stabilization

M-Winch System

Hardwood Wedges

Foundation

Steel Base

Sleeve

Plate

PRODUCT DESCRIPTION:

Cast Aluminum Revolving Truck

Cable Asembly -

Deluxe Flag Arrangement

Counterweight —

Beaded

Collar

3000 PSI Concrete

Retainer Ring

Aluminum Flash

Dry Tamped

Steel Centering

Support Plate

Lightning Ground Spike

Regular & X-Treme Wide Joint PolySweep Polymeric Sand (referred to as PolySweep unless otherwise noted) are designed to keep sand in the joints by creating a semi-solid joint. PolySweep is a blend of native sands conforming to the ASTM C-144 standard, and polymer binders that once activated allow the joints to expand and contract with the elements such as extreme heat/cold and freeze/thaw cycles. Hardened sand joints will help to prevent sand erosion by rain and other water run-off, lessen weed growth, deter insect infestation and reduce overall pavement maintenance. Specially formulated with Clear Set Technology® which uses the

highest quality, clearest synthetic polymers, PolySweep will not discolor the surface or leave behind a haze.

FEATURES	BENEFITS		
Clear Set Technology	Haze Free Performance		
Superior Strength, Long Lasting Durability	<ul> <li>Long Term Semi-Solid Joint</li> <li>Resists Cracking</li> <li>Lessens Weed Growth and Deters Insects</li> </ul>		
Stronger Set Up	Tested & proven to have superior cohesion & adhesion performance on initial set up and after full cure		
RCS Safe	RCS (Respirable Crystalline Silica) level is below reportable limits under normal use as demonstrated by certified lab testing		

#### **SUITABLE APPLICATIONS:**

- New or Existing Residential and Commercial Projects: Driveways, Walkways, Patios, Pool Decks and
- Substrates: Concrete, Clay & Wet Cast Pavers, Natural Stone and Porcelain Tile
- Do not use on vertical applications or as a substitute for mortar

#### **AVAILABLE COLORS:**

ALLABLE COLORS.	
PEARL TAN GRAY TIELDSTONE PLATINUM	BLACK

Pearl is not available in X-Treme Wide Joint. Color availability may vary by region. Color may vary due to the nature of aggregates and moisture content. This image is a representation of the available colors and a sample can be requested if needed.

PLAZA PAVER POLYSWEEP POLYMERIC JOINTING SAND - BLACK COLOR

7 1/2" WIDE DOUBLE ROW OF UNILOCK NORDIC COBBLE DARK CHARCOAL COLOR

Sheet Number:

Design Review Board Submittal Revisions based on Comments / Design COPYRIGHT InSite Landscape Design Inc. 2020 THIS DRAWING IS NOT TO BE REPRODUCED, CHANGED, COPIED OR ASSIGNED TO ANY THIRD PARTY IN ANY FORM OR MANNER WITHOUT FIRST OBTAINING THE EXPRESSED WRITTEN PERMISSION OF InSite Landscape Design, Inc. THE CLIENT AGREES TO INDEMNIFY AND HOLD THE InSite Landscape Design Inc. HARMLESS FROM ANY DAMAGES, LIABILITY, OR COST, INCLUDING ATTORNEY'S FEES AND COSTS OF DEFENSE ARISING FROM ANY CHANGES OR ALTERATIONS MADE BY ANYONE OTHER THAN THE InSite Landscape Design Inc., OR FROM ANY REUSE OF THE DRAWINGS OR DATA WITHOUT THE PRIOR WRITTEN CONSENT OF THE

09/09/25

NONE

L23-025

MCD

PiabC

Quantity	Code Name	Symbol	Scientific Name	Common Name	Planting Size	Comments
2	AcmiRR	<b>(</b>	Acer miyabei "JFS-KW3AMI"	Rugged Ridge Maple	2 1/2" Cal - B&B	1
2	Acgr		Acer griseum	Paperbark maple	2 1/2" Cal - B&B	1
2	GibiPS	0	Ginko biloba 'Princeton Sentry'	Princeton Sentry Maidenhair Tree	2 1/2" Cal - B&B	1, 6
4	MaAk	<b>X</b>	Malus "Adirondack"	Adirondack Flowering Crab	1 1/2" Cal - B&B	1
14	Extg	$\odot$	Existing to Remain	Existing to Remain	Existing	2
Conifer Ever	green Tree					
Quantity	Code Name	Symbol	Scientific Name	Common Name	Planting Size	Comments

Columnar Norway Spruce

Moonglow Juniper

7' - B&B

7' - B&B

Picea abies 'Cupressina'

| Juniperus scopulorum 'Moonglow'

Quantity	Code Name	Symbol	Scientific Name	Common Name	Planting Size	Comments
48	DegrM		Deutzia gracilis 'Mincream'	Creme Fraiche Deutzia	15" - 18" - Cont	4
15	HymaB	£35	Hydrangea macrophylla 'Bailmer'	Endless Summer Hydrangea	18" - 24"- Cont	4
3	PhopC	623	Physocarpus opulifolius 'Mindia'	Coppertina Ninebark	24" - 30" - B&B	4
				• •		
erennial Gr	ass	46				
erennial Gr Quantity	Code Name	Symbol	Scientific Name	Common Name	Planting Size	Comments
			Scientific Name Panicum virgatum 'Hot Rod'	Common Name  Hot Rod Switch Grass	Planting Size 1-Gal - Cont	Comment 5

Male only

Straight central leader, full & even crown. Prune only after planting. 2. Prune existing tree, remove any dead, diseased or hazardous limbs. Thin out as required and raise canopy for safety and viability for both pedestrians and motorists. Provide tree

	protection as shown in detail 4/LSP1.2 and coordinate protection with City Staff.
3.	Evenly shaped upright tree with full branching to the ground.
4.	Full, well rooted plant, evenly shaped.
5.	Full, well rooted plant.

LANDSCAPE / SITE DEMOLITION CONTRACTOR TO VERIFY LOCATIONS OF EXISTING TREES TO BE SALVAGED AND CLEARLY TAG THEM WITH MARKING TAPE AND CONSTRUCTION FENCE.

LANDSCAPE INSTALLATION CONTRACTOR TO COORDINATE INSTALLATION OF NEW PLANT MATERIAL AND THE COORDINATION WITH EXISTING TREES TO BE SALVAGED.

- MULCH BED AREA. DRESS WITH 2"-3" OF SHREDDED HARDWOOD BARK MULCH. TAKE CARE WITH INSTALLATION NOT TO DAMAGE OR COVER PLANTS. REFER TO GENERAL NOTES AND SPECIFICATIONS FOR FURTHER
- (2) EARTHEN BED EDGE (SHOVEL POINT) LANDSCAPE EDGE. TYPICAL ALL PLANT MATERIAL AREAS. DRESS WITH 2"-3" OF SHREDDED HARDWOOD BARK MULCH. REFER TO GENERAL NOTES AND SPECIFICATIONS FOR FURTHER
- (3) MULCHED 4'-0" DIA. TREE RING BED AREA W/ EARTHEN BED EDGE (SHOVEL POINT) LANDSCAPE EDGE AS REQUIRED. DRESS WITH 2"-3" OF SHREDDED HARDWOOD BARK MULCH. REFER TO LSP1.2, GENERAL NOTES AND SPECIFICATIONS FOR FURTHER INFORMATION.
- $\overline{\langle 4 \rangle}$  SEEDED AREAS OF TURF GRASS. REPAIR ANY AND ALL TURF DAMAGE FROM THE CONSTRUCTION PROCESS. IT IS VERY IMPORTANT TO FOLLOW THE MANUFACTURERS INSTALLATION INSTRUCTIONS REGARDING THE TURF GRASS FOR PROPER GERMINATION AND SURVIVABILITY OF THE SEED MIX. ALSO REFER TO GENERAL NOTES FOR PREPARATION OF TOP SOIL AND SEED INSTALLATION. REFER TO GRADING PLAN FOR FURTHER INFORMATION. ALSO REFER TO GENERAL NOTES AND SPECIFICATIONS FOR FURTHER INFORMATION.

Landscape Consulting
& Master Planning Design Sevices

11525 W. North Avenue, Suite 1B Wauwatosa, WI 53226 Tel (414) 476-1204 www.insitedesigninc.com mdavis@insitedesigninc.com

Project for:

#### WAUWATOSA VETERANS COMMITTEE

Wauwatosa, WI

<u>Project:</u>

## WAUWATOSA VETERANS MEMORIAL at HART PARK

72nd Street - Hart Park Wauwatosa, WI 53226

Issuance and Revisions:

Date	Number	Description
06/05/23		Client Review Submittal
06/29/23		Parks Dept Prelim Meeting
07/17/23		Parks Dept Meeting
08/28/23		Client Review Submittal
09/20/23		Phase I Construction Document Submittal
08/26/25		Design Review Board Submittal
09/09/25		Revisions based on Staff Review

COPYRIGHT InSite Landscape Design Inc. 2020 ALL RIGHTS RESERVED THIS DRAWING IS NOT TO BE REPRODUCED, CHANGED, COPIED OR ASSIGNED TO ANY THIRD PARTY IN ANY FORM OR MANNER WITHOUT FIRST OBTAINING THE EXPRESSED WRITTEN PERMISSION OF InSite Landscape Design, Inc. THE CLIENT AGREES TO INDEMNIFY AND HOLD THE InSite Landscape Design Inc. HARMLESS FROM ANY DAMAGES, LIABILITY, OR COST, INCLUDING ATTORNEY'S FEES AND COSTS OF DEFENSE ARISING FROM ANY CHANGES OR ALTERATIONS MADE BY ANYONE OTHER THAN THE InSite Landscape Design Inc., OR FROM ANY REUSE OF THE DRAWINGS OR DATA WITHOUT THE PRIOR WRITTEN CONSENT OF THE


InSite Landscape Design Inc.

Comments / Design Review Board Re-Submittal

<u>Sheet Title</u>:

PROPOSED PHASE I LANDSCAPE PLAN, AND PLANT MATERIAL TABLE

Date of Drawing:	09/09/25
Scale:	1" = 20'-0"
Drawn By:	MCD
Job Number:	L23-025
Sheet Number:	

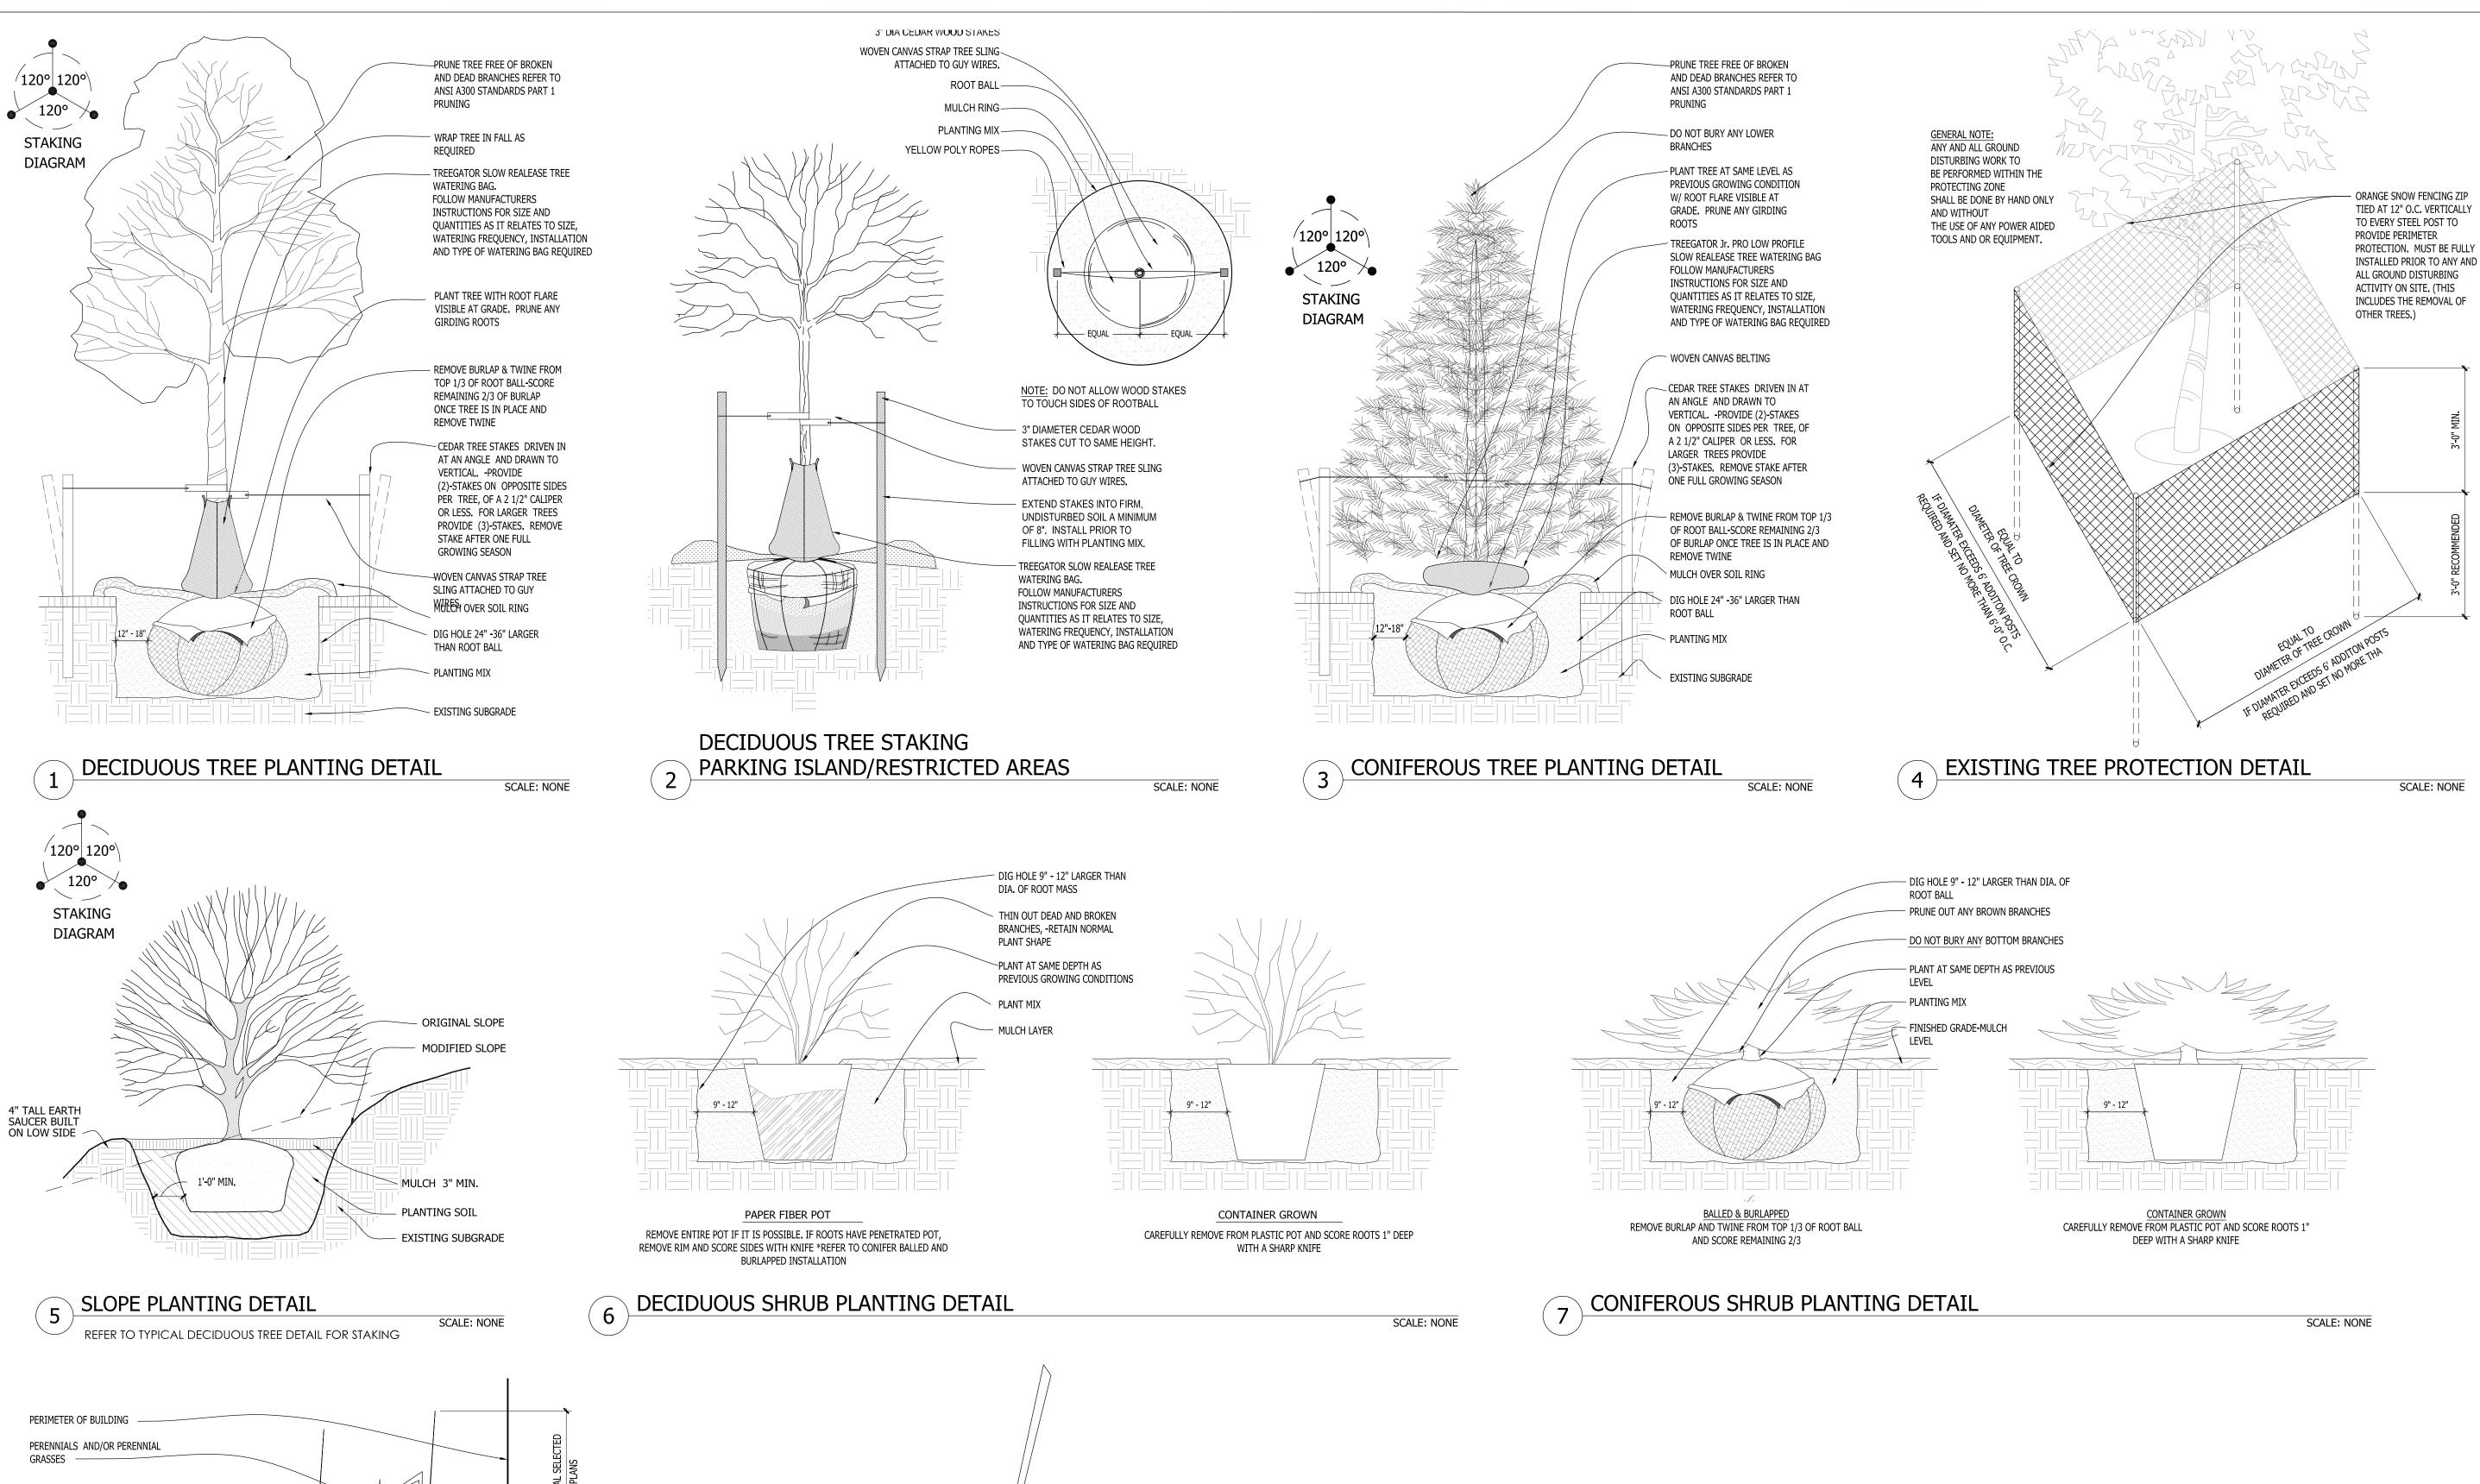

LANDSCAPE

**Landscape Consulting** & Master Planning Design Sevices

11525 W. North Avenue, Suite 1B Wauwatosa, WI 53226 Tel (414) 476-1204 www.insitedesigninc.com mdavis@insitedesigninc.com

Project for:

#### WAUWATOSA VETERANS COMMITTEE

Wauwatosa, WI

<u>Project:</u>

## WAUWATOSA VETERANS MEMORIAL at HART PARK

72nd Street - Hart Park Wauwatosa, WI 53226

<u>Issuance c</u>	Issuance and Revisions:				
Date	Number	Description			
06/05/23		Client Review Submittal			
06/29/23		Parks Dept Prelim Meeting			
07/17/23		Parks Dept Meeting			
08/28/23		Client Review Submittal			
09/20/23		Phase I Construction Document Submittal			
08/26/25		Design Review Board Submittal			
09/09/25		Revisions based on Staff Review Comments / Design Review Board			


COPYRIGHT InSite Landscape Design Inc. 2020 ALL RIGHTS RESERVED THIS DRAWING IS NOT TO BE REPRODUCED, CHANGED, COPIED OR ASSIGNED TO ANY THIRD PARTY IN ANY FORM OR MANNER WITHOUT FIRST OBTAINING THE EXPRESSED WRITTEN PERMISSION OF InSite Landscape Design, Inc. THE CLIENT AGREES TO INDEMNIFY AND HOLD THE InSite Landscape Design Inc. HARMLESS FROM ANY DAMAGES, LIABILITY, OR COST, INCLUDING ATTORNEY'S FEES AND COSTS OF DEFENSE ARISING FROM ANY CHANGES OR ALTERATIONS MADE BY ANYONE OTHER THAN THE InSite Landscape Design Inc., OR FROM ANY REUSE OF THE DRAWINGS OR DATA WITHOUT THE PRIOR WRITTEN CONSENT OF THE InSite Landscape Design Inc.

Re-Submittal


Sheet Title:

PROPOSED LANDSCAPE PLAN, PLANTING DETAILS

Date of Drawing:	09/09/25
Scale:	As Noted
Drawn By:	MCD
Job Number:	L23-025
Sheet Number:	

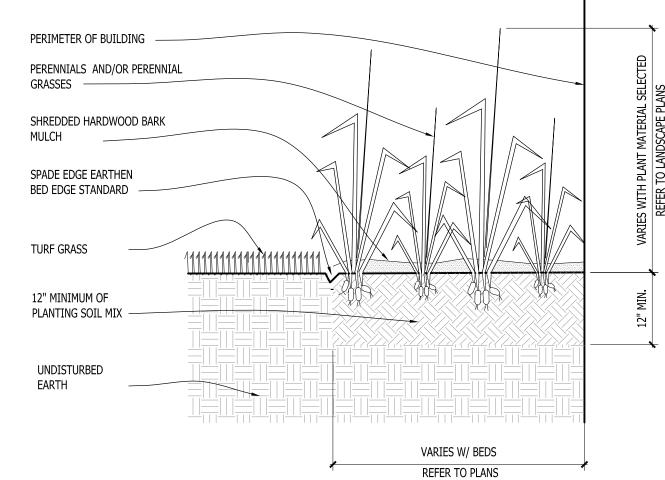

PERENNIAL BED PLANTING DETAIL

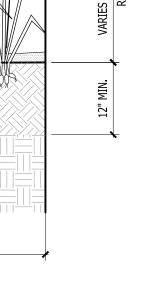

SCALE: NONE

SPADE EDGE PLANT BED EDGE DETAIL

TOP OF MULCH SHOULD BE -CRESTED 1-2" ABOVE TURF FOR POSITIBE DRAINGE. SLOPE

GRADUALLY.

3" (+/-) MULCH BED -

SCALE: NONE

BEDLINES ARE TO BE CUT CRISP

AS PER PLAN. A CLEAN DEFINITION BETWEEN TURF AND PLANTING BED IS REQUIRED.

- TOPSOIL / PLANTING MIX

Quantity	uantity Code Name Symbol Description		Description
1	Transformer	<b></b>	FX-LUMINARE LUXOR ZDC 300 WITH COLOR WATT TRANSFORMER W/ STAINLESS STEEL FINISH FINISH. LUXOR WI-FI MODULE P/N FXWIFIMOD. REFER TO CUT SHEETS FOR FURTHER INFORMATION AND INSTALLATION INSTRUCTIONS, LOCATIONS TO BE DETERMINED
16	XN-70 XN-ZD-H1-W-WF-RG-BZ	•	FX-LUMINARE XN-70 GRANDE IN GRADE UP LIGHT W/LUXOR TECHNOLOGY HI WIDE FLOOD LAMP &BRONZE METALLIC FINISH. REFER TO CUT SHEETS FOR FURTHER INFORMATION AND INSTALLATION INSTRUCTIONS.
10	NL NL-ZDC-UD-BZ	•	FX-LUMINARE NL ZDC UP/DOWN LIGHT W/ LUXOR TECHNOLOGY & BRONZE METALLIC FINISH (5) PER PERGOLOA. REFER TO CUT SHEETS FOR FURTHER INFORMATION & INSTALLATION INSTRUCTIONS.
2	SRP-20-RGBW		FX-LUMINARE SRP-20-RGBW STRIP LIGHT W/ LUXOR TECHNOLOGY, 20'-0" LONG, SRP-CHN CHANNEL MOUNT AND SRP-CC COLOR CONTROLLER. TRIM 2'-6" OFF OF END OF STRIP LIGHT SO THAT CHANNEL IS SHORT 3" AT EACH END OF INSIDE FACE OF SEAT WALL. VERIFY SIZE OF CHANNEL MOUNT PRIOR TO FORMING AND POURING SEAT WALL. REFER TO CUT SHEETS FOR FURTHER INFORMATION AND INSTALLATION INSTRUCTIONS.
	Pipe Sleeve and Cable	====	Approximate locations for pipe sleeve and cabling

1. AT LEAST SEVENTY-TWO HOURS PRIOR TO ANY EXCAVATION, CONTRACTOR SHALL VERIFY UTILITY LOCATIONS AS GIVEN BY THE ELECTRIC, GAS, TELEPHONE, WATER, SEWER, AND CABLE TELEVISION COMPANIES, UTILITIES OR ENTITIES. REVIEW WITH OWNER'S REPRESENTATIVE SITE MECHANICAL, SITE ELECTRICAL AND LIGHTING, SITE GRADING AND DRAINAGE, SITE IRRIGATION AND ALL OTHER DRAWINGS PERTAINING TO UNDERGROUND UTILITY LOCATIONS. RECORD SET OF INFORMATION THE SAME AS IN POSSESSION OF OWNER'S REPRESENTATIVE. ALSO REVIEW OWNER'S "MARK SETS" OF ALL OF THESE DRAWINGS IN POSSESSION OF THE CONTRACTOR OR OWNER. MARK ALL SUCH UTILITIES ON THE SITE PRIOR TO COMMENCING. COORDINATE WITH OWNER BEFORE AND DURING CONSTRUCTION.

- REPAIR ANY DAMAGE TO ANY SYSTEM THAT IS CAUSED BY LIGHTING INSTALLER AT NO COST TO OWNER. 2. DEVIATIONS FROM THE APPROVED THE WAUWATOSA VETERANS MEMORIAL PLAZA PROJECT PLANS SHALL BE NOTED ON THE RECORD DRAWING BY THE LIGHTING INSTALLER /CONTRACTOR AND ONLY WITH PRIOR APPROVAL OF THE LANDSCAPE ARCHITECT AND OWNER'S REPRESENTATIVE. VERBAL AGREEMENTS OR REVISIONS WITHOUT A CHANGE ORDER WILL NOT BE RECOGNIZED BY LANDSCAPE ARCHITECT AND OWNER.
- 3. GENERAL CONTRACTOR TO COORDINATE POWER SOURCE FOR OUTLETS, SECURITY CAMERAS AND KIOSKS WITH CITY STAFF AND SUBCONTRACTORS.
- 4. LOW VOLTAGE FIXTURES TO BE INSTALLED BY F/X LUMINARE FACTORY-TRAINED & CERTIFIED TECHNICIANS WHOM IS ABLE TO PROVIDE LUXOR ZD & ZDC SYSTEM PROGRAMMING AND IN-FIELD
- 5. FIXTURES SHALL BE INDIVIDUALLY PROGRAMMABLE & DIMMABLE TO ACHIEVE MULTIPLE LUMEN OUTPUTS BASED ON LOCATION AND APPLICATION OF EACH FIXTURE; SEE "LIGHTING PROGRAM
- 6. LIGHTING CONTROLLER SHALL BE WI-FI COMPATIBLE TO ALLOW APP-BASED ON DEMAND SWITCHING & DIMMING OF INDIVIDUAL FIXTURES. AND LUXOR CLOUD TECHNOLOGIES
- 7. RECOMMENDED LIGHTING SUPPLIER: REINDERS INC. REINDERS IS AN AUTHORIZED FX LUMINAIRE MASTER DISTRIBUTOR AND IS FACTORY-TRAINED & CERTIFIED TO PROVIDE IN-FIELD SUPPORT FOR THE INSTALLATION AND PROGRAMMING OF LUXOR ZD & ZDC SYSTEMS. CONTACT: JOEL REINDERS, JPR@REINDERS.COM, 262-372-5780.

- 8. ALL FIXTURES ARE TO RECEIVE BETWEEN 10.0 AND 15 VOLTS.
- 9. INSTALLATION OF FIXTURES AND ASSOCIATED EQUIPMENT ARE TO CONFORM TO NEC AND UL 1838. 10. CONTRACTOR TO VERIFY EXISTING POWER LOCATIONS AND REQUIREMENTS. 11. PIPE SLEEVES ARE TO BE 2" WATER TIGHT SCHEDULE 40 PIPE AND SHOULD BE BURIED IN THE SOIL AT A 6" MINIMUM DEPTH (IN AREAS SUCH AS LAWNS AND FLOWER BEDS 10"-12" IS RECOMMENDED TO AVOID DAMAGE FROM TILLING OR AERATION AND EDGING.
- 12. METAL FENCE INSTALLER TO COORDINATE WITH LIGHTING INSTALLER REGARDING INSTALLATION LOGISTICS AND TIMING.
- 13. CONCRETE CONTRACTOR TO COORDINATE WITH LIGHTING INSTALLER REGARDING THE INSTALLATION OF PIPE SLEEVES, CABLE, ELECTRICAL BOXES AND LIGHT FIXTURES BEING PLACED IN CONCRETE FORMS. PIPE SLEEVES ARE TO BE PLACED IN GRANULAR BASE COURSE ENDS ARE TO BE TAPED SHUT AND MARKED WITH FLAGS.
- 14. ALL CABLE TO BE PROTECTED IN 1" SLEEVE, MINIMUM.
- 15. ALL FIXTURES THAT ARE SPECIFIED AS LED COLOR CHANGING SHALL USE RGBW TECHNOLOGY AND SHALL HAVE ADJUSTABILITY OF THE FOLLOWING ATTRIBUTE VALUES: HUE, SATURATION AND INTENSITY. COLOR PALETTES WILL BE DETERMINED UPON INSTALLATION AND/OR FINAL WALK THROUGH.
- 16. ALL LOW VOLTAGE LIGHTING CABLE CONNECTIONS TO BE DONE WITH A SILICONE-FILLED LOCKING KITCHLER 15529BLPRO CONNECTOR OR ACE BRASS SCREW-TIGHT LUG WITH SHRINK TUBE CONNECTOR 17. LOW VOLTAGE LIGHTING CABLE SHALL BE UL (1493) AND RATED FOR OUTDOOR USE (SUNLIGHT RESISTANT). LOW VOLTAGE LIGHTING CABLE GAUGE TO BE SIZED APPROPRIATELY BASED ON THE LOAD AND LENGTH OF THE LIGHTING RUN.
- 18. LANDSCAPE LIGHTING CONTRACTOR TO COORDINATE POWER REQUIREMENTS AND LOCATION OF EXTERIOR / WATER PROOF GFCI OUTLETS FOR PROPOSED NEW TRANSFORMER LOCATIONS WITH GENERAL CONTRACTOR AND LANDSCAPE ARCHITECT.
- 19. REVIEW AND FOLLOW MANUFACTURERS INSTALLATION INSTRUCTIONS FOR MOUNTING AND INSTALLING TRANSFORMERS 20. OWNER TO COORDINATE WITH LANDSCAPE ARCHITECT AND LIGHTING INSTALLER LIGHT SELECTION OF COLOR CAPABLE (ZDC) VERSUS NON COLORED (ZD) LIGHT FIXTURES.

21. FINAL THEME COLORS AND TIMES TO BE ADJUSTED WITH OWNER AFTER INSTALLATION.

LOCATION FOR LOW VOLTAGE LIGHTING TRANSFORMER. GENERAL CONTRACTOR TO COORDINATE LOCATION OF EXTERIOR / WATER PROOF GFCI OUTLETS FOR PROPOSED NEW TRANSFORMER LOCATION WITH ELECTRICAL CONTRACTOR AND LOW VOLTAGE LIGHTING INSTALLER. REFER TO LOW VOLTAGE LIGHTING INSTALLER'S NOTES AND SPECIFICATIONS \_\_FOR FURTHER INFORMATION.

2 LOCATION OF PVC SLEEVE FOR LOW VOLTAGE LIGHTING, KIOSKS AND OUTLETS. GENERAL CONTRACTOR TO COORDINATE LOCATION WITH PAVING CONTRACTOR AND LOW VOLTAGE LIGHTING INSTALLER. REFER TO LOW VOLTAGE LIGHTING INSTALLER'S NOTES AND SPECIFICATIONS FOR FURTHER INFORMATION.

LANDSCAPE )

Landscape Consulting
& Master Planning Design Sevices

11525 W. North Avenue, Suite 1B Wauwatosa, WI 53226 Tel (414) 476-1204 www.insitedesigninc.com mdavis@insitedesigninc.com

Project for:

#### WAUWATOSA VETERANS COMMITTEE

Wauwatosa, WI

<u>Project:</u>

## WAUWATOSA VETERANS MEMORIAL at HART PARK

72nd Street - Hart Park Wauwatosa, WI 53226

Issuance and Revisions:

Date	Number	Description
06/05/23		Client Review Submittal
06/29/23		Parks Dept Prelim Meeting
07/17/23		Parks Dept Meeting
08/28/23		Client Review Submittal
09/20/23		Phase I Construction Document Submittal
08/26/25		Design Review Board Submittal
09/09/25		Revisions based on Staff Review Comments / Design

COPYRIGHT InSite Landscape Design Inc. 2020 ALL RIGHTS RESERVED THIS DRAWING IS NOT TO BE REPRODUCED, CHANGED, COPIED OR ASSIGNED TO ANY THIRD PARTY IN ANY FORM OR MANNER WITHOUT FIRST OBTAINING THE EXPRESSED WRITTEN PERMISSION OF InSite Landscape Design, Inc. THE CLIENT AGREES TO INDEMNIFY AND HOLD THE InSite Landscape Design Inc. HARMLESS FROM ANY DAMAGES, LIABILITY, OR COST, INCLUDING ATTORNEY'S FEES AND COSTS OF DEFENSE ARISING FROM ANY CHANGES OR ALTERATIONS MADE BY ANYONE OTHER THAN THE InSite Landscape Design Inc., OR FROM ANY REUSE OF THE DRAWINGS OR DATA WITHOUT THE PRIOR WRITTEN CONSENT OF THE InSite Landscape Design Inc.

Review Board Re-Submittal

Sheet Title:

PROPOSED PHASE I & II LOW VOLTAGE LIGHTING PLAN, AND LIGHT FIXTURE TABLE

Date of Drawing:	09/09/25
Scale:	1" = 20'-0"
Drawn By:	MCD
Job Number:	L23-025

Sheet Number:

FXLuminaire.

The Luxor Controller offers zoning, dimming, and RGBW color-changing capabilities, plus optional Wi-Fi

Quick Facts

 250 independent lighting zones
 Luxor Linking compatible for in any wiring configuration Adjust intensity from 0-100%

Android™ app control

30,000 color options per zone

a single point of control in larger installations

 Built-in astronomical timing Event-based scheduling options
 304 stainless steel and powder- Optional cloud-based IOS® or coated galvanized construction ETL and CE certified

LANDSCAPE & ARCHITECTURAL LIGHTING

#### **LUXOR** Controller SPECIFICATIONS

Output

LED Lighting Controller

CE Version

8" (203 mm)

17

PROJECT

CATALOG#

Standard

Version

8" (203 mm)

TYPE

260 W (CE version) 300 W Input Primary 220-240 V, 50-60 Hz 220-240 V, 50-60 Hz 120 V, 60 Hz 2.68 A Input Amperage Primary Output Voltage Secondary 14 VAC 15 VAC 15 VAC 15 VAC Maximum Open Circuit Volts **ISELV** IP Rating IP43

FX Luminaire FX Luminaire is an industry-

leading manufacturer of landscape and architectural lighting products with a focus on the advancement of LED technology and digital lighting control with zoning, dimming, and color adjustment capabilities. We offer a full spectrum of specification-driven lighting fixtures that can be utilized to create elegant, cuttingedge landscape lighting systems for commercial or residential applications. Our products are available exclusively via our extensive professional distributor network.

Materials 304 stainless steel and powdercoated galvanized steel outer box Hardware Two pan-head machined

mounting screws with plastic mounting brackets attached to transformer box. Heavy-gauge, grounded,

integrally molded plug; 5' (1.5 m) length. Standard lowvoltage lighting wire required (e.g., 12-2, 10-2, etc./2.05 mm, 2.58 mm, etc.) between controlle and fixtures. No additional communication wire is required.

Input: 120 VAC, 60 Hz Input: 220-240 V, 50-60 Hz (230 V/CE version) Ambient Operating Temperature

Luxor Linking offers an easy way

hardwired (Cat 5/5e/6)

is 3.000' (0.9 km). With wireless

Luxor Linking, add 10+ satellite

controller by LoRa radio up to

Only fixtures or devices with

have varying levels of control,

dimming, or 3) zoning/dimr

color. Mix and match fixture

control technology on a

devices with varying levels of

Luxor Technology are compatible

3,000' (0.9 km).

Compatible Devices

units connected to the primary

0°F to 140°F (-18°C to 60°C) Create up to 250 independently Wi-Fi Connectivity adjustable lighting zones. Control each zone independentl router with the Luxor Wi-Fi with separate on/off times, various intensities (0-100% in LAN Module. Optional "Direct Connect\* mode allows devices Luxor Linking

or a network router. with a single point of control. Communication Preinstalled 8" (203 mm) RJ-11 add up to nine satellite units, fo communication cable between a total of 10 units. The maximum facepack (i.e., user interface) and chassis (i.e., power unit). connection between the primary Wireless App Control and farthest satellite controller

Network module required. The Luxor App is available for iOS and Android devices. Control via app available for on-site or

Standard stainless steel finish and

manually via assignment ports

he Light Assignment Module

to connect directly to a single

controller without using Wi-Fi

on facepack or wirelessly via

International Compliance

IEC-61347-2-11

Sustainability

Compliant per IEC 61347-1 and

Innovation meets conservation

can, we use recycled materials

while maintaining superior

provide high-quality light at

ISO 9001:2015 certified facility

**₹ (€&.**@.

of our products. Where we

in the design and manufacturing

with the Luxor Controller. Devices 300 W: 23.1 lb (10.5 kg) including: 1) zoning, or 2) zoning/ 300 W (CE): 19.1 lb (8.7 kg) Installation Requirements Designed for installation on a vertical surface in the upright

position only. Transformer must

be in a free airspace; do not instal

matte gray powder coat.

**Learn more.** Visit fxl.com | +1-760-744-5240

#### LUXOR Controller ordering information

Item	Wattage	Compliance	Finish	
LUX	■ 300	■ [default]	■ SS	
Luxor Controller	300 W	120 V, North America	Stainless Steel	
LSAT		III e	■ M	E
Luxor Satellite Contro	ller	230 V, International	Matte Gray	
		™ eu		
		230 V, CE Certified		

- 300 - -

EXAMPLE CONTROLLER CONFIGURATION: LUX-300-SS


WIRELESS CONTROLLER ACCESSORIES: Specify Separately

Item	Code
■ WI-FI MODULE	WIFI-MOD2
■ WI-FI MODULE REMOTE MOUNT 10' (3 m)	WIFI-MOD2-RMT
LIGHT ASSIGNMENT MODULE	LAM
WIRELESS LINKING MODULE, NORTH AMERICA	LINK-MOD
WIRELESS LINKING MODULE, INTERNATIONAL	LINK-MOD-E

Learn more. Visit fxl.com | +1-760-744-5240

#### LUXOR Controller LINKING COMPARISON

FEATURES	Wireless Luxor Linking	Hardwired Luxor Linking	
Communication	LoRa radio (wireless)	Network cable (Cat 5/5e/6)	
Distance	Up to 3,000' or 914 m	3,000' or 914 m (installed wire)	
Number of Linked Controllers	10+	Up to 10	
Installation	Mount at controller or remote	Direct-burial Cat 5/5e/6 cable and conduit	
Diagnostics	Yes (unique IDs)	Yes (variable)	

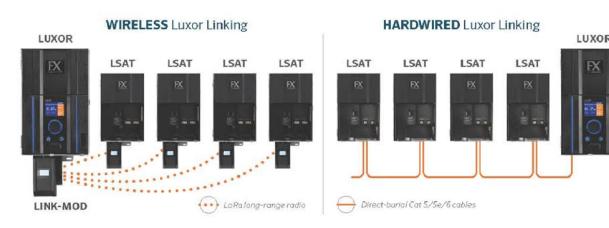

® 2022 Hunter Industries®. Hunter, FX Luminaire, all related logos, and all other trademarks are property of Hunter Industries, registered in the U.S. and other countries

Learn more. Visit fxl.com | +1-760-744-5240

FXLIT-015 B 5/22

## FX LUMINAIRE LUXOR CONTROLLER



The innovative construction of SRP Strip Lights vastly simplifies installation — even if you've never done it before.

#### **Key Benefits**

- Extruded silicone body reduces hot spots, produces soft light distribution, and protects
- against harsh environments Silicone-encased LEDs deliver a soft, diffused light distribution for top performance in a range of applications
- A high IP65 rating ensures dust-proof and water-resistant performance












#### **SRP WHITE** Strip Light

Highly versatile SRP Strip Lights make it easier than ever to illuminate stair ledges, outdoor patios, hardscape elements, and more.

#### Features

- 12 VAC power ensures compatibility with any low-voltage lighting transformer
- Two color temperature options offer a warm (2,700K) or soft (3,000K) look
- 10' (3.1 m) and 40' (12.2 m) lengths Preinstalled 10' (3.1 m) power feed
- Compatible with Luxor® Low-Voltage CUBE (LCM-LV) for zoning and dimming capabilities

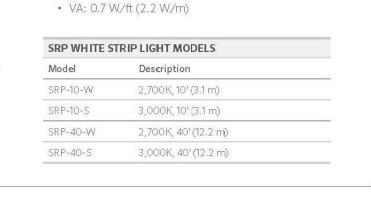

Total Lumens: 28.7 lm/ft (94.6 lm/m)

Input Power: 0.6 W/ft (2.1 W/m)

Input Voltage: 10 to 15 V

#### **SRP RGBW** Strip Light Endless opportunities to color your world! When installed with the SRP-CC Color Controller, the SRP RGBW Strip Light is compatible with the next-generation Luxor Controller from FX Luminaire or any traditional low-voltage transformer for unmatched color-changing effects. Total Lumens: 24.3 lm/ft (80.0 lm/m) Same award-winning design as SRP White (install, construction, etc.) · Input Voltage: 10 to 15 V 12 VAC power ensures compatibility with any Input Power; 1.7 W/ft (5.6 W/m) low-voltage lighting transformer VA: 2.9 W/ft (9.6 W/m) \* Total RBGW control; SRP-CC Strip Light Color Controller required SRP RGBW STRIP LIGHT MODELS · Two convenient control options: Standalone or Luxor Mode Description Luxor Mode allows a Luxor Controller to SRP-RGBW SRP RGBW Strip Light, 10' (3.1 m) assign a Group and set Hue, Saturation, and Intensity values Strip Light Color Controller Standalone Mode can be used with our EX, PX, and DX models as well as any standard low-voltage transformer, allowing you to manually set Hue, Saturation, and Intensity values Luxor Mode Standalone Mode



FX-318 BR US 7/22

© 2022 Hunter industries<sup>™</sup>. Hunter, FX.Luminaire, all related logas, and all other trademarks are property of Hunter Industries, registered in the U.S. and other countries 🚓 Please recycle.





11525 W. North Avenue, Suite 1B Wauwatosa, WI 53226 Tel (414) 476-1204 www.insitedesigninc.com

Project for:

#### WAUWATOSA **VETERANS COMMITTEE**

Wauwatosa, WI

<u>Project:</u>

## WAUWATOSA **VETERANS MEMORIAL** at HART PARK

72nd Street - Hart Park Wauwatosa, WI 53226

Issuance and Revisions:

| Number | Description 06/05/23 Client Review Submittal 06/29/23 Parks Dept Prelim Meeting 07/17/23 Parks Dept Meeting 08/28/23 Client Review Submittal 09/20/23 Phase I Construction Document Submittal

> Design Review **Board Submittal** Revisions based on Staff Review Comments / Design

Review Board Re-Submittal

COPYRIGHT InSite Landscape Design Inc. 2020 ALL RIGHTS RESERVED

THIS DRAWING IS NOT TO BE REPRODUCED, CHANGED, COPIED OR ASSIGNED TO ANY THIRD PARTY IN ANY FORM OR MANNER WITHOUT FIRST OBTAINING THE EXPRESSED WRITTEN PERMISSION OF InSite Landscape Design, Inc. THE CLIENT AGREES TO INDEMNIFY AND HOLD THE InSite Landscape Design Inc. HARMLESS FROM ANY DAMAGES, LIABILITY, OR COST, INCLUDING ATTORNEY'S FEES AND COSTS OF DEFENSE ARISING FROM ANY CHANGES OR ALTERATIONS MADE BY ANYONE OTHER THAN THE InSite Landscape Design Inc., OR FROM ANY REUSE OF THE DRAWINGS OR DATA

WITHOUT THE PRIOR WRITTEN CONSENT OF THE

InSite Landscape Design Inc.

Sheet Title:

08/26/25

09/09/25

PROPOSED LIGHT FIXTURES

Date of Drawing:	09/09/25
Scale:	NONE
Drawn By:	MCD
Job Number:	L23-025

Sheet Number:

<u>Project:</u>

Wauwatosa, WI

XN-70 Grande In-Grade ordering information

18.0 W / 23.0 VA

21.0 W / 25.0 VA

Beam Width

13.5' (4.1 m) 13.7' (4.2 m)

20.2' (6.2 m) 20.6' (6.3 m) 27' (8.2 m) 27.4' (8.4 m)

33.7'(10.3 m) 34.3'(10.5 m)

Beam Width

11.6' (3.5 m) 11.7' (3.6 m)

23.3' (7.1 m) 23.5' (7.2 m)

34.9' (10.6 m) 35.2' (10.7 m)

0.3 fc (4 lx) 58.2' (17.7 m) 58.7' (17.9 m)

EXAMPLE FIXTURE CONFIGURATION: XV-70-XX-XXXX-XX

XN-70, H1, Flood - Illuminance at a Distance

Center Beam fc

1.7 fc (19 lx)

XN-70, H1, Wide Flood - Illuminance at a Distance

Center Beam fc

10.0' (3.0 m)

30.0' (9.1 m)

LANDSCAPE AND ARCHITECTURAL LIGHTING

4 of 10

Feet (Meters) Foot-Candles (Lux) Vertical: 60 ° Horizontal: 60 °

[default ZDC option]

Color Temp

Soft (3000K)

[default ZDC option]

Beam Angle Style Finish

DG Desert Granite

SS Stainless Steel

Weathered Iron

Sedona Brown

Flat White

Catalog No.

Learn more. Visit: fxl.com | +1760.744.5240

Generated 28 Jun 2023 13:49:10

FL Flood (40°)

MOUNTING OPTIONS: Specify Separately

GLARE OPTIONS: Specify Separately

Hex Baffle for MR-16 LED 250015260000

Mounting Kit for KT or

Fixture Luxor Option Lamp

Zone/Dim

WAUWATOSA VETERANS MEMORIAL at HART PARK

**VETERANS COMMITTEE** 

72nd Street - Hart Park Wauwatosa, WI 53226

Issuance and Revisions:

09/20/23

Date	Number	Description
06/05/23		Client Review Submittal
06/29/23		Parks Dept Prelim Meeting
07/17/23		Parks Dept Meeting
08/28/23		Client Review Submittal

08/26/25 Design Review Board Submittal 09/09/25 Revisions based on Staff Review Comments / Design Review Board Re-Submittal

Phase I Construction

Document

Submittal

COPYRIGHT InSite Landscape Design Inc. 2020 ALL RIGHTS RESERVED THIS DRAWING IS NOT TO BE REPRODUCED,

CHANGED, COPIED OR ASSIGNED TO ANY THIRD PARTY IN ANY FORM OR MANNER WITHOUT FIRST OBTAINING THE EXPRESSED WRITTEN PERMISSION OF InSite Landscape Design, Inc. THE CLIENT AGREES TO INDEMNIFY AND HOLD THE InSite Landscape Design Inc. HARMLESS FROM ANY DAMAGES, LIABILITY, OR COST, INCLUDING ATTORNEY'S FEES AND COSTS OF DEFENSE ARISING FROM ANY CHANGES OR ALTERATIONS MADE BY ANYONE OTHER THAN THE InSite Landscape Design Inc., OR FROM ANY REUSE OF THE DRAWINGS OR DATA


WITHOUT THE PRIOR WRITTEN CONSENT OF THE InSite Landscape Design Inc.

Sheet Title:

PROPOSED LIGHT FIXTURES

Date of Drawing:	09/09/25
Scale:	NONE
Drawn By:	MCD
Job Number:	L23-025

Sheet Number:

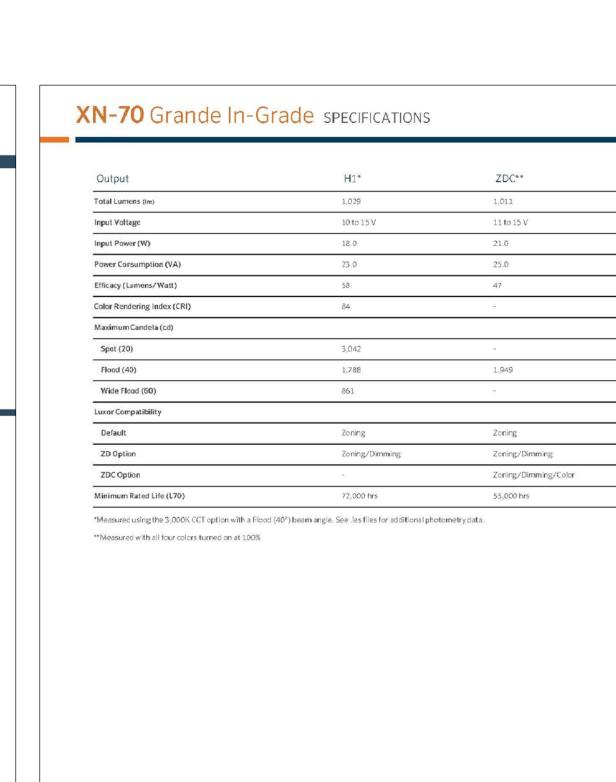

LANDSCAPE AND ARCHITECTURAL LIGHTING

2 of 10

FX Luminaire is an industry- leading manufacturer of	Primary: Consult transformer specifications Secondary;	Nonreplaceable Molex connector with Moisture	Temperature 0°F to 140°F (-18°C to 60°C)	ISO 9001:2015 certified facility
landscape and architectural lighting products with a focus on the advancement of LED	Luxor® control or a trailing- edge (reverse phase-cut) dimmer.	Block™ Technology to prevent moisture from wicking up into sealed areas of the luminaire.	Sustainability	Warranty 10-year limited warranty
technology and digital lighting control with zoning, dimming,	Configuration	Power	Innovation meets conservation in the design and manufacturing of our	Listings
and color adjustment capabilities. We offer a full spectrum of specification- driven lighting fixtures that can	Integral driver. Finish	Input 10-15 Vac/dc, 50/60 Hz. for white, and 11-15 Vac, 50/60 Hz. for RGBW (ZDC).	products. Where we can, we use recycled materials while maintaining superior	LISTED . NOM
be utilized to create elegant, cutting-edge landscape lighting systems for	Polished stainless steel finish and polyester TGIC powder- coat layer. Tested to ASTM	Remote transformer required (specify separately).  Housing	functionality. Our LED products provide high quality light at optimal energy efficiency, lifespan, and	C€ RoHS
commercial or residential applications. Our products are available exclusively via our	standards.  Hardware	Die-cast aluminum.	durability.	COMPLIANT
extensive professional distributor network.	Teflon-coated faceplate screws.	<b>Weight</b> 5.5 lb / 2.5 kg	Requirements Designed for recessed	UK CA
Materials 316 marine-grade stainless steel, die-cast aluminum, and	Wiring Bottom entry 16 AWG (1.3 mm); SOW Cable, 105 C, 600	Lens High optical purity glass with lead strength suitable for	installation in the upward direction only.	
stainless steel hardware.	V, 3' (1 m) length.	walk-over and drive-over applications. Static load rating: 4,400 lb (2,000 kg).	Control  ZD or ZDC utilizes Luxor  Technology to zone fixtures in	అ
Integrated module with Cree LEDs. Gold-plated connectors and potted driver for maximum reliability and corrosion resistance. Proprietary onboard intelligent driver uses firmware-controlled temperature regulation, maximizing LED life.			up to 250 groups, dim each group in 1% increments between 0 and 100%, or change to one of 30,000 colors with RGBW LEDs. Select the ZD option for zoning/dimming or ZDC for zoning/dimming/color. Standard fixture zoneable	
Optics			with Luxor Controller.	
Color temperature and beam angle defined by part number. Both components are serviceable with parts ordered separately.				

FX Luminaire  FX Luminaire  FX Luminaire is an industry-leading manufacture of landscape and architectural lighting products with a focus on the advancement of LED common and a consideration and color adjustiment capabilities. We offer a full spectrum of specification-drivenlighting flutures that can be utilized to create elegant, cutting-edge landscape lighting systems for commercial or residential applications. Our products are available accusablely your and distribution retwined distribution retwined distribution retwined.  Materials  3.15 merine-grade stainless steel, ide-cast duminum, and stainless steel hardware.  LED  Integrated module with Cree LEDs. Gold-plated connectors and potted driver for maximum reliability and corrosion resistance. Proprietary onboard intelligent driver uses firmwere-cutro field emperature regulation, maximum glability and corrosion resistance. Proprietary onboard intelligent driver uses firmwere-cutro field emperature regulation, maximum glability and corrosion resistance. Proprietary onboard intelligent driver uses firmwere-cutro field emperature regulation, maximum glability and corrosion resistance. Proprietary onboard intelligent driver uses firmwere-cutro field emperature regulation, maximum glability and corrosion resistance. Proprietary onboard intelligent driver uses firmwere-cutro field emperature regulation, maximum glability and corrosion resistance. Proprietary onboard intelligent driver uses firmwere-cutro field emperature regulation, maximum glability and corrosion resistance. Proprietary onboard intelligent driver uses firmwere-cutro field emperature spatial resistance. Proprietary onboard intelligent driver uses firmwere-cutro field emperature spatial resistance. Proprietary onboard intelligent driver uses firmwere-cutro field emperature spatial resistance. Proprietary onboard proprietary on the proprietary on th			
	Primary: Consult transformer specifications Secondary: Luxor® control or a trailing-edge (reverse phase-cut) dimmer.  Configuration Integral driver.  Finish Polished stainless steel finish and polyester TGIC powder-coat layer. Tested to ASTM standards.  Hardware Teflon-coated faceplate screws.  Wiring Bottom entry 16 AWG (1.3 mm); SOW Cable, 105 C, 600	cuminaire is an industry- ling manufacturer of iscape and architectural iting products with a focus he advancement of LED inology and digital lighting trol with zoning, dimming, color adjustment abilities. We offer a full ctrum of specification- en lighting fixtures that can itilized to create elegant, ing-edge landscape ling systems for imercial or residential lications. Our products are lable exclusively via our ensive professional ributor network.  terials marine-grade stainless el, die-cast aluminum, and enless steel hardware.  ) grated module with Cree s. Gold-plated connectors potted driver for maximum bibility and corrosion stance. Proprietary oard intelligent driver uses ware-controlled perature regulation, dimizing LED life. tics or temperature and beam le defined by part number. In components are inceable with parts ordered	
LANDSCAPE AND ARCHITECTURAL LIGHTING	GHTING	APE AND ARCHITECTURAL L	

Learn more. Visit: fxl.com | +1760.744.5240



+1760.74	4.5
	ļ

PROJECT

CATALOG#

FXLuminaire.

The new Exa Collection offers high-output performance with

low-voltage simplicity. With stainless steel construction plus

IP68 and drive-over ratings, the modern Exa In-Grade provides

light output up to 1,000 lumens. It also offers beam angle and

Luxor® Technology. The internal rotation and tilt adjustability

with a fully recessed design results in a clean, easy installation.


color temperature options that are compatible with

**Quick Facts** 

XN-70 Grande In-Grade DESIGNER PREMIUM

1 of 10 Generated 28 Jun 2023 13:49:10

FX LUMINAIRE XN-70 GRANDE IN-GRADE LUMINAIRE

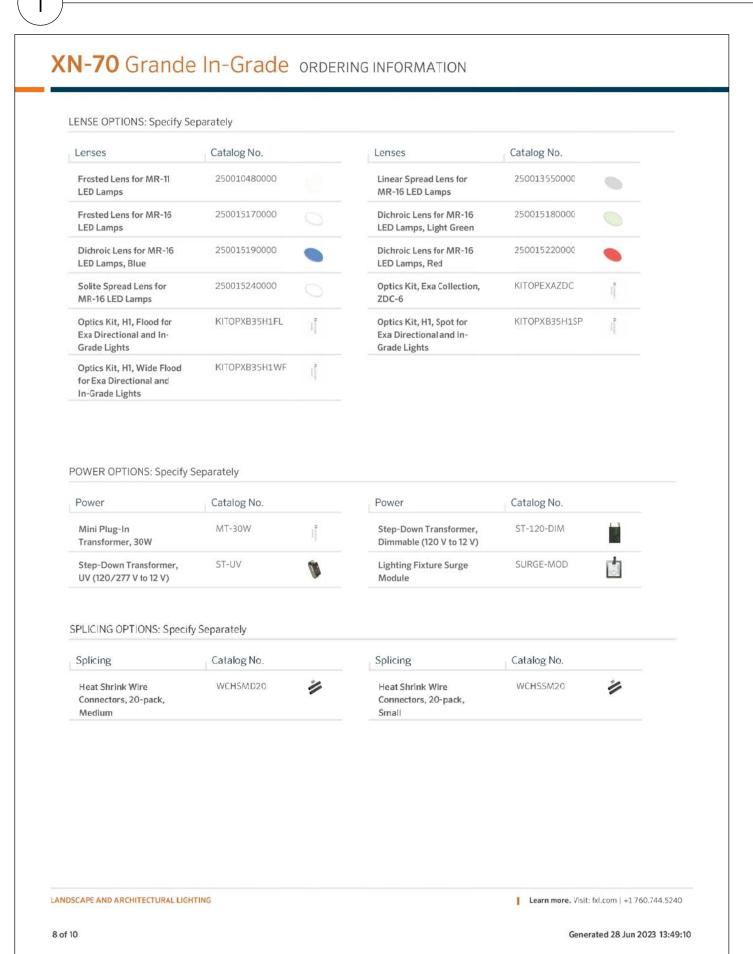

FX LUMINAIRE SRP RGBW STRIP LIGHT