


SITE INFORMATION SITE AREA 159746 3.667 AC SITE DISTURBED AREA 159746 3.667 AC 73350 1.684 AC 45.9 % EXISTING IMPERVIOUS AREA PROPOSED IMPERVIOUS AREA 95270 2.187 AC 59.6 % TOTAL PARKING SPACES 68 ADA PARKING SPACES 3

Single Source. Sound Solutions. GROUP www.thesigmagroup.com 1300 West Canal Street Milwaukee, WI 53233 Phone: 414-643-4200 Fax: 414-643-4210

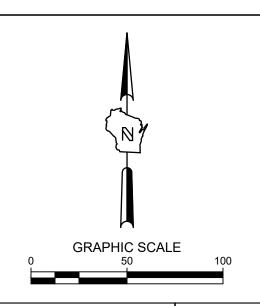

LEGEND:



5" THICK CONCRETE WALK



ASPHALT SURFACE



CURB & GUTTER (ACCEPT)

CURB & GUTTER (REJECT)

GENERAL NOTES:

- 1. THE UNDERGROUND UTILITY INFORMATION SHOWN ON THIS DRAWING IS BASED ON FIELD LOCATIONS AND/OR RECORDS FURNISHED BY MUNICIPALITIES AND UTILITY COMPANIES. THE LOCATION AND ACCURACY OF WHICH CANNOT BE GUARANTEED. THERE MAY BE ADDITIONAL UNDERGROUND UTILITY INSTALLATIONS WITHIN THE PROJECT AREA THAT ARE NOT SHOWN.
- 2. VERIFY ACTUAL LOCATIONS AND INVERTS IN THE FIELD. ANY POTENTIAL ERRORS, OMISSIONS, OR DISCREPANCIES SHALL BE BROUGHT TO THE ATTENTION OF THE ENGINEER PRIOR TO PROCEEDING WITH CONSTRUCTION.
- 3. WORK TO BE COMPLETED IS INDICATED IN BOLD TYPE LINES AND EXISTING CONDITIONS ARE INDICATED BY LIGHT TYPE LINES.
- 4. ELECTRONIC CIVIL FILES ARE AVAILABLE UPON WRITTEN REQUEST. DO NOT USE ELECTRONIC CIVIL FILES TO LAYOUT FOUNDATIONS, COLUMN LINES, LIGHT POLES, OR OTHER NON CIVIL SITE WORK. REFER TO ARCHITECTURAL DRAWINGS FOR DIMENSIONS OF BUILDING AND ARCHITECTURAL FEATURES.
- 5. DIMENSIONS ARE FROM FACE OF CURB OR EDGE OF PAVEMENT.
- 6. WORK WITHIN THE PUBLIC RIGHT OF WAY, INCLUDING BUT NOT LIMITED TO DRIVEWAY OPENINGS, SIDEWALK AND RAMPS, PAVING, AND CURB AND GUTTER SHALL BE COMPLETED PER MUNICIPAL AND/OR COUNTY REQUIREMENTS AND STANDARDS.
- 7. EARTHWORK SHALL BE IN ACCORDANCE WITH GEOTECHNICAL ENGINEER'S RECOMMENDATIONS.

DRIVE

SER.


10701

ISSUANCE DATE

NO. REVISION DATE


1"=50' PROJECT NO: 20116 DESIGN DATE: PLOT DATE: 2023.02.22 DRAWN BY: CHECKED BY: APPROVED BY: ---

C100

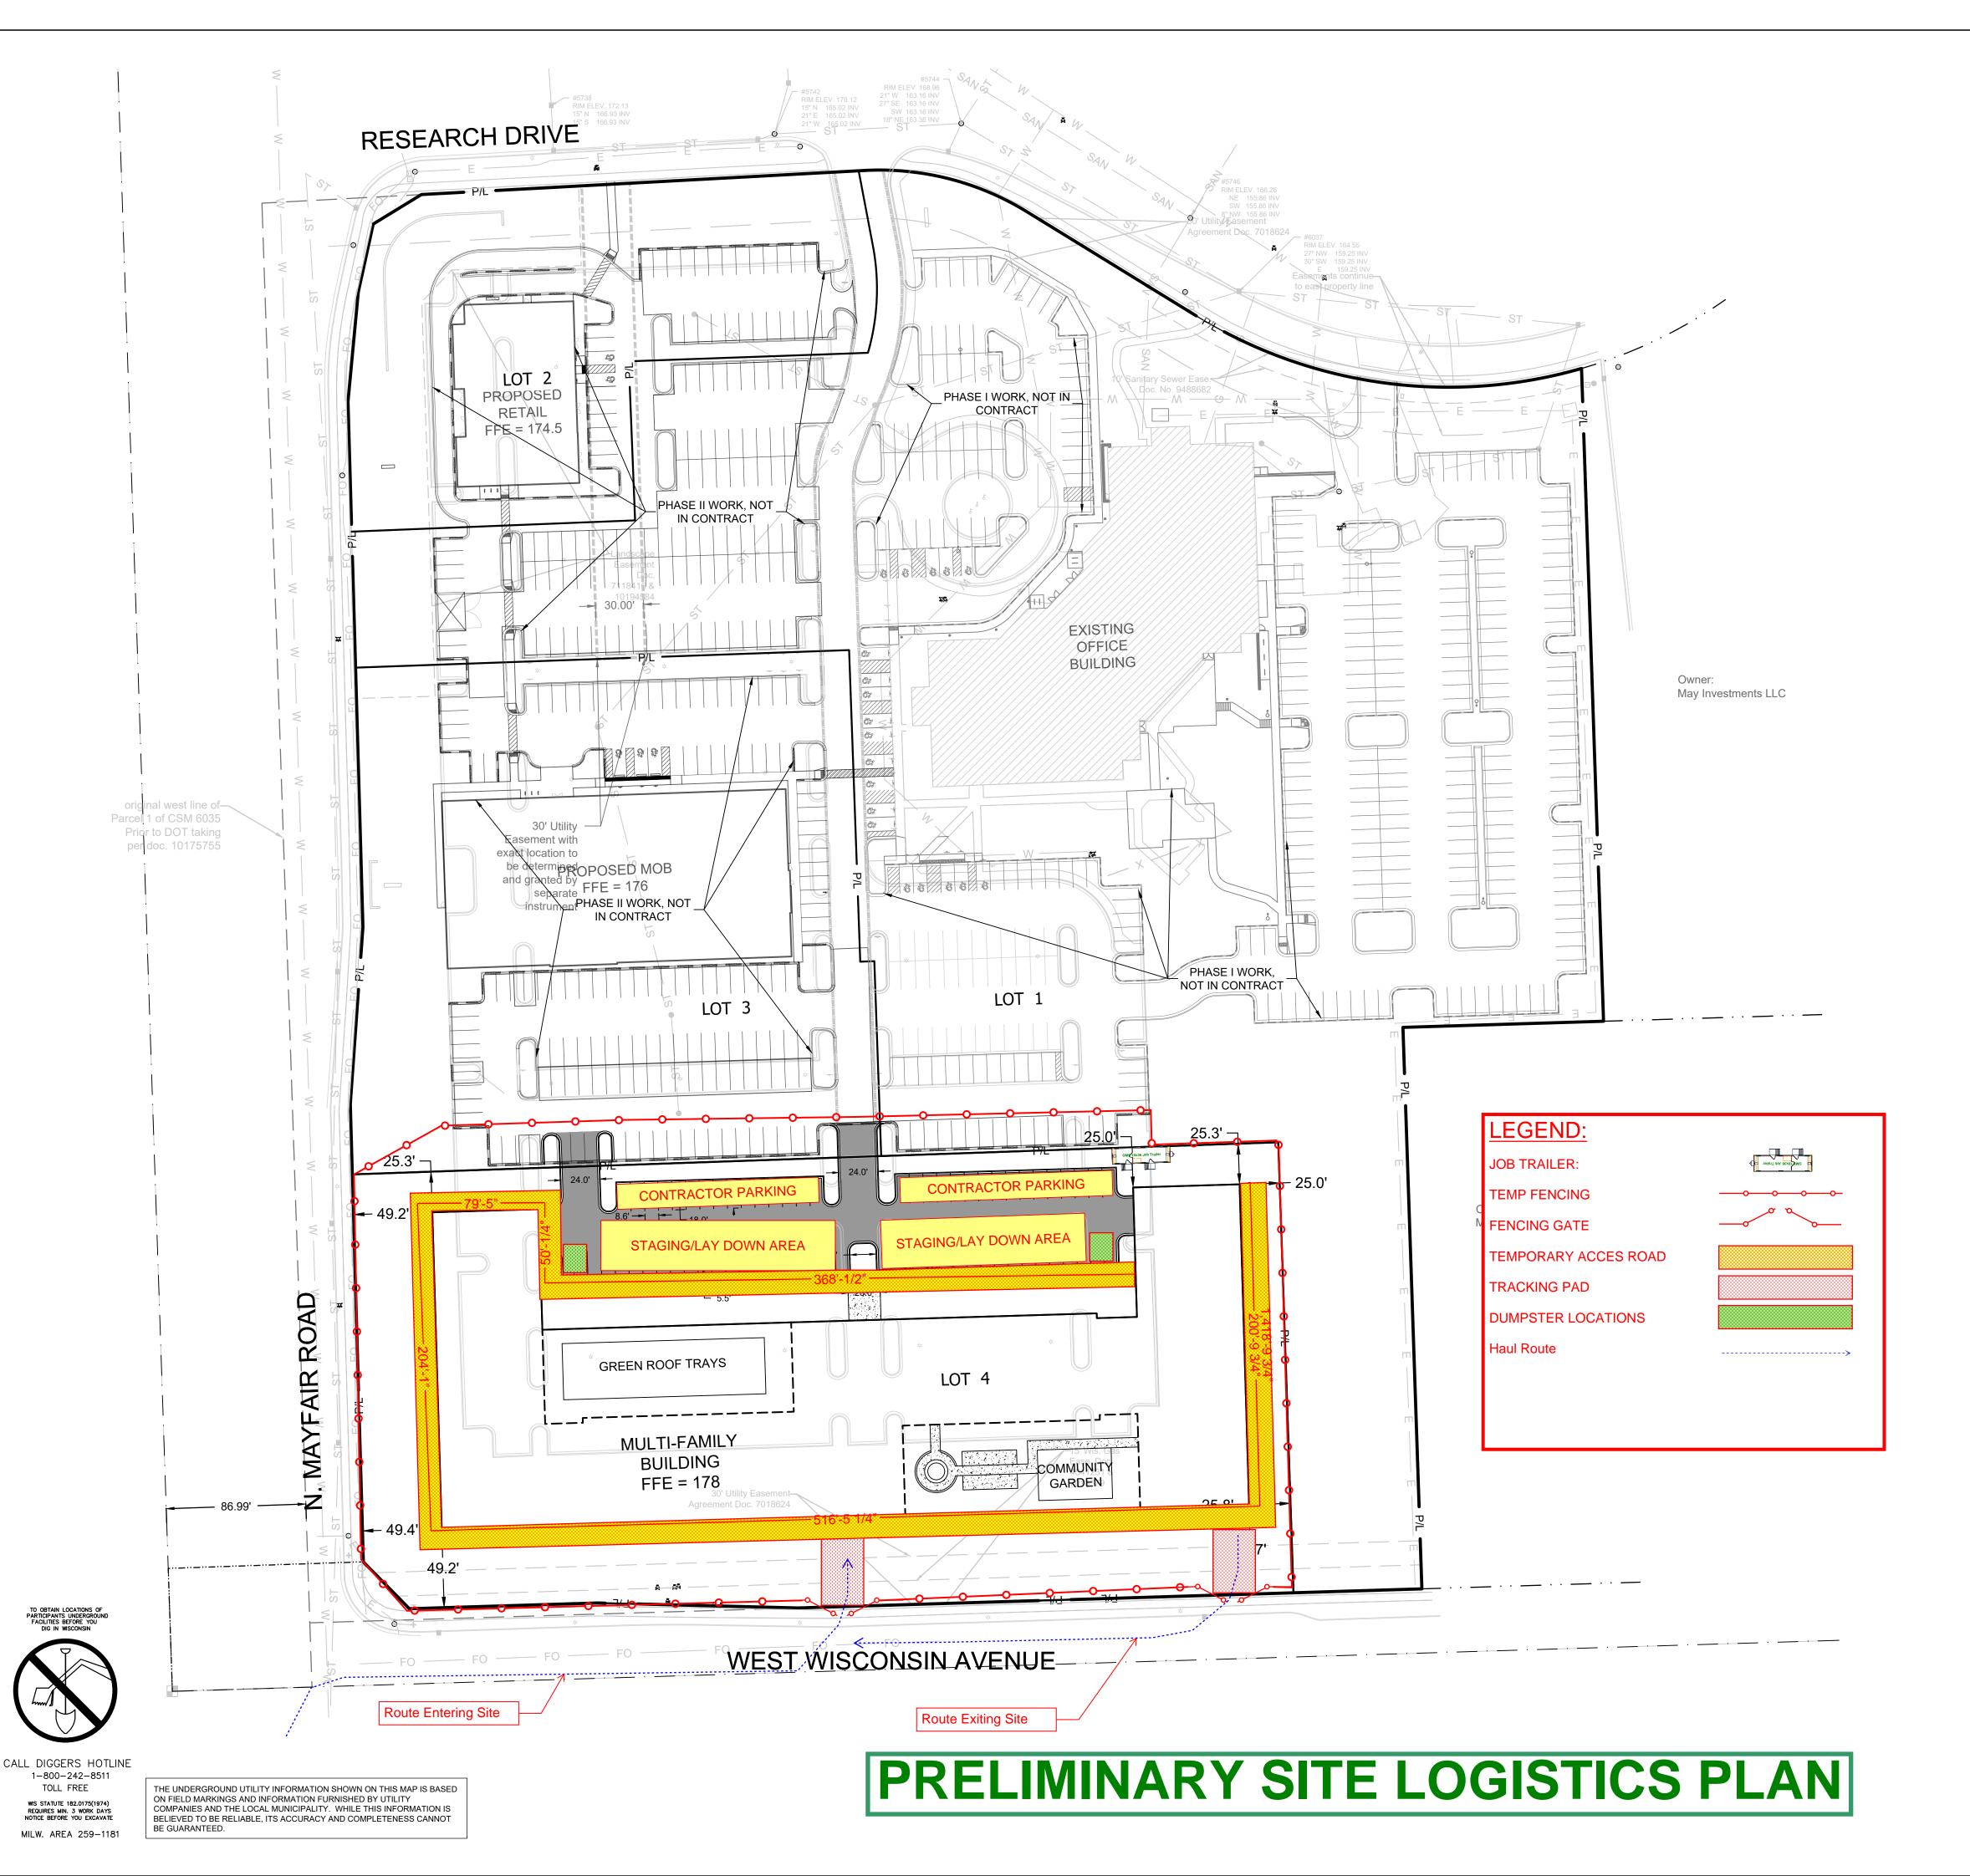

SITE INFORMATION SITE AREA 159746 3.667 AC SITE DISTURBED AREA 159746 3.667 AC 73350 EXISTING IMPERVIOUS AREA 1.684 AC 45.9 % PROPOSED IMPERVIOUS AREA 95270 2.187 AC 59.6 % TOTAL PARKING SPACES 68 ADA PARKING SPACES 3

IN Single Source. Sound Solutions. A GROUP www.thesigmagroup.com 1300 West Canal Street Milwaukee, WI 53233 Phone: 414-643-4200 Fax: 414-643-4210

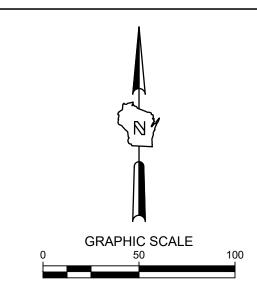

LEGEND:





5" THICK CONCRETE WALK





CURB & GUTTER (ACCEPT)

CURB & GUTTER (REJECT)

GENERAL NOTES:

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DRIVE

SER.

10701


SITE

ISSUANCE DATE

NO. REVISION DATE


1"=50' PROJECT NO: 20116 DESIGN DATE: PLOT DATE: 2023.02.22 DRAWN BY: CHECKED BY: APPROVED BY:

C100

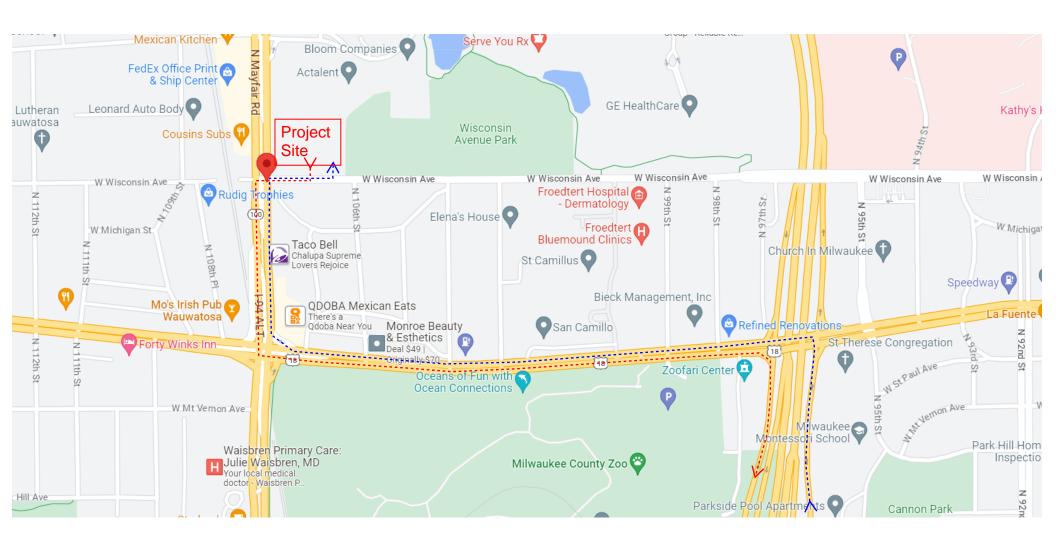


PRELIMINARY HAUL ROUTE PLAN

LEGEND:	
Haul Route Inbound	>>
Haul Route Outbound	>

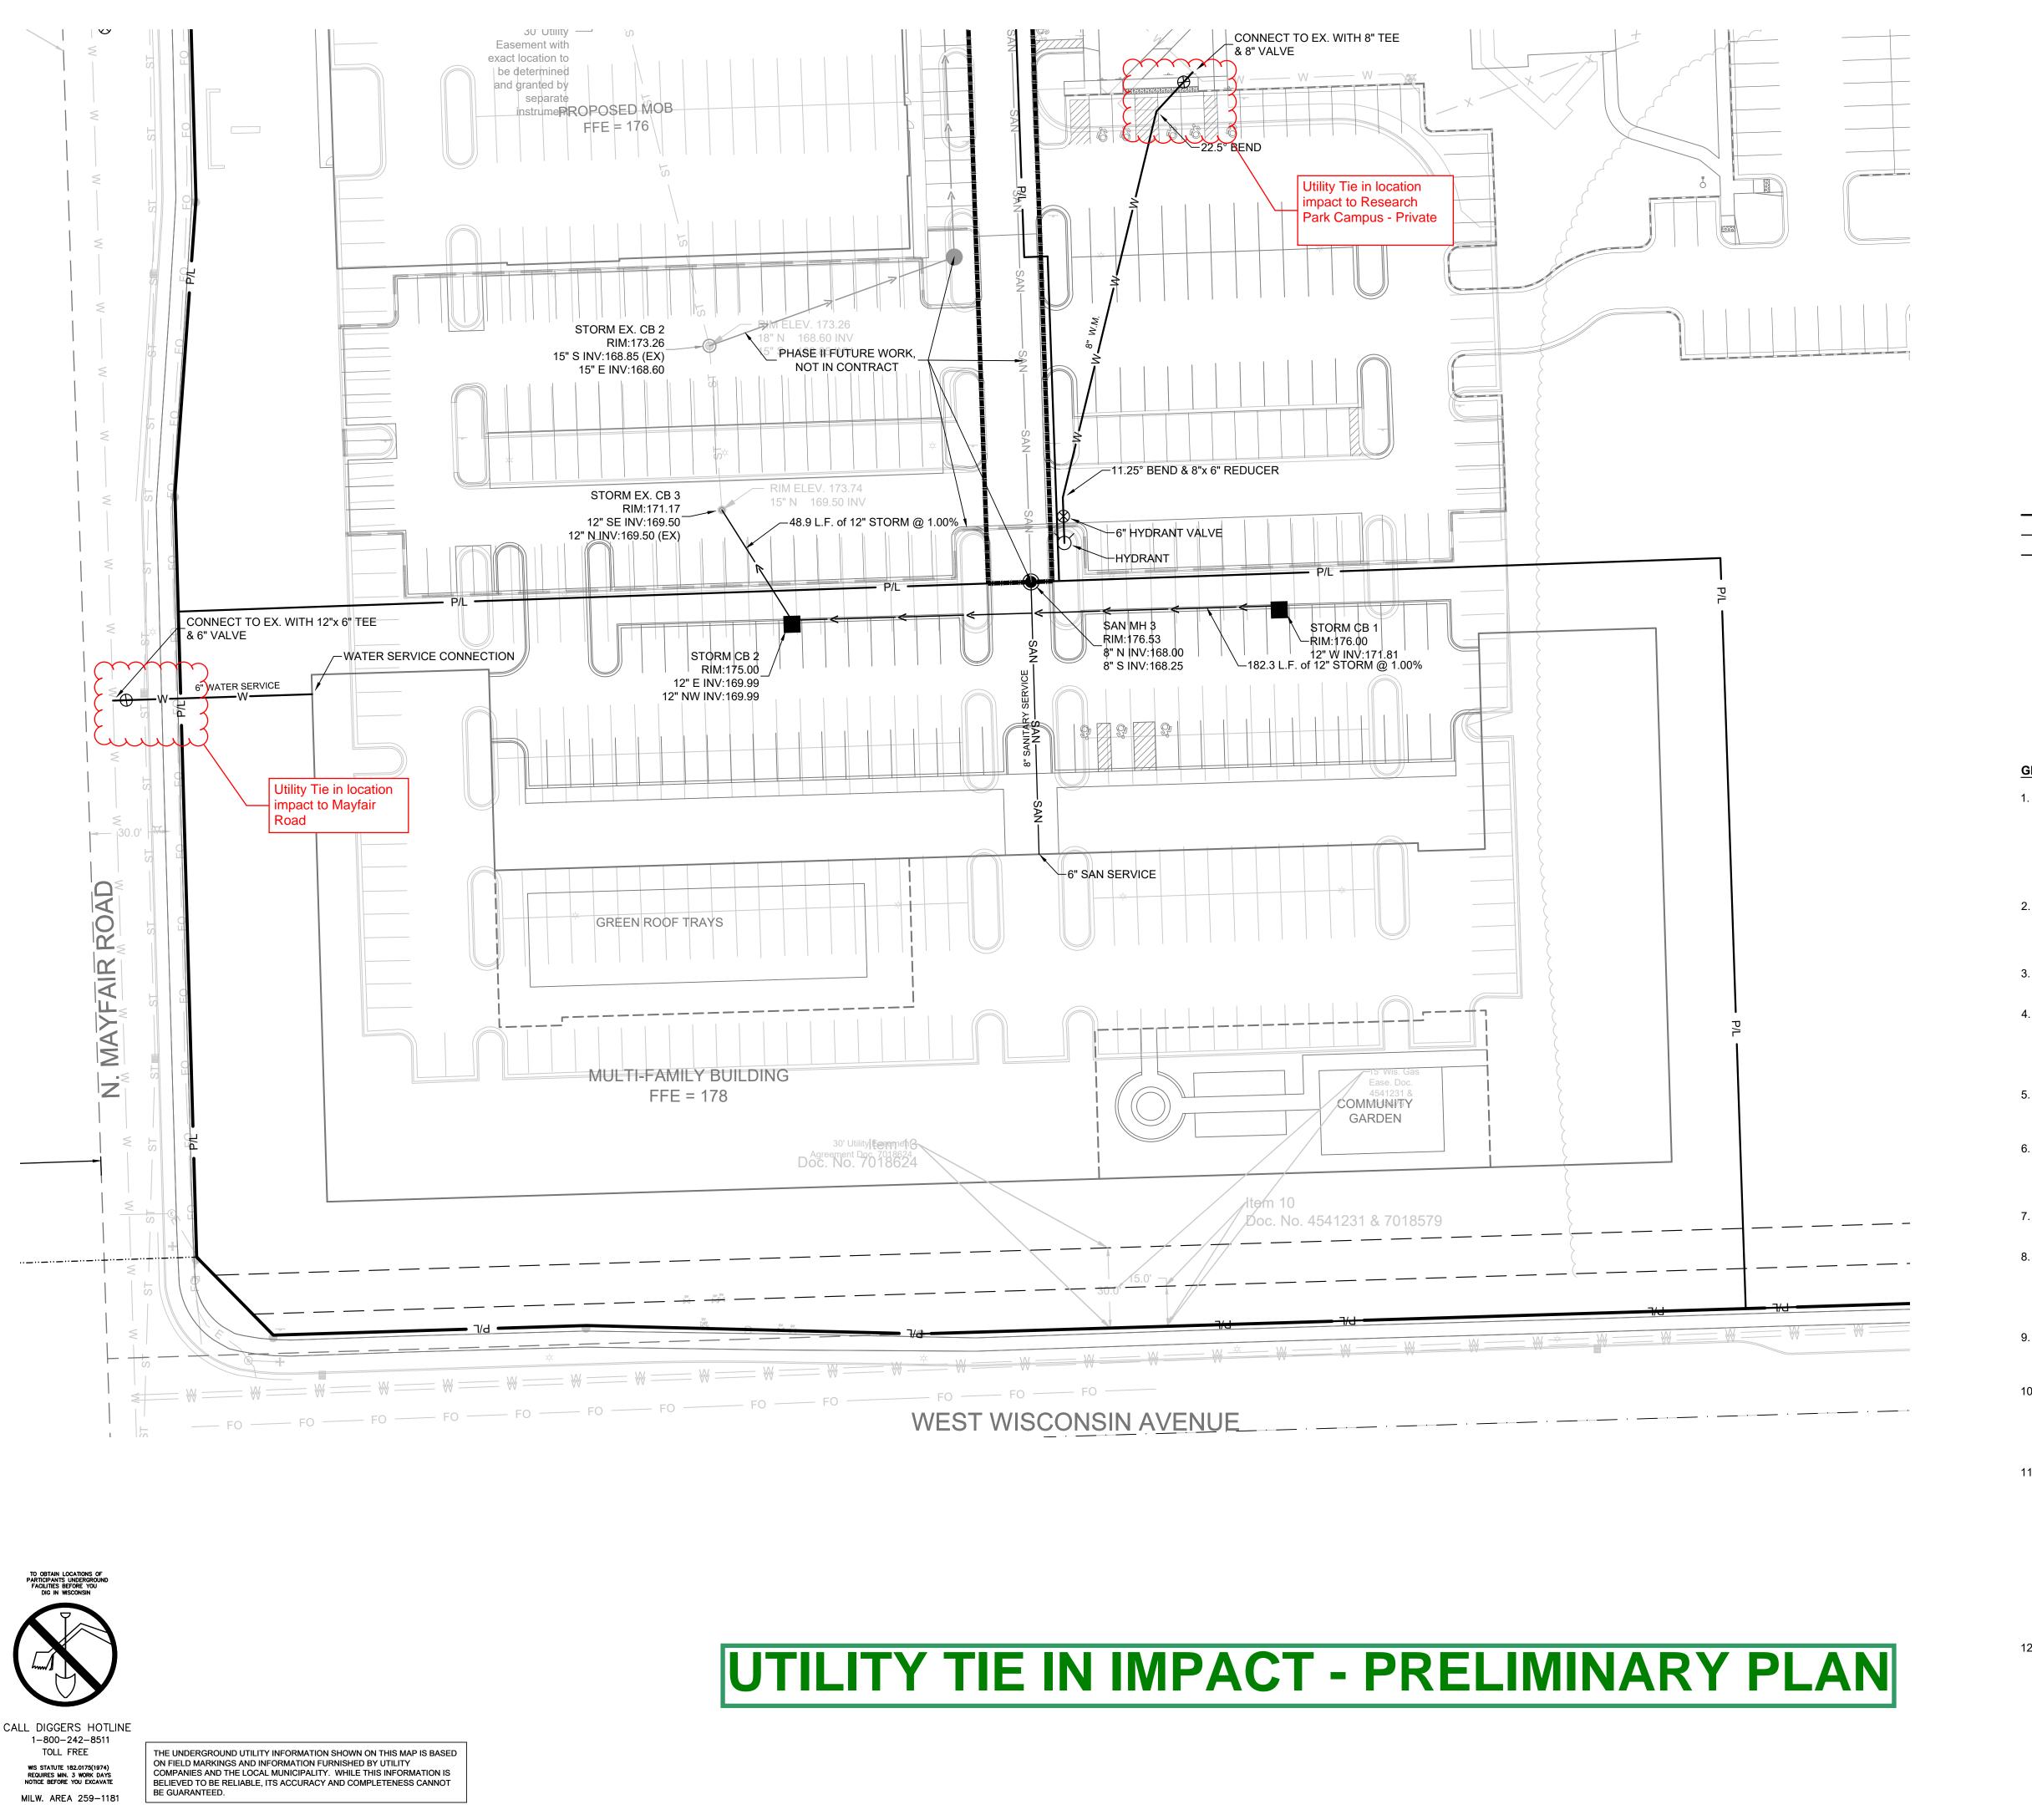

Single Source. Sound Solutions. GROU www.thesigmagroup.com
1300 West Canal Street
Milwaukee, WI 53233
Phone: 414-643-4200
Fax: 414-643-4210

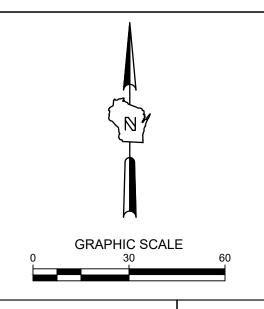

3226

LEGEND:

PROPOSED WATER SERVICE
PROPOSED SANITARY SERVICE
PROPOSED STORM SEWER

A C402 PRO C402 PRO

PROPOSED STORM INLET

B C402 PROPOSED STORM MANHOLE

PROPOSED HYDRANT ASSEMBLY

PROPOSED SANITARY MANHOLE

402

GENERAL NOTES:

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- 2. VERIFY ACTUAL LOCATIONS AND INVERTS IN THE FIELD. ANY POTENTIAL ERRORS, OMISSIONS, OR DISCREPANCIES SHALL BE BROUGHT TO THE ATTENTION OF THE ENGINEER PRIOR TO PROCEEDING WITH CONSTRUCTION.
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- 4. ELECTRONIC CIVIL FILES ARE AVAILABLE UPON WRITTEN REQUEST. DO NOT USE ELECTRONIC CIVIL FILES TO LAYOUT FOUNDATIONS, COLUMN LINES, LIGHT POLES, OR OTHER NON CIVIL SITE WORK. REFER TO ARCHITECTURAL DRAWINGS FOR DIMENSIONS OF BUILDING AND ARCHITECTURAL FEATURES.
- ALL UTILITIES WITHIN 5 FEET OF PAVED AREAS SHALL REQUIRE
 GRANULAR BACKFILL. SLURRY BACKFILL IS REQUIRED FOR ALL
 WORK IN PUBLIC RIGHT OF WAY.
- PRIVATE STORM INLETS IN PAVEMENT SHALL REQUIRE DRAIN TILE STUBS OF 10 FEET IN TWO DIRECTIONS FOR SUBDRAINAGE. RIM GRADE FOR STORM INLETS IN CURB AND GUTTER ARE FLOW LINE GRADES.
- WORK IN PUBLIC RIGHT OF WAY SHALL FOLLOW MATERIAL AND INSTALLATION REQUIREMENTS PER MUNICIPAL AND/OR COUNTY.
- 8. PRIVATE STORM SEWER 12-INCH DIAMETER OR LARGER SHALL BE HDPE. BELOW 12-INCH DIAMETER SHALL BE PVC SDR-35 ASTM D3034. PRIVATE WATER MAIN SHALL BE CLASS 235 DR 18 PVC CONFORMING TO AWWA C-900. PRIVATE SANITARY SEWER SHALL BE PVC SDR-35 ASTM D3034.
- 9. COORDINATE FINAL LOCATION AND DESIGN OF PRIVATE UTILITY SERVICES (ELECTRIC, GAS, PHONE, CABLE) WITH UTILITY COMPANIES.
- 10. IF PROJECT IS DESIGN BUILD MEP, THE GENERAL CONTRACTOR IS REQUIRED TO PROVIDE FINAL SEWER AND WATER DESIGN SHOWING LOCATION, INVERTS AND SIZES TO THE ENGINEER FOR FINAL REVIEW AND VERIFICATION PRIOR TO STARTING UNDERGROUND UTILITY CONSTRUCTION.
- 11. WATER MAIN CONNECTION: TAP WATER MAIN WITH SIZE AND LOCATION INDICATED ON PLAN IN ACCORDANCE WITH LOCAL WATER UTILITY REQUIREMENTS. COORDINATE CONNECTION WITH LOCAL WATER UTILITY. ALL JOINTS HALL BE RESTRAINED FROM CONNECTION OF WATER MAIN TO BUILDING WALL. SUBMIT JOINT RESTRAINT DETAILS FOR ALL JOINT TYPES INCLUDING PUSH-ON AND MECHANICAL CONNECTIONS. INSTALL MEGA-LUG OR APPROVED EQUAL TIGHT TO WALL FOR RESTRAINT FOR ALL BUILDING WALL PENETRATIONS AS APPROVED BY LOCAL PLUMBING INSPECTOR AND WATER UTILITY. INSTALL THRUST BLOCKING AND MEGA-LUG AT BEND BELOW FLOOR FOR ALL FLOOR PENETRATIONS.
- 12. INSTALL JOINT RESTRAINT AND CONCRETE THRUST BLOCKS AT ALL OFFSET FITTINGS (TEES, BENDS, DEAD ENDS, VALVES, REDUCERS) USING MEGA-LUG OR APPROVED EQUAL. CONCRETE THRUST BLOCKS SHALL BE INSTALLED PER FILE NO'S:44,45,46 FROM THE STANDARD SPECIFICATIONS FOR SEWER AND WATER CONSTRUCTION IN WISCONSIN. SEE DETAIL FOR MINIMUM LENGTH OF RESTRAINED JOINT REQUIRED. SUBMIT JOINT RESTRAINT DETAILS FOR ALL JOINT TYPES INCLUDING PUSH-ON AND MECHANICAL CONNECTIONS.

RESEARCH DRIVE PHASE III 10701 REASERACH DRIVE

ISSUANCE DATE

NO. REVISION DATE

SCALE: 1"=30'

PROJECT NO: 20116

DESIGN DATE: ---PLOT DATE: 2023.02.22

DRAWN BY: CMM

CHECKED BY: CTC

APPROVED BY: ---SHEET NO:

C300

I:\Irgens Development\20116 - Research Drive Wauwatosa\060 CAD\C - Civil\500 Production - Lot 4 Residential Phase III\030_Production Sheets\100_Civil\C300 Utility Plan.dwg