7725 W. North Avenue Wauwatosa, WI 53213



Wauwatosa, WI Design Review Board Meeting Agenda - Final

Thursday, September 4, 2025 7:00 PM Committee Room #1

CALL TO ORDER

ROLL CALL

NEW BUSINESS

1.	2500 N Mayfair Rd - Scheels - Exterior Renovations - Return to Board	<u>25-1188</u>
2.	10300 Wisconsin Avenue – Moss Universal Park	<u>25-1335</u>
3.	7300 Chestnut – Wauwatosa Veterans Memorial Plaza	25-1336

ADJOURNMENT

NOTICE TO PERSONS WITH A DISABILITY

Persons with a disability who need assistance to participate in this meeting should call the City Clerk's office at (414) 479-8917 or send an email to tclerk@wauwatosa.net, with as much advance notice as possible.




Wauwatosa, WI Staff Report


7725 W. North Avenue Wauwatosa, WI 53213

File #: 25-1188 **Agenda Date:** 9/4/2025 **Agenda #:** 1.

2500 N Mayfair Rd - Scheels - Exterior Renovations - Return to Board



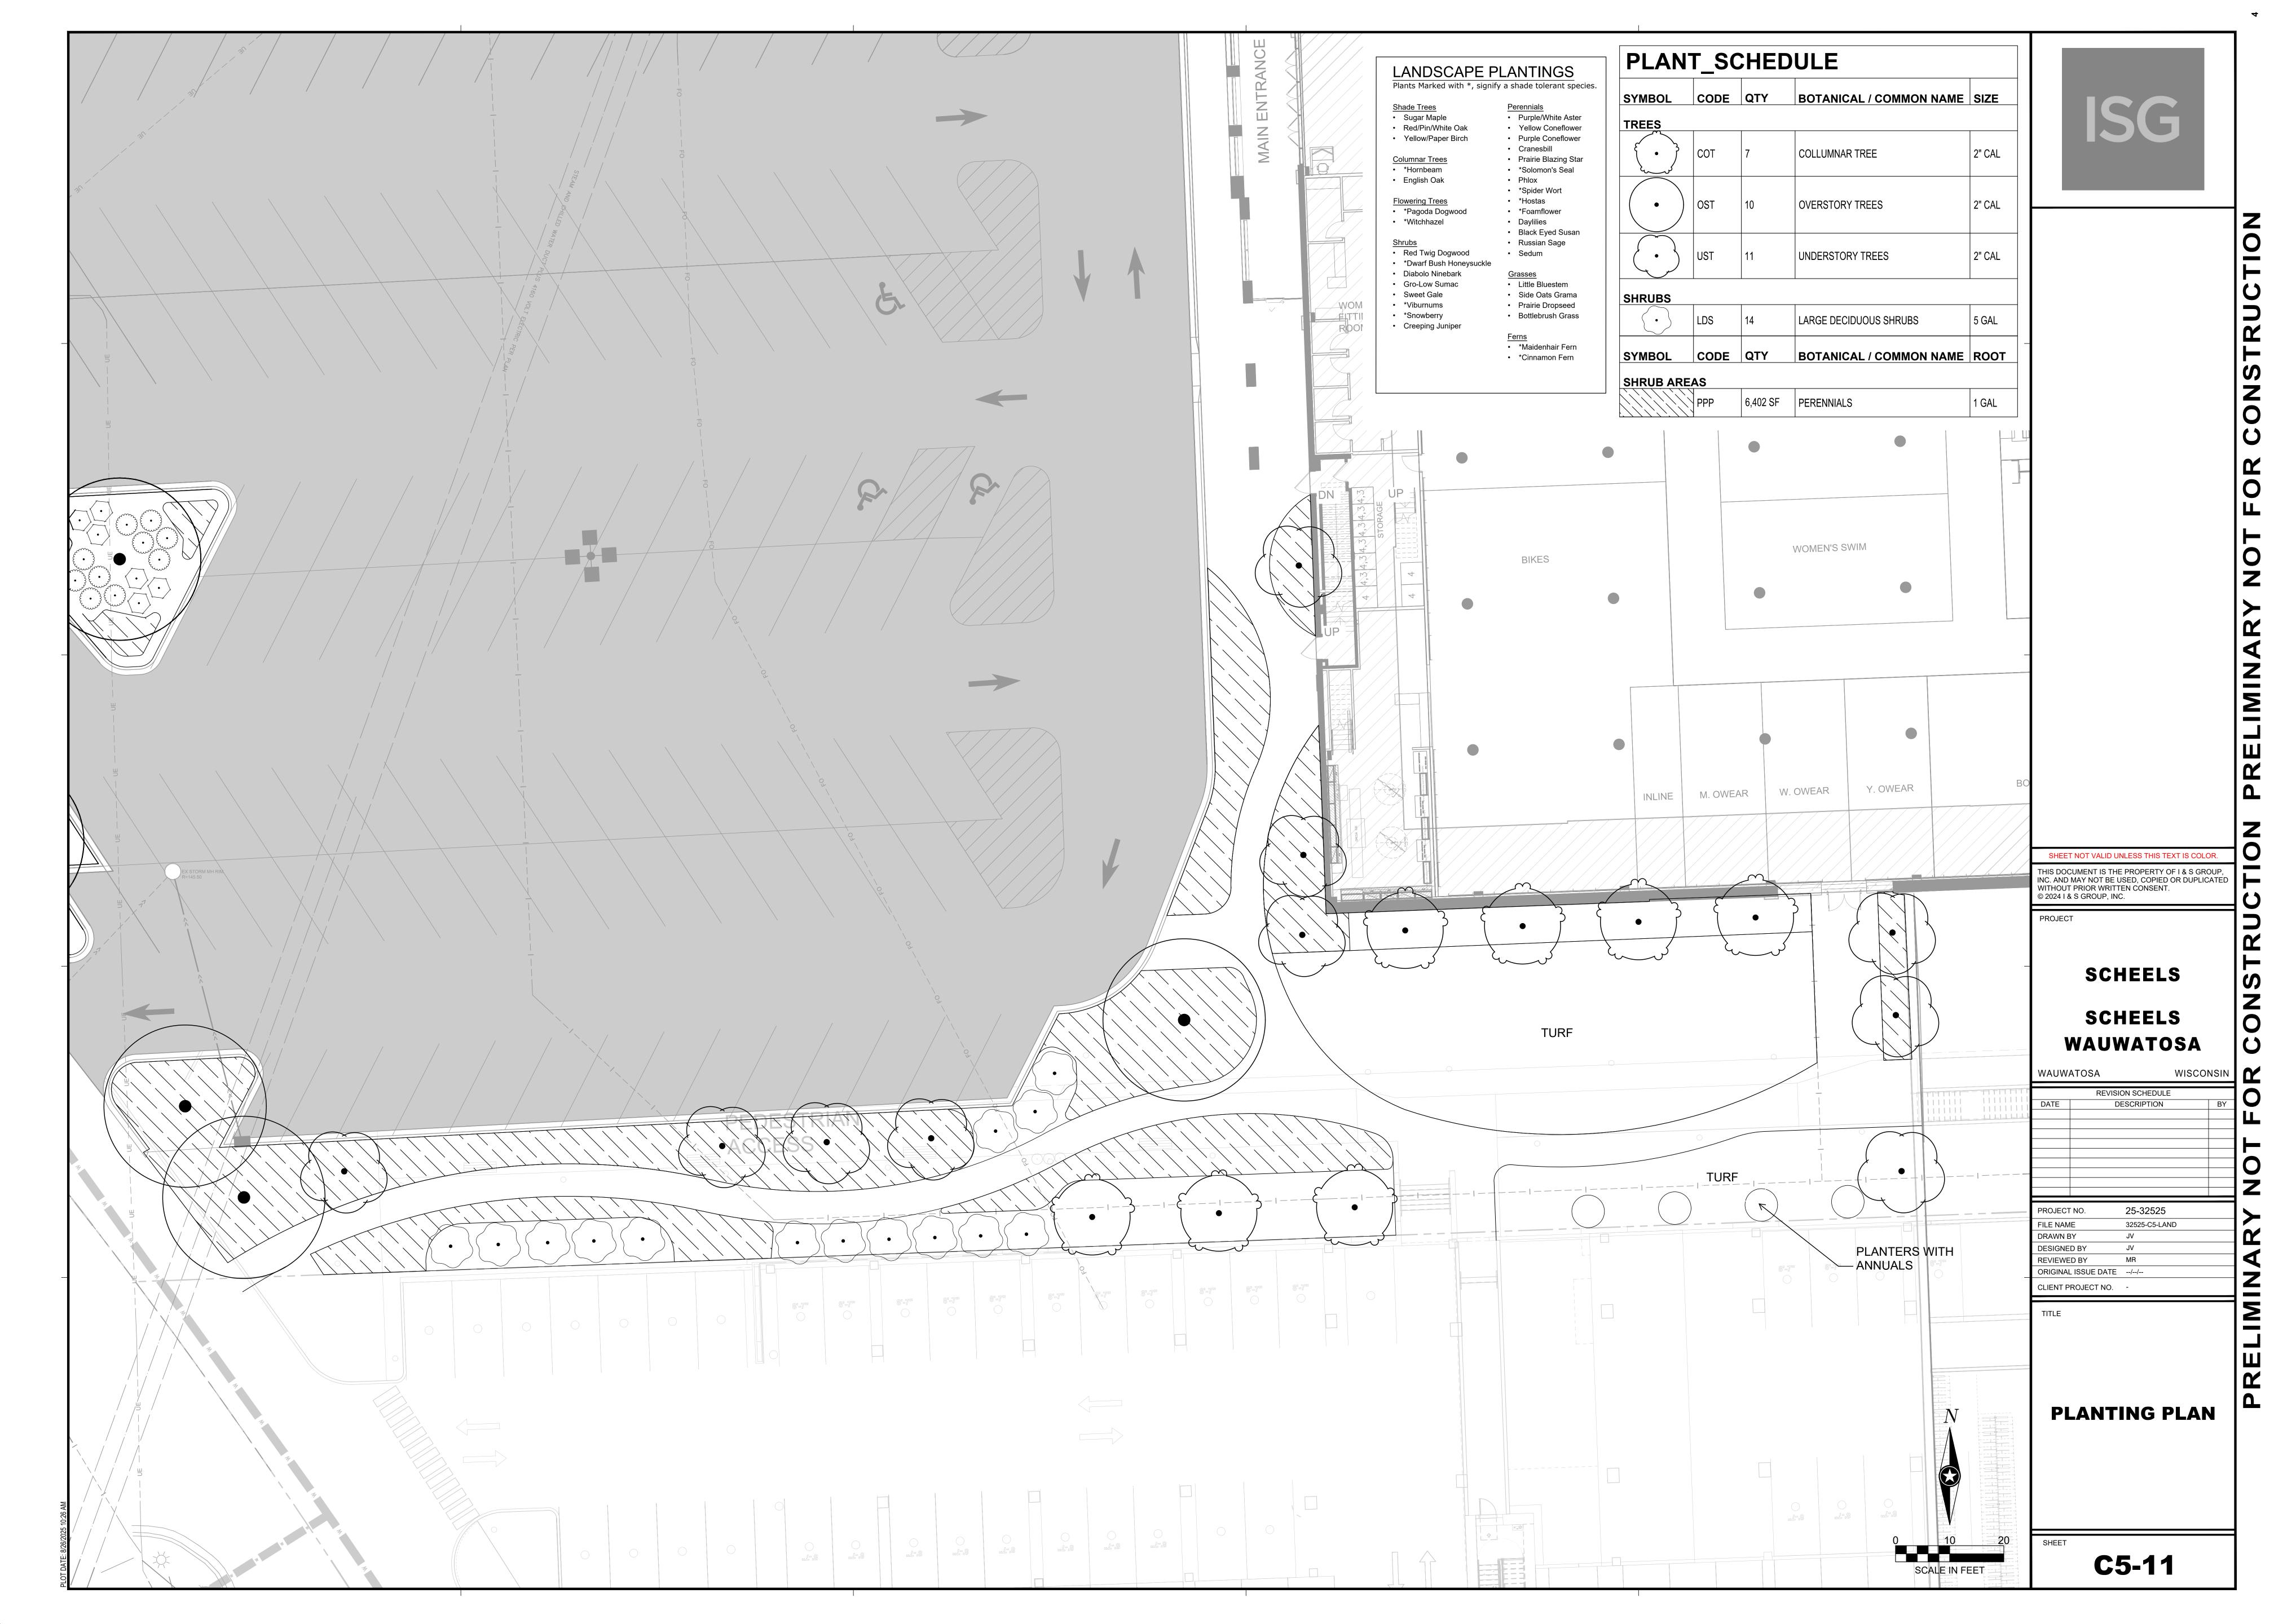

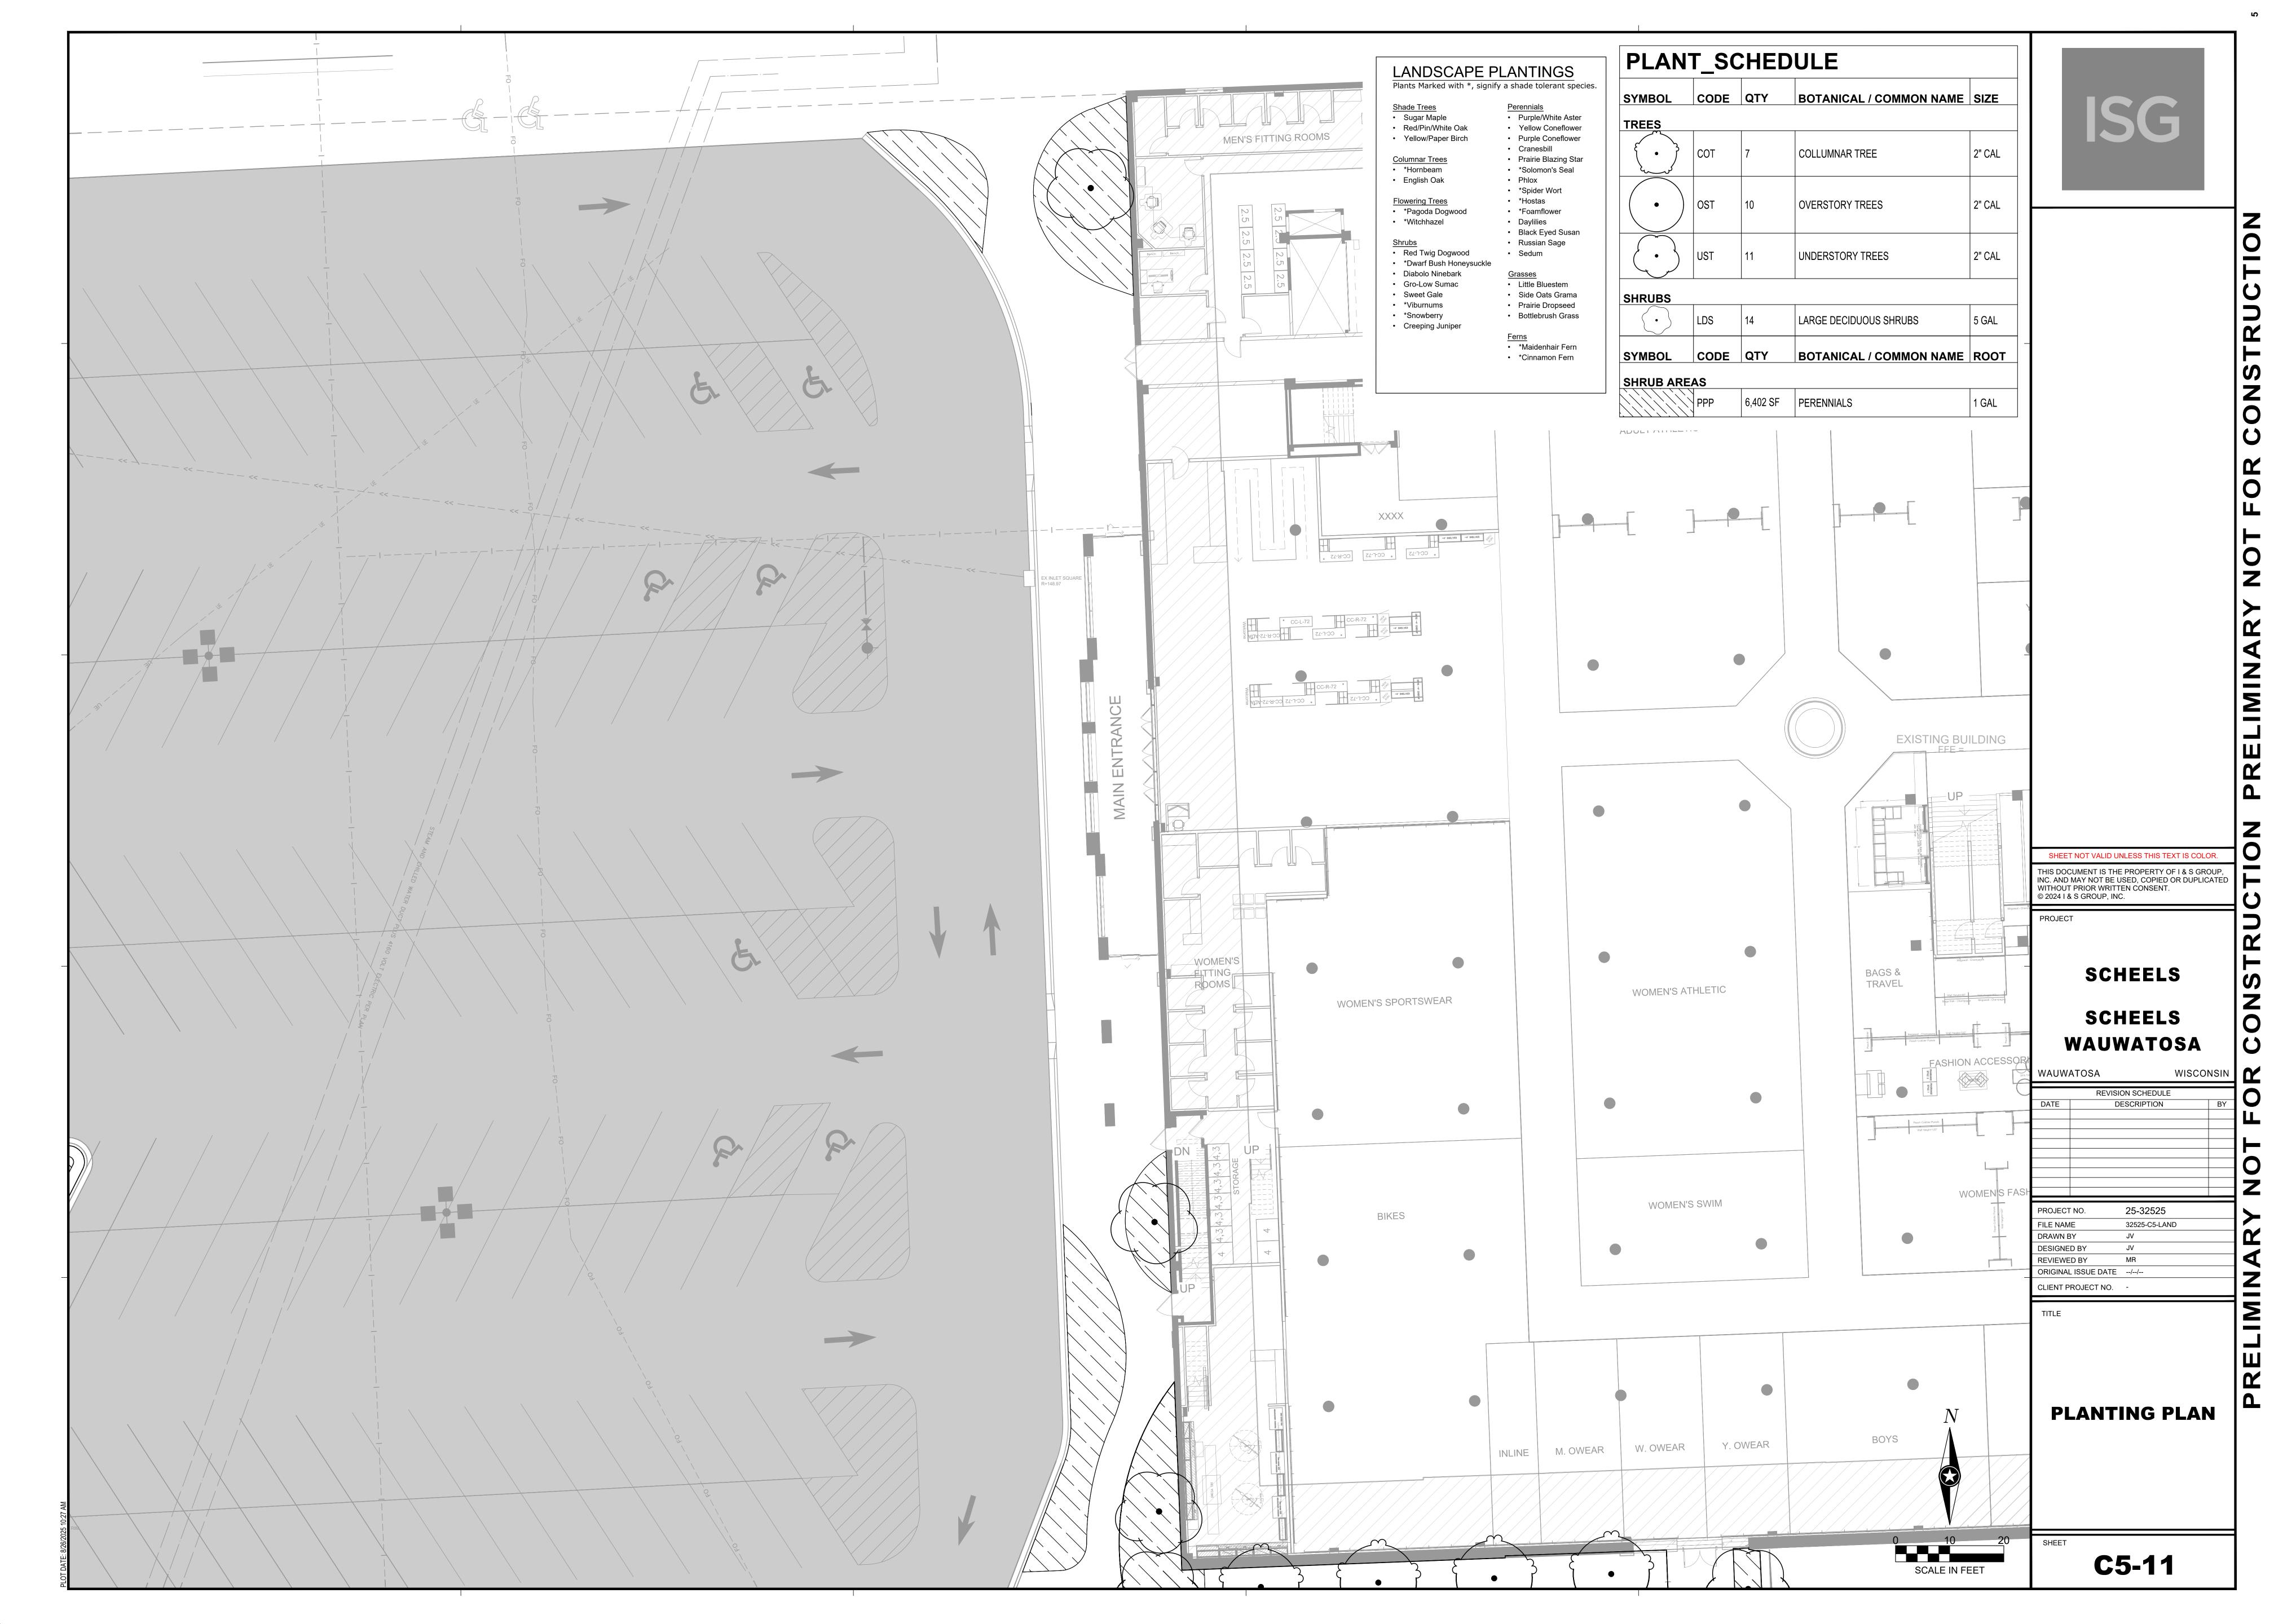



Wauwatosa, WI Staff Report

7725 W. North Avenue Wauwatosa, WI 53213

File #: 25-1335 **Agenda Date:** 9/4/2025 **Agenda #:** 2.

10300 Wisconsin Avenue - Moss Universal Park

MOSS UNIVERSAL PARK PAVILION

WAUWATOSA DESIGN REVIEW BOARD





Kahler Slater raSmith

09/04/2025



Giving everybody the opportunity to play TOGETHER.














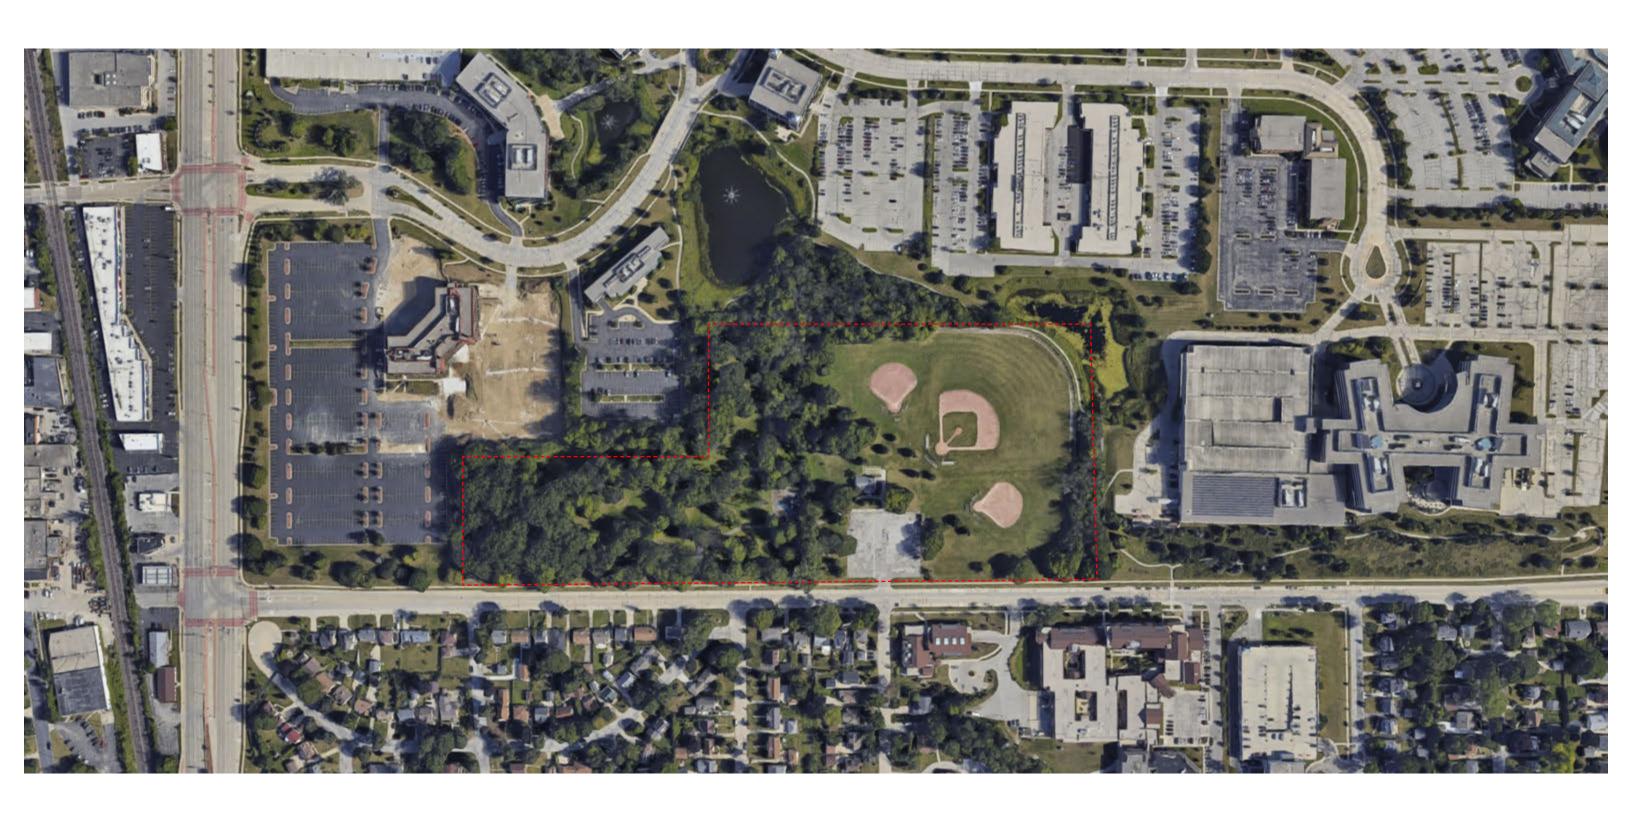












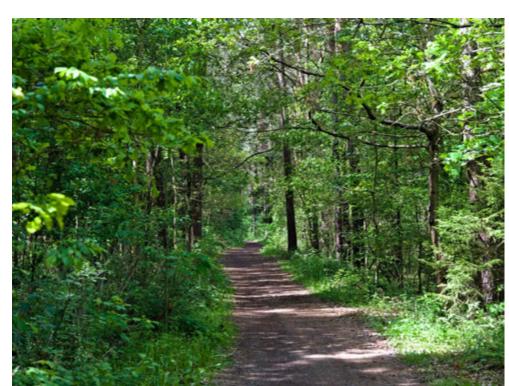












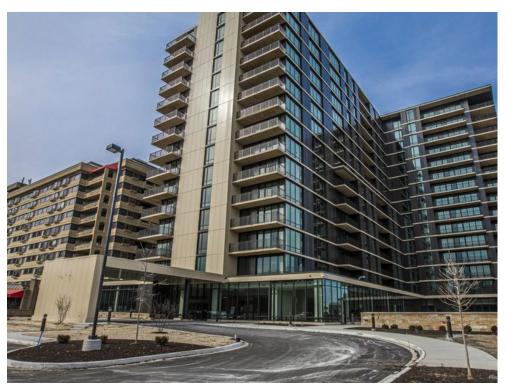




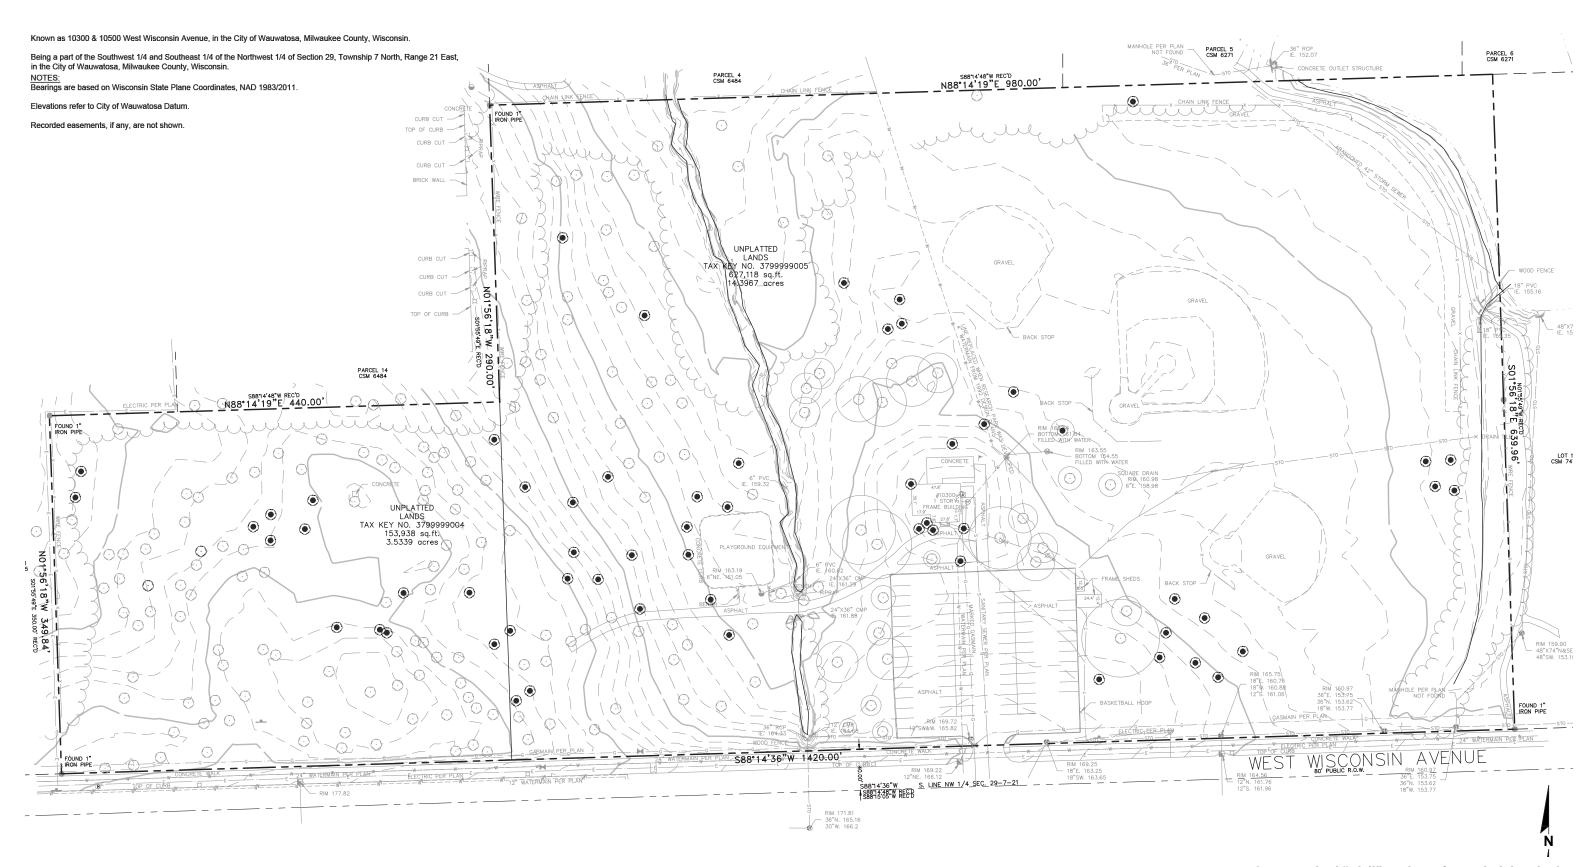

(see attached "Civil" package for scaled drawing)

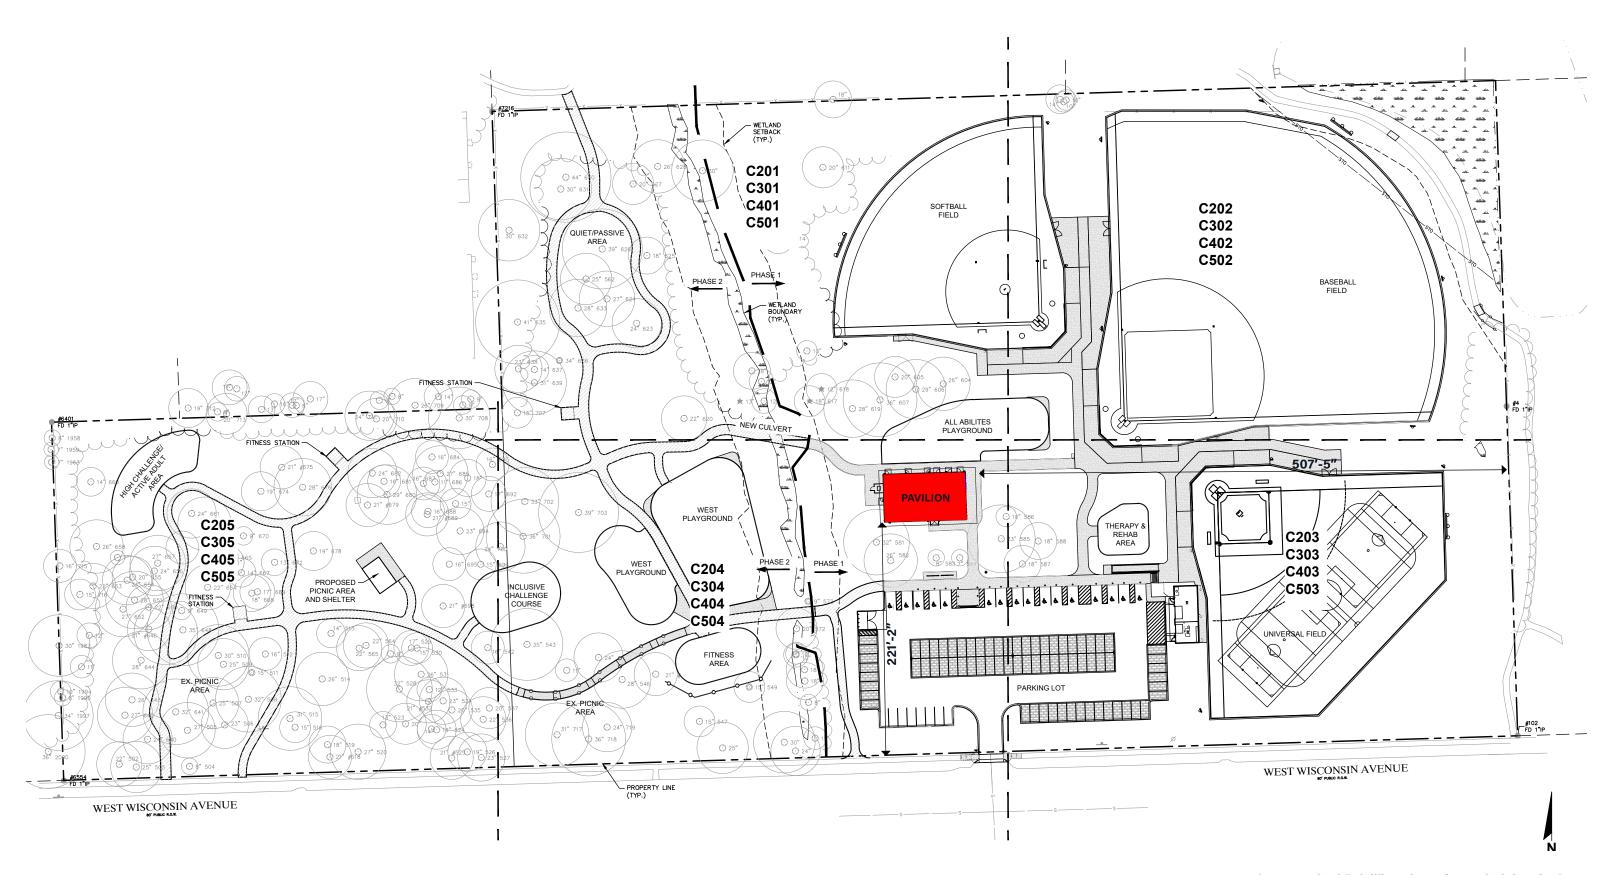

(see attached "Civil" package for scaled drawing)

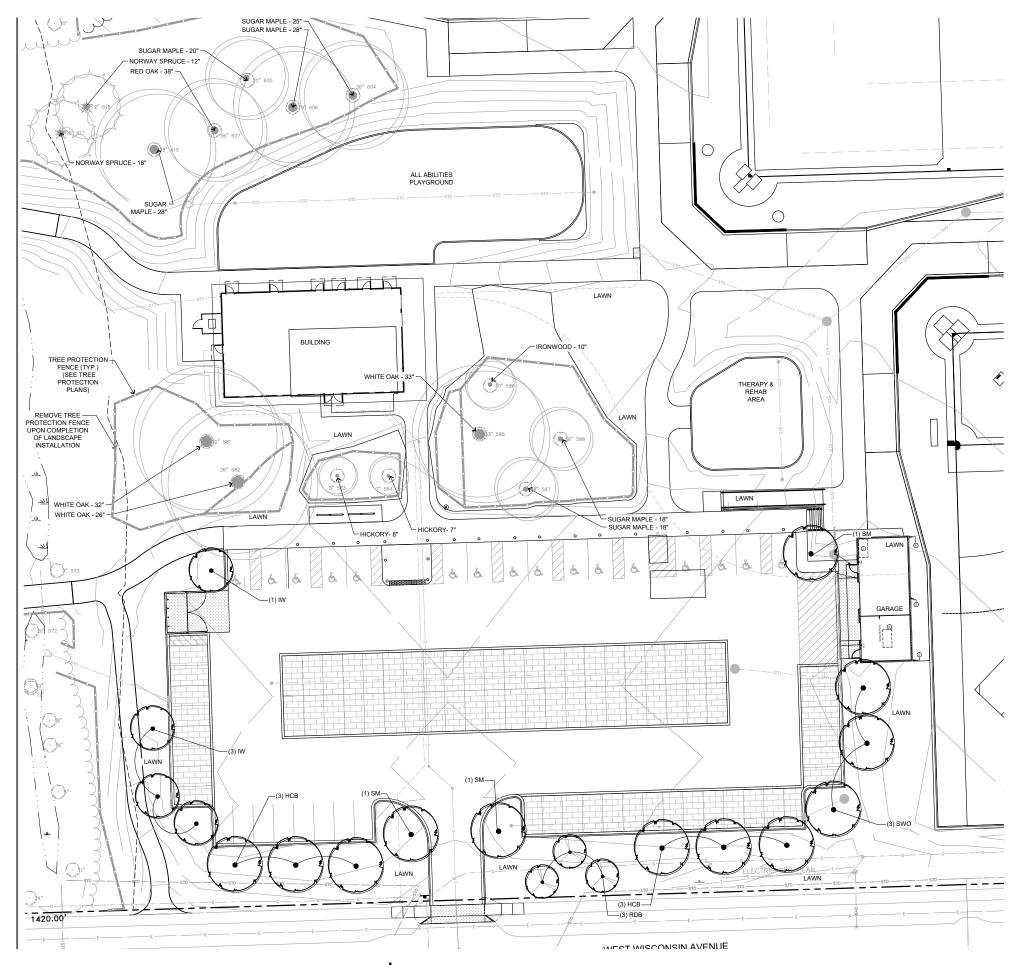

Title 24 - ZONING

Chapter 24.12 LANDSCAPING AND SCREENING

Wauwatosa, Wisconsin, Code of Ordinances Created: 2023-06-07 12:48:08 [EST]

(Supp. No. 80)

Chapter 24.12 LANDSCAPING AND SCREENING

24.12.020 Perimeter Vehicular Use Area Landscaping

A landscape strip with a minimum depth of 10 feet must be provided between the vehicular use area and the public right-of-way. This perimeter vehicular use area must include at least 2 deciduous trees and 8 shrubs per 50 feet of vehicular use area frontage.

West Wisconsin Ave. Vehicle Use Area - 127 + 73 = 200 LF

4 x 8 = 32 shrubs

PROVIDED: 8 deciduous trees

24.12.030 Interior Vehicular Use Area Landscaping.

Minimum Interior Landscape Area. At least 10% of the interior of vehicular use areas must be landscaped.

Vehicle Use Area = 35,930 SF

REQUIRED: 35,930 x 10% = 3,593 SF

PROVIDED: 1,406 SF

Shade trees must be provided in interior landscape islands at a minimum rate of one tree per 180 square feet of required interior landscape area

Required Interior landscape Area = 3.593 SF REQUIRED: 3,593 / 180 = 20 Shade trees PROVIDED: 10 Proposed Shade trees

NOTE: Milwaukee County Parks will be seeking a variance to the interior landscape requirements, greenspace and shrub plantings for the parking lot.


PLANT SCHEDULE PARKING LOT

CODE	QTY	COMMON NAME	BOTANICAL NAME	INSTALLED SIZE	ROOT	SPACING	MATURE SIZE
SHADE	TREES	3					
SM	3	Sugar Maple	Acer saccharum	2" CAL	B&B	Full, matching heads	60' x 45'
HCB	6	Common Hackberry	Celtis occidentalis	2" CAL	B&B	Full, matching heads	50' x 50'
IW	4	Ironwood	Ostrya virginiana	2" CAL	B&B	Full, matching heads	25' x 15'
SWO	3	Swamp White Oak	Quercus bicolor	2" CAL	B&B	Full, matching heads	75' x 65'
ORNA	MENTAL	TREES					
RDB	3	Eastern Redbud	Cercis canadensis	2" CAL	B&B	Full, matching heads. Northern grown	25` x 30`


Proposed trees : 38 caliper inches Removed Trees = 783 caliper inches

NOTES: - Milwaukee County Parks requires using native trees and shrub species (no cultivars)


- Top-dress and seed all lawn areas disturbed due to construction

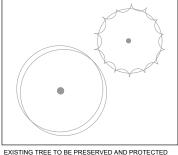



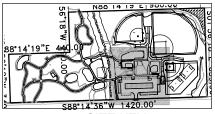


SITE KEY

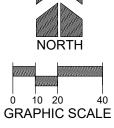


Call before you dig.


PLEASE CONTACT BLAKE PRUSAK AT (414) 258-2322 PLEASE CONTACT BLAKE PRUSAK AT (414) 258-2322


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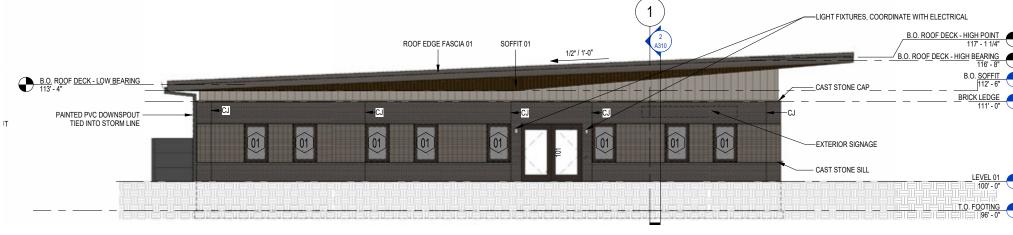


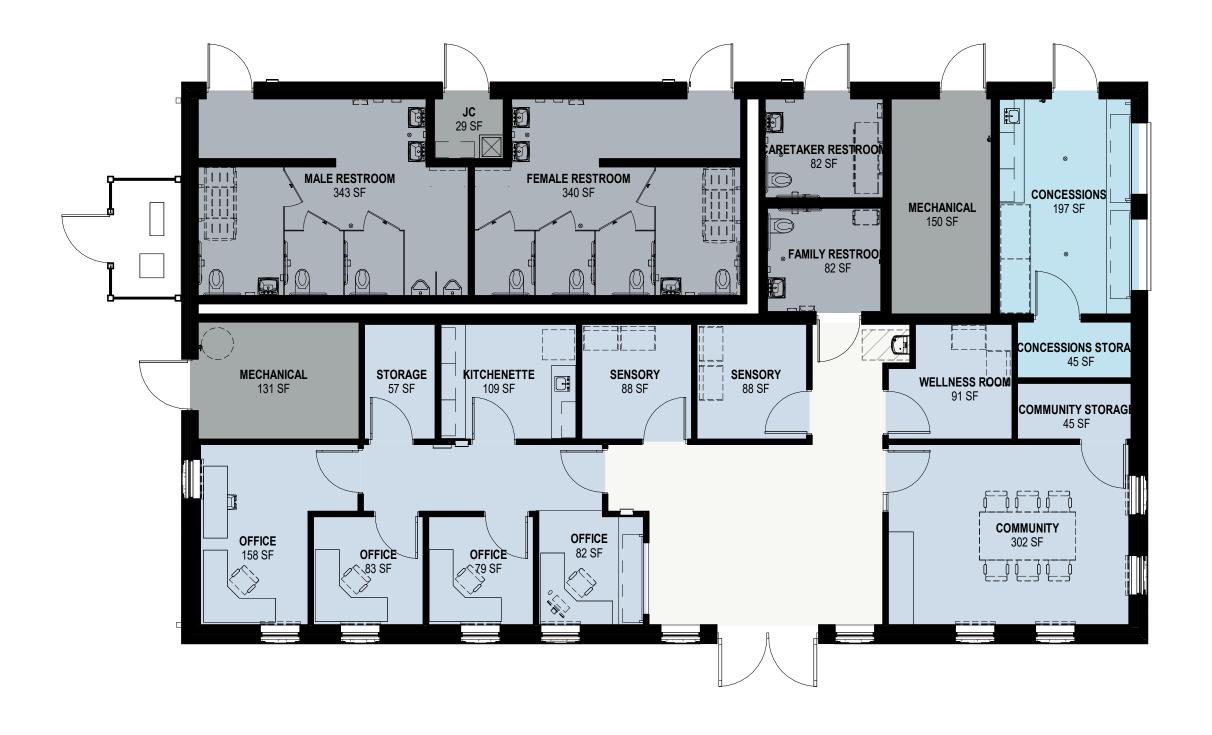

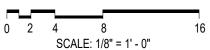



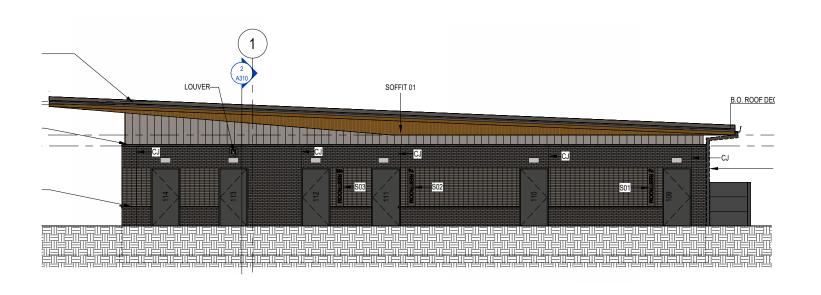

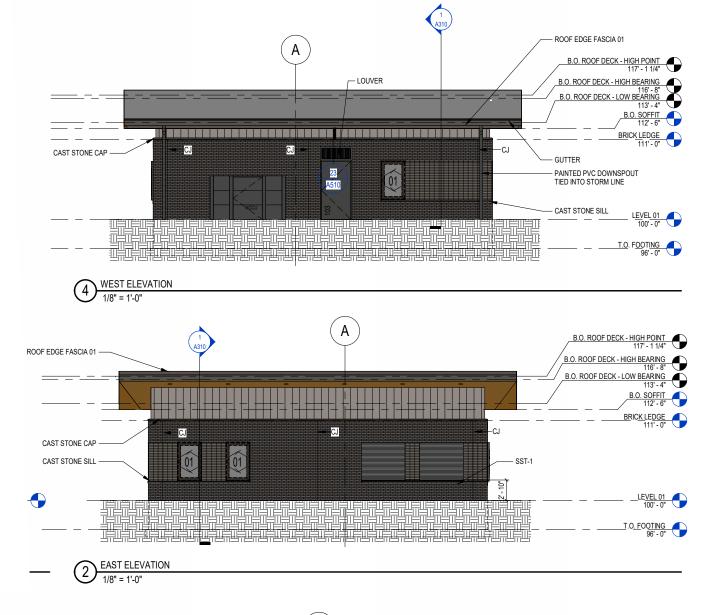








RampUp Universal Community





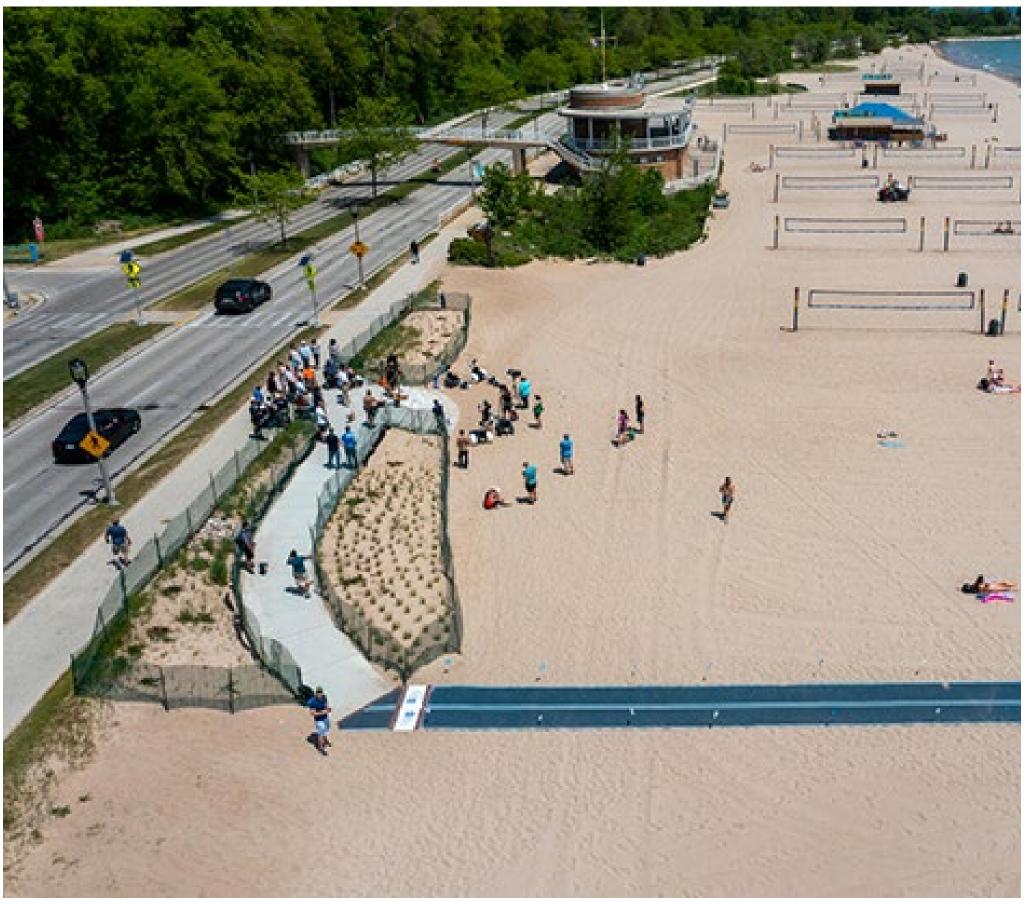










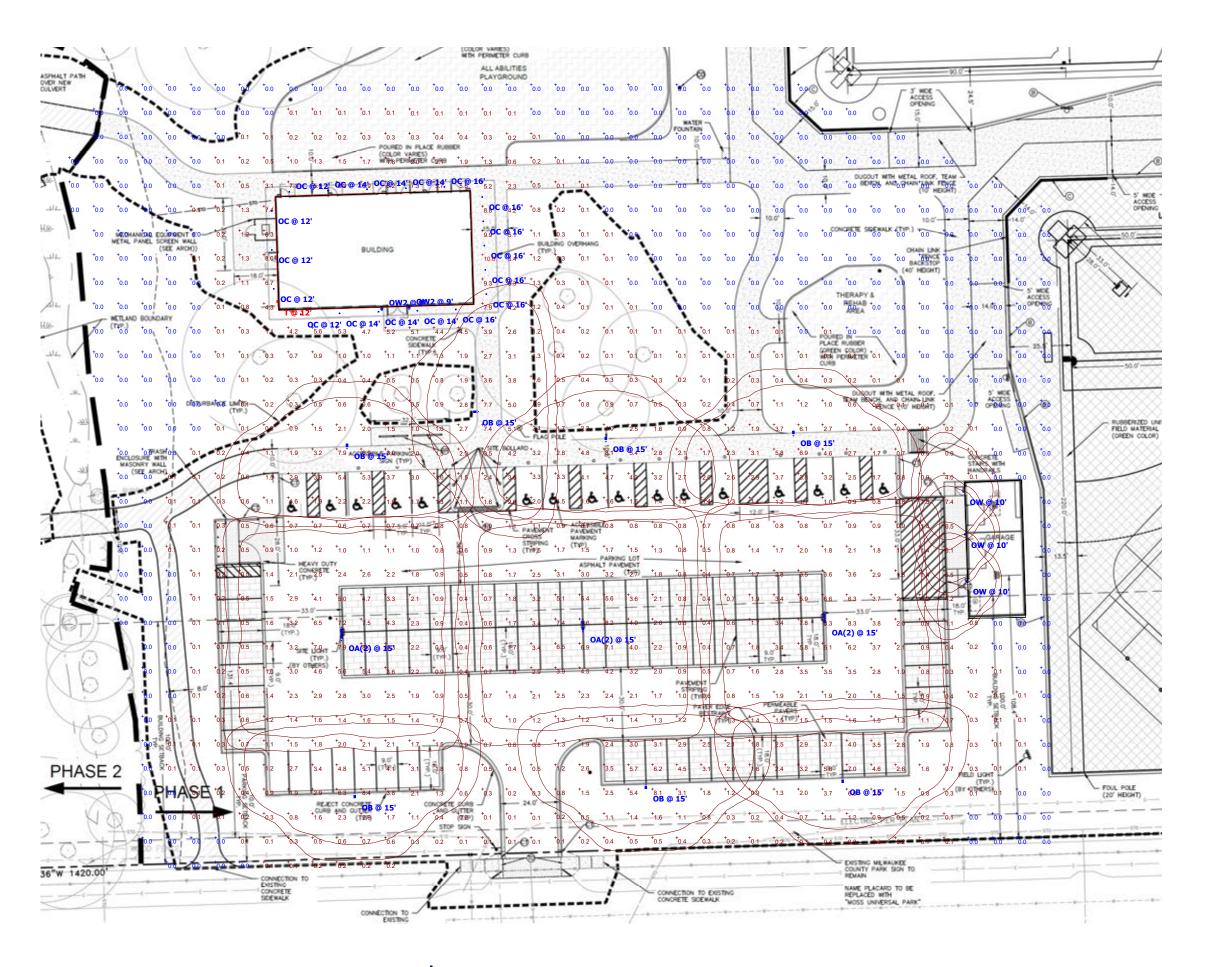






E4WH - 4W Emergency Battery Backup

D = 5.5"


H = 8"

W = 9"




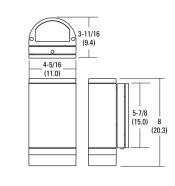



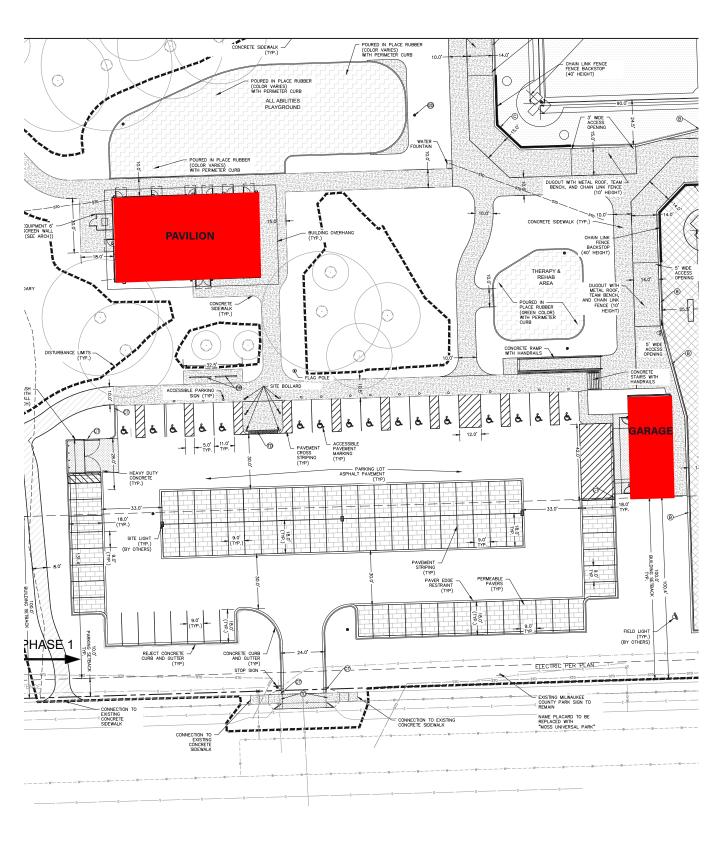



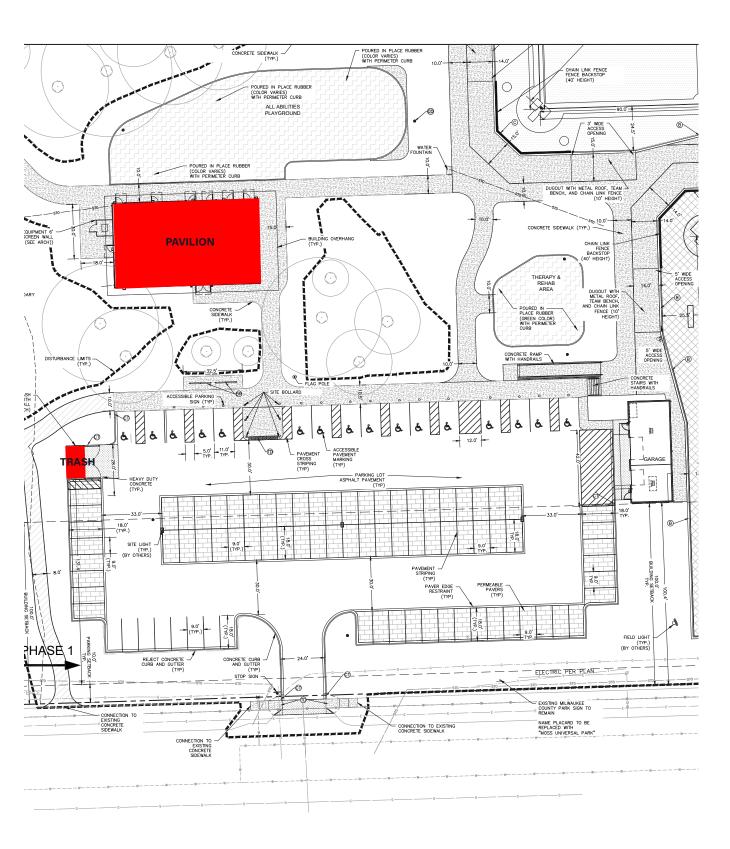







Wauwatosa, WI Staff Report


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File #: 25-1336 **Agenda Date:** 9/4/2025 **Agenda #:** 3.

7300 Chestnut - Wauwatosa Veterans Memorial Plaza

Project Sheet Legend:

LGD0.1	LEGEND SHEET
AGL0.2	ACCESSIBILITY SHEET
SD1.1	PROPOSED PHASE I SITE PLAN
SD1.2	PROPOSED PHASE I GRADING PLAN
SD1.3	PROPOSED PHASE I PLAZA CROSS-SECTION AND DETAILS
SD1.4	PROPOSED PHASE I HARDSCAPE MATERIALS
SD1.5	PROPOSED PHASE II & III HARDSCAPE MATERIALS
LSP1.1	PROPOSED PHASE I LANDSCAPE PLAN
LSP1.2	PROPOSED LANDSCAPE DETAILS
LSP1.3	PROPOSED PHASE II & III LANDSCAPE PLAN
LGT1.1	PROPOSED PHASE I & II LIGHTING PLAN
LGT1.2	PROPOSED PROJECT LIGHT FIXTURES
LGT1.3	PROPOSED PROJECT LIGHT FIXTURES
	STREET 66'

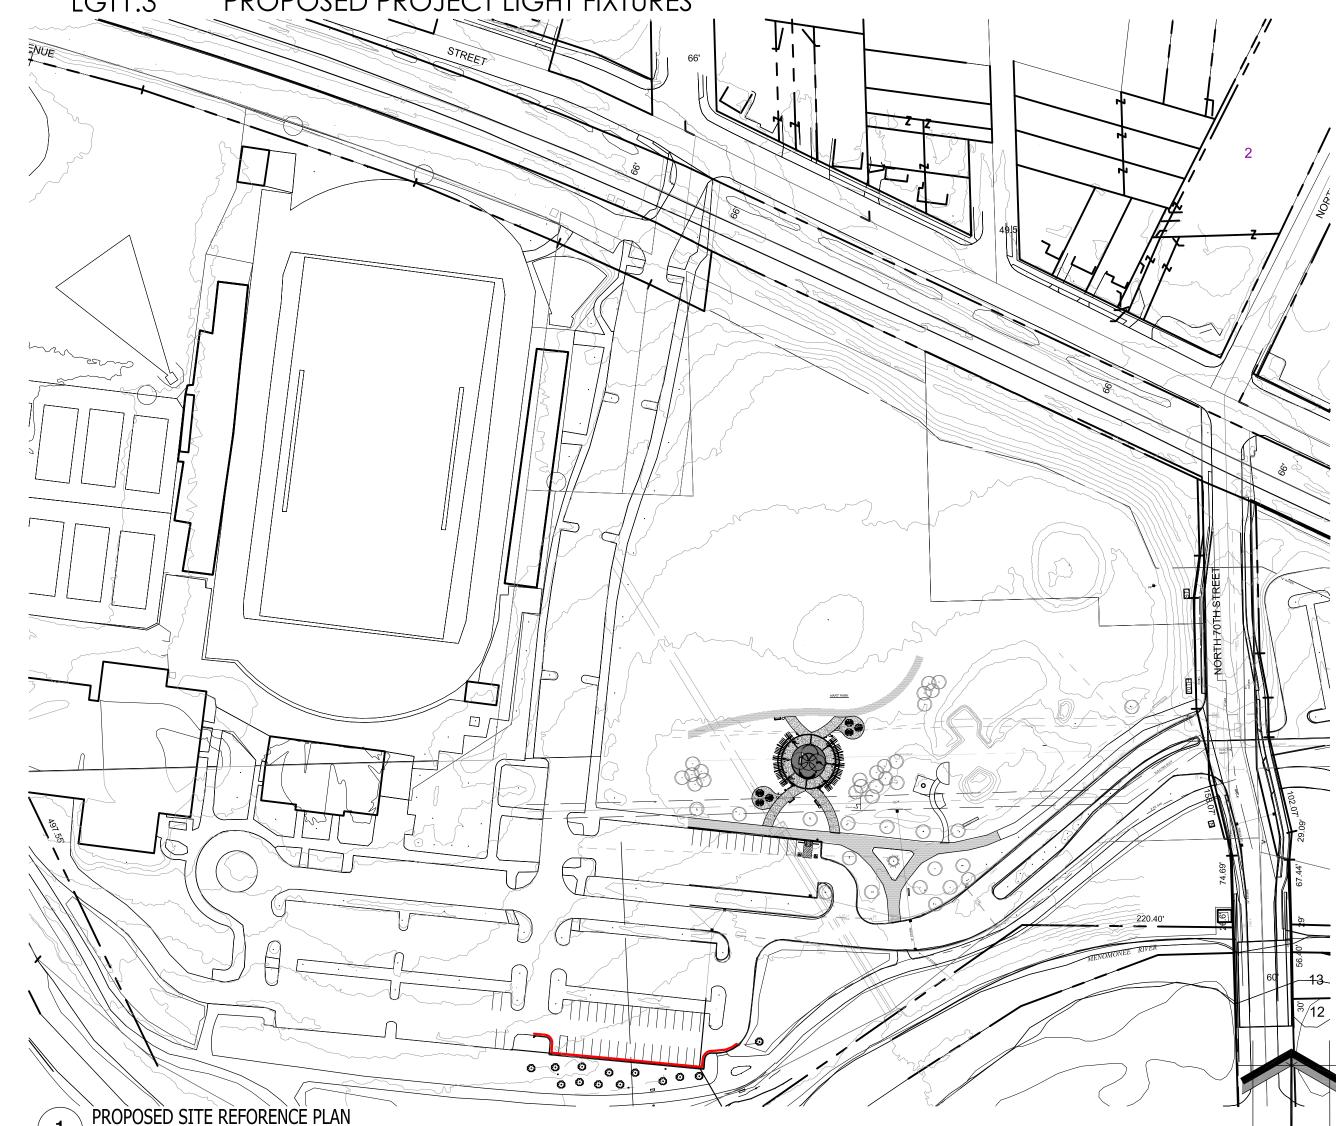

GENERAL SITE NOTES:

- 1. ALL PAVING RADII SHALL BE 5'-0" UNLESS NOTED OTHERWISE.
- 2. PROVIDE CONCRETE SIDEWALKS AS INDICATED ON PLAN.
- 3. UTILITY DESIGN AND WORK BY DESIGN / BUILD CONTRACTOR.
- 4. GRADING AT ACCESSIBLE ROUTE TO COMPLY WITH COMM. CH. 69 DESIGN GUIDELINES.
- 5. FINISHED FLOOR ELEVATION = 100'-0" ON ARCHITECTURAL DRAWINGS VERIFY ACTUAL ELEVATION WITH DESIGN / BUILD CONTRACTOR
- 6. SITE ENGINEERING (ELECTRICAL, STORM WATER DRAINAGE, ETC.) BY DESIGN / BUILD CONTRACTOR.
- 7. ALL PROPERTY LINE BEARINGS AND LENGTHS BASED ON OWNER PROVIDED DATA.
- VERIFY EXACT PLAZA PLACEMENT WITH DESIGN / BUILD CONTRACTOR.
- 9. CONSTRUCTION SITE EROSION AND SEDIMENTATION CONTROL SHALL COMPLY WITH THE REQUIREMENTS OF THE CITY OF WAUWATOSA AND SHALL EMPLOY EROSION CONTROL METHODS AS SHOWN AND SPECIFIED IN THE DEPARTMENT OF NATURAL RESOURCES WISCONSIN CONSTRUCTION SITE BEST MANAGEMENT PRACTICES HANDBOOK (BMP
- MANDEROSTON CONTROL MEASURES SHALL BE ADJUSTED TO MEET FIELD CONDITIONS AT THE TIME OF CONSTRUCTION AND SHALL BE INSTALLED PRIOR TO ANY GRADING OR DISTURBANCE OF EXISTING SURFACE MATERIAL ON THE SITE.
- 11. PERIODIC INSPECTION AND MAINTENANCE OF ALL EROSION CONTROL STRUCTURES SHALL BE PROVIDED TO INSURE INTENDED PURPOSE IS ACCOMPLISHED. CONTRACTOR SHALL BE RESPONSIBLE FOR CLEANUP AND REMOVAL OF ALL SEDIMENT LEAVING PROPERTY. EROSION CONTROL MEASURES SHALL BE IN WORKING CONDITION AT END OF EACH WORK
- 12. SAY FENCE SHALL BE INSTALLED IN ALL LOCATIONS WHERE POTENTIAL RUNOFF AND CONTAMINATION MAY OCCUR. 13. EROSION CONTROL MEASURES SHALL BE MAINTAINED ON A CONTINUING BASIS UNTIL SITE IS FULLY STABILIZED.
- 14. ALL EROSION AND SEDIMENT CONTROL PRACTICES TO BE CHECKED FOR STABILITY AND OPERATION FOLLOWING EVERY RUNOFF-PRODUCTION RAINFALL EVENT. ANY NEEDED REPAIRS REPAIRS SHALL SHALL BE MADE IMMEDIATELY TO MAINTAIN ALL PROTECTION AS DESIGNED.
- 15. SEDIMENT IS TO BE REMOVED FROM BEHIND THE SEDIMENT FENCE WHEN IT BECOMES .05 FEET DEEP AT THE FENCE. REPAIR THE FENCE AS NECESSARY TO MAINTAIN BARRIER.
- 16. SEE ALL RELATED DETAILS AND REMAINING SHEETS SPECIFICATION FOR ADDITIONAL INFORMATION AND HOW IT RELATES TO THE SCOPE OF THE PROJECT.

EXISTING CONDITIONS GENERAL NOTES

- 1. INFORMATION PERTAINING TO EXISTING CONDITIONS GIVEN ON THESE LANDSCAPE DRAWINGS REPRESENTS TO THE BEST OF OUR KNOWLEDGE THE ACTUAL EXISTING FIELD CONDITIONS. INSITE LANDSCAPE DESIGN, INC. MAKES NO WARRANTY AS TO THEIR ACCURACY. CONTRACTOR TO FIELD VERIFY EXISTING CONDITIONS IMPERATIVE TO THEIR NEW WORK. REPORT ANY DISCREPANCIES BETWEEN THE DRAWINGS AND FIELD CONDITIONS TO THE LANDSCAPE ARCHITECT FOR REVIEW. ANY WORK PERFORMED PRIOR TO RESOLUTION OF DISCREPANCIES BY THE LANDSCAPE ARCHITECT IS SUBJECT TO REMOVAL AND REPLACEMENT AT NO ADDITIONAL COST TO THE CONTRACT.
- THE LOCATIONS OF EXISTING UTILITY INSTALLATIONS AS SHOWN ON THIS PLAN ARE APPROXIMATE. THERE MAY BE UNDERGROUND UTILITY INSTALLATIONS WITHIN THE PROJECT AREA OF DISTURBANCE THAT ARE NOT SHOWN. THE CONTRACTOR SHALL BE RESPONSIBLE FOR VERIFYING THE EXISTENCE AND LOCATION OF ALL UNDERGROUND UTILITIES. VERIFY ALL EXISTING CONDITIONS, DIMENSIONS, AND ALIGNMENT OF WALLS. BRING ANY DISCREPANCIES TO THE LANDSCAPE ARCHITECTS ATTENTION PRIOR TO FABRICATION /
- 4. VERIFY LOCATION OF ACCESS PANELS w/ MECHANICAL AND ELECTRICAL EQUIPMENT FOR ACCESSIBILITY OF MECHANICAL & ELECTRICAL ITEMS. VERIFY LOCATIONS OF ALL BURIED UTILITIES AND STRUCTURES AND LOCATIONS OF ALL OVERHEAD WIRES.
- M VERIFY LOCATION OF ALL EXISTING EASEMENTS. 6. INSITE LANDSCAPE DESIGN, INC, ASSUMES NO RESPONSIBILITY FOR DAMAGES, LIABILITY OR COSTS RESULTING FROM CHANGES OR ALTERATIONS MADE TO THIS PLAN WITHOUT THE EXPRESSED WRITTEN CONSENT OF INSITE LANDSCAPE DESIGN, INC.

SITE DEMOLITION GENERAL NOTES:

- 1. INFORMATION PERTAINING TO EXISTING CONDITIONS GIVEN ON THESE SITE IMPROVEMENT DRAWINGS REPRESENTS TO THE BEST OF OUR KNOWLEDGE THE ACTUAL EXISTING FIELD CONDITIONS. INSITE LANDSCAPE DESIGN, INC. MAKES NO WARRANTY AS TO THEIR ACCURACY. CONTRACTOR TO FIELD VERIFY EXISTING CONDITIONS IMPERATIVE TO THEIR NEW WORK. REPORT ANY DISCREPANCIES BETWEEN THE DRAWINGS AND FIELD CONDITIONS TO THE ARCHITECT FOR REVIEW. ANY WORK PERFORMED PRIOR TO RESOLUTION OF DISCREPANCIES BY THE LANDSCAPE ARCHITECT IS SUBJECT TO REMOVAL AND REPLACEMENT AT NO ADDITIONAL COST TO
- ALL EXISTING CONDITIONS SHALL BE REMOVED AS REQUIRED TO ACCOMMODATE PROPOSED CONSTRUCTION, WHETHER OR NOT NOTED ON DEMOLITION PLAN. (COORDINATE WITH MECH. & ELEC. DRAWINGS)
- 3. SURFACES ADJACENT TO REMOVAL AREAS SHALL BE PATCHED AND CLEANED. NEW CONSTRUCTION TO MATCH EXISTING ADJACENT SURFACES / FINISHES (UNLESS
- PROVIDE DUST CONTROL AND/OR TEMPORARY BARRIERS / PARTITIONS AS REQUIRED BETWEEN CONSTRUCTION AREAS
- PROVIDE A SAFE PASSAGE THROUGH AND/OR AROUND CONSTRUCTION AREAS AS REQUIRED TO MAINTAIN INGRESS/EGREES AT SHARED ACCESS POINT FOR
- KEEP NOISE TO A LEVEL ACCEPTABLE TO OWNER. AND IN COMPLIANCE WITH LOCAL ORDINANCES.
- REFER MECHANICAL & ELECTRICAL DRAWINGS FOR ADDITIONAL DEMOLITION NOTES.

SITE GRADING PLAN GENERAL NOTES

- PROVIDE PERVIOUS SIDEWALKS AS INDICATED ON PLANS. REFER TO DETAILS FOR ADDITIONAL INFORMATION.
- UTILITY DESIGN AND WORK BY DESIGN / BUILD CONTRACTOR. GRADING AT ACCESSIBLE ROUTE TO COMPLY WITH COMM. CH. 69 DESIGN GUIDELINES.
- FINISHED FLOOR ELEVATION = 1040'-0" ON ARCHITECTURAL DRAWINGS VERIFY ACTUAL ELEVATION WITH DESIGN / BUILD CONTRACTOR
- ALL PROPERTY LINE BEARINGS AND LENGTHS BASED ON OWNER AND DESIGN / BUILD CONTRACTOR PROVIDED DATA.
- VERIFY EXACT BUILDING PLACEMENT WITH GENERAL CONTRACTOR AND PROVIDED CIVIL ENGINEERING INFORMATION. FOR DEMOLITION INFORMATION REFER TO ARCHITECTURAL DRAWINGS AND SD1.3
- CONSTRUCTION SITE EROSION AND SEDIMENTATION CONTROL SHALL COMPLY WITH THE REQUIREMENTS OF THE COUNTY AND SHALL EMPLOY EROSION CONTROL METHODS AS SHOWN AND SPECIFIED IN THE DEPARTMENT OF NATURAL RESOURCES WISCONSIN CONSTRUCTION SITE BEST MANAGEMENT PRACTICES HANDBOOK
- ALL EROSION CONTROL MEASURES SHALL BE ADJUSTED TO MEET FIELD CONDITIONS AT THE TIME OF CONSTRUCTION AND SHALL BE INSTALLED PRIOR TO ANY GRADING OR DISTURBANCE OF EXISTING SURFACE MATERIAL ON THE SITE.
- PERIODIC INSPECTION AND MAINTENANCE OF ALL EROSION CONTROL STRUCTURES SHALL BE PROVIDED TO INSURE INTENDED PURPOSE IS ACCOMPLISHED CONTRACTOR SHALL BE RESPONSIBLE FOR CLEANUP AND REMOVAL OF ALL SEDIMENT LEAVING PROPERTY. EROSION CONTROL MEASURES SHALL BE IN WORKING
- CONDITION AT END OF EACH WORK DAY. 11. SILT FENCE SHALL BE INSTALLED IN ALL LOCATIONS WHERE POTENTIAL RUNOFF AND CONTAMINATION MAY OCCUR.
- 12. EROSION CONTROL MEASURES SHALL BE MAINTAINED ON A CONTINUING BASIS UNTIL SITE IS FULLY STABILIZED.
- 13. ALL EROSION AND SEDIMENT CONTROL PRACTICES TO BE CHECKED FOR STABILITY AND OPERATION FOLLOWING EVERY RUNOFF-PRODUCTION RAINFALL EVENT. ANY NEEDED REPAIRS REPAIRS SHALL SHALL BE MADE IMMEDIATELY TO MAINTAIN ALL PROTECTION AS DESIGNED.
- 14. SEDIMENT IS TO BE REMOVED FROM BEHIND THE SEDIMENT FENCE WHEN IT BECOMES .05 FEET DEEP AT THE FENCE. REPAIR THE FENCE AS NECESSARY TO MAINTAIN
- 15. SEE ALL RELATED DETAILS AND REMAINING SHEETS SPECIFICATION FOR ADDITIONAL INFORMATION AND HOW IT RELATES TO THE SCOPE OF THE PROJECT. ADDITIONAL GRADING OF GRASSED OR LANDSCAPED AREAS MAY BE REQUIRED DUE TO THE PLUMBING, SANITARY OR OTHER UNDERGROUND UTILITY WORK - REVIEW
- 17. CONSTRUCTION LIMITS FENCING AS REQUIRED. 18. ALL CONSTRUCTION, CONSTRUCTION TRAFFIC, DELIVERIES STORAGE OF MATERIALS, VEHICLES DUMPSTERS AND OTHER CONSTRUCTION RELATED ITEMS ARE TO BE
- LOCATED IN THIS AREA ONLY. PROTECT AND SURROUND AREA AS NECESSARY. 19. CONSTRUCTION ENTRY - RESTRICTED TO CONSTRUCTION PERSONNEL. CONSTRUCTION DELIVERIES AND PERSONNEL ARE TO USE THIS ENTRANCE ONLY.

SILT FENCE CONSTRUCTION:

- 1. CONSTRUCT SILT FENCE AROUND THE DISTURBED AREAS AS SHOWN ON PLAN, SHEET SD1.2, TO PREVENT SEDIMENT FROM BEING WASHED INTO STORM WATER
- LOCATE SUPPORT POSTS DOWN SLOPE OF FILTER FABRIC TO HELP SUPPORT FENCING.

DOCUMENTS IN THEIR ENTIRETY TO DETERMINE FULL SCOPE OF WORK.

- WHEN JOINTS ARE NECESSARY, SECURELY FASTEN THE FILTER FABRIC AT A SUPPORT POST AND OVERLAP SLICE TO THE NEXT POST.
- SEDIMENT CONTROL FILTER FABRIC DESIGNED TO IMPEDE SILT FUN-OFF AND PREVENT TOP SOIL EROSION TO CONSIST OF NYLON POLYESTER, PROPYLENE, OR ETHYLENE YAM. MUST MEET WISDOT SPECIFICATIONS AND STANDARDS OF A MINIMUM 50 Ib./LINEAR INCH GRAB TENSILE STRENGTH, A MINIMUM FLOW RATE OF 0.3 GALS./SQ. FT., AND SHOULD CONTAIN ULTRAVIOLET RAY INHIBITORS AND STABILIZERS.
- SEDIMENT CONTROL FILTER FABRIC SHALL BE ANCHORED BY SPREADING 8" OF FABRIC IN A 4"x4" TRENCH. LOOSE DIRT TO BE COMPACTED BACK IN TRENCH ON TOP
- SEDIMENT CONTROL FILTER FABRIC SHALL BE FASTENED TO THE UP-SLOPE SIDE OF 2"X2"X3'-0" PINE POSTS. POSTS TO BE SPACED A MAXIMUM OF 6'-0" APART. PROVIDE INLET GRATE SCREENS AS NEEDED, FIELD LOCATE ALL WITHIN AREA OF CONSTRUCTION SITE SILT FENCE, REFER TO DETAILS 2/SD1.2 - 5SD1.2

SITE LEGEND

POURED CONCRETE **BUILDING SET BACK** BUILDING FOOTPRINT EXIT LOCATIONS PERVIOUS PAVER (REFER TO DETAIL 2/SD.1) PATH OF TRAVEL SPOT ELEVATION AGGREGATE SPLASH STRIP TRACKING PAD DRY CREEK BED 4"-6" COBBLES

(NOT INCLUDING SATURDAY, SUNDAY OR LEGAL HOLIDAYS)

UNDERGROUND SEWER AND UTILITY INFORMATION TO OBTAIN LOCATION OF AS SHOWN IS OBTAINED FROM THE RECORDS OF PARTICIPANT'S UNDERGROUND MUNICIPALITY AND LOCAL UTILITY COMPANIES. FACILITIES BEFORE YOU DIG IN THE ACCURACY OF WHICH CAN NOT BE WISCONIN CALL THE MILWAUKEE GUARANTEED OR CERTIFIED TO. THE LOCATIONS UTILITY ALERT NETWORK OF EXISTING UTILITY INSTALLATIONS AS SHOWN ON (800)-242-8511, (262) 432-7910 THIS SURVEY ARE APPROXIMATE. THERE MAY BE

SCALE: 1" = 100'-0"

OTHER UNDERGROUND UTILITY INSTALLATIONS

WITHIN THE PROJECT AREA THAT ARE NOT SHOWN.

(877) 500-9592 www.Diggershotline.com

Know what's **below.**

LANDSCAPE PLAN GENERAL NOTES

PLANT MATERIAL SHOWN ON LANDSCAPE PLAN IS DEPICTED AT MATURE GROWTH.

- 1. AT LEAST SEVENTY-TWO HOURS PRIOR TO ANY EXCAVATION, CONTRACTOR SHALL VERIFY UTILITY LOCATIONS AS GIVEN BY THE ELECTRIC, GAS, TELEPHONE, WATER, SEWER, AND CABLE TELEVISION COMPANIES, UTILITIES OR ENTITIES. REVIEW WITH OWNER'S REPRESENTATIVE SITE MECHANICAL, SITE ELECTRICAL AND LIGHTING, SITE GRADING AND DRAINAGE, SITE IRRIGATION AND ALL OTHER DRAWINGS PERTAINING TO UNDERGROUND UTILITY LOCATIONS. RECORD SET OF INFORMATION THE SAME AS IN POSSESSION OF OWNER'S REPRESENTATIVE. ALSO REVIEW OWNER'S "MARK SETS" OF ALL OF THESE DRAWINGS IN POSSESSION OF THE CONTRACTOR OR OWNER. MARK ALL SUCH UTILITIES ON THE SITE PRIOR TO COMMENCING. COORDINATE WITH OWNER BEFORE AND DURING CONSTRUCTION. REPAIR ANY DAMAGE TO ANY SYSTEM THAT IS CAUSED BY LANDSCAPE CONTRACTOR AT NO COST TO OWNER.
- 2. ALL PLANTINGS SPECIFIED FOR THE WAUWATOSA VETERANS MEMORIAL PLAZA PROJECT PLANTING TABLES SHALL COMPLY WITH STANDARDS AS DESCRIBED IN AMERICAN STANDARD OF NURSERY STOCK ANSI Z60.1 2014 AND ANSI STANDARDS FOR PLANTING 2012.
- ALL DEVIATIONS FROM THE APPROVED WAUWATOSA VETERANS MEMORIAL PLAZA PROJECT PLANS SHALL BE NOTED ON THE RECORD DRAWINGS BY THE CONTRACTOR AND MAY BE EXECUTED ONLY WITH PRIOR APPROVAL FROM THE LANDSCAPE ARCHITECT AND OWNER'S REPRESENTATIVE. VERBAL AGREEMENTS OR REVISIONS WITHOUT A CHANGE ORDER WILL NOT BE RECOGNIZED BY LANDSCAPE ARCHITECT AND OWNER.
- 4. ALL PLANTS MUST BE BID AND SELECTED PER THE SPECIES SPECIFIED ON THE PLANS. ANY SPECIES SUBSTITUTIONS MUST BE APPROVED IN WRITING BY LANDSCAPE ARCHITECT. THE SIZES OF PLANT MATERIAL LISTED HEREIN IS A MINIMUM ACCEPTABLE SIZE. ADDITIONALLY, IF EXCESSIVE PRUNING REDUCES THE CROWN THE PLANT SHALL BE REPLACED.
- 5. PROTECT PUBLIC FROM CONSTRUCTION WITH BARRIERS AND BARRICADES.
- 6. ALL AREAS THAT WERE DISTURBED DURING CONSTRUCTION AND AREAS NOT COVERED WITH PAVEMENT, BUILDING, PLANTING BEDS, OR TREE PITS ARE TO BE TOPSOILED 3" DEEP (MIN.) AND SHALL BE SODDED/SEEDED WITH SPECIFIED LAWN GRASS. LANDSCAPE CONTRACTOR SHALL INCLUDE COST PER SQUARE YARD FOR ADDITIONAL SEED OPERATIONS AS MAY BE POSSIBLY REQUIRED TO REESTABLISH ADJACENT TURF GRASS AREAS WHICH MAY BECOME DAMAGED DURING THE CONSTRUCTION PROCESS OR TO REPAIR DAMAGE DONE BY OTHERS.
- CONTRACTOR IS RESPONSIBLE FOR FURNISHING ALL MATERIALS, TOOLS, EQUIPMENT, LABOR, AND PLANTS NECESSARY FOR PROPER PLANTING AND INSTALLATION OF ALL LANDSCAPE MATERIAL.
- 8. QUANTITIES ON PLANT MATERIALS LIST ARE FOR CONVENIENCE OF BIDDING ONLY. CONTRACTOR IS RESPONSIBLE FOR ALL PLANTS SHOWN ON LANDSCAPE PLANS AND COVERAGE OF ALL AREAS DELINEATED. THE PLANS ARE TO SUPERSEDE THE PLANT LIST IN ALL CASES.
- 9. CONTRACTOR IS RESPONSIBLE FOR ALL ESTIMATING AND BIDDING, ALL AREAS, QUANTITIES MATERIALS SHOULD BE FIELD VERIFIED WITH SITE CONDITION.
- 10. WHERE DISCREPANCIES OCCUR BETWEEN THE LANDSCAPE PLANS AND/OR ARCHITECTURAL AND/OR THE CIVIL DRAWINGS (AND ANY OTHER SITE DRAWINGS) THE DISCREPANCIES MUST BE BROUGHT TO THE LANDSCAPE ARCHITECTS ATTENTION FOR COORDINATION AND RESOLUTION.
- 11. ALL DISEASED, NOXIOUS OR INAPPROPRIATE MATERIALS SHALL BE REMOVED FROM THE PROPOSED SITE PRIOR TO THE START OF CONSTRUCTION AND DURING THE MAINTENANCE PERIOD.
- 12. GENERAL CONTRACTOR SHALL LEAVE THE SITE FREE OF CONSTRUCTION DEBRIS.
- 13. ALL LAWN AND PLANTING AREAS SHALL SLOPE TO DRAIN A MINIMUM OF 2% UNLESS NOTED OTHERWISE AND REVIEWED WITH OWNER'S REPRESENTATIVE FOR FINAL APPROVAL.
- 14. FINISH GRADES FOR SHRUB AND GROUND COVER AREAS SHALL BE HELD 1" BELOW TOP OF ADJACENT PAVEMENTS AND CURBS, UNLESS NOTED OTHERWISE ON THE PLANS. REFER TO LSP1.2 FOR FURTHER
- 15. ALL PERENNIAL, ANNUAL AND GROUND COVER AREAS TO RECEIVE A BLEND OF ORGANIC SOIL AMENDMENTS PRIOR TO PLANTING. TILL THE FOLLOWING MATERIALS INTO EXISTING TOPSOIL TO A DEPTH OF APPROXIMATELY 8". A DEPTH OF 12" IN TREE PITS. PROPORTIONS AND QUANTITIES MAY REQUIRE ADJUSTMENT DEPENDING ON THE CONDITION OF EXISTING SOIL. REFER TO LSP1.2 FOR FURTHER
 - INFORMATION. <u>PER EVERY 100 SQUARE FEET ADD</u>: ONE - 2 CUBIC FOOT BALE OF PEAT MOSS, 2 POUNDS OF 5 -10 -5 GARDEN FERTILIZER, 1/4 CUBIC YARD OF COMPOSTED MANURE OR OTHER COMPOSTED, ORGANIC
- 16. ALL SHRUBS TO BE POCKET PLANTED WITH A 50/50 MIX OF COMPOSTED, ORGANIC MATERIAL AND EXISTING SOIL. INSTALL TOPSOIL INTO ALL BEDS AS NEEDED TO ACHIEVE PROPER GRADE. REMOVE ALL EXCESSIVE GRAVEL, CLAY AND STONES. REFER TO LSP1.2 FOR FURTHER INFORMATION.
- 17. PLANT ALL TREES SLIGHTLY HIGHER THAN FINISHED GRADE AT ROOT FLARE. BACK FILL HOLE WITH 2/3 EXISTING TOPSOIL AND ORGANIC SOIL AMENDMENTS SPECIFIED IN NOTE 15. AVOID ANY AIR POCKETS. DISCARD ANY GRAVEL CLAY OR STONES. REFER TO LSP1.2 FOR FURTHER INFORMATION.
- 18. ALL TREES TO BE INSTALLED, STAKED AND GUYED ACCORDING TO DETAILS. REFER TO ANSI STANDARDS FOR PLANTING 2012 AND DETAILS ON LSP1.2 FOR FURTHER INFORMATION.
- 19. PROVIDE A 4'-0" 5'-0" DIAMETER MULCH RING AT THE ROOT BALL FLARE OF ALL LAWN TREES.
- 20. ALL PLANTINGS TO BE WATERED AT THE TIME OF PLANTING, THROUGHOUT CONSTRUCTION AND UPON
- COMPLETION OF PROJECT AS REQUIRED. 21. WHERE SPECIFIED, ALL PLANT BEDS, PITS AND TREE RINGS ARE TO RECEIVE A MINIMUM OF 2" - 3" DRESSING
- OF SHREDDED HARDWOODM OAK BARK MULCH SHAVINGS FREE OF GROWTH, WEEDS, FOREIGN MATTER DETRIMENTAL TO PLANT LIFE OR GERMINATION INHIBITING INGREDIENTS. LANDSCAPE CONTRACTOR TO PROVIDE A SAMPLE TO OWNER FOR APPROVAL. CONTRACTOR TO TAKE CARE WITH INSTALLATION NOT TO DAMAGE OR COVER PLANTS. REFER TO LSP1.2 FOR FURTHER INFORMATION.
- 22. LAWN INSTALLATION: CONTRACTOR TO FURNISH AND PREPARE TOPSOIL (3" MIN) AND SEED BED (REMOVE ALL STONES 1" OR LARGER), APPLY STARTER FERTILIZER AND SEED UNIFORMLY. PROVIDE A MULCH COVERING SUITABLE TO GERMINATE AND ESTABLISH TURF. EROSION CONTROL MESH SHOULD BE USED IN SWALES AND STEEP GRADES WHERE APPLICABLE. METHODS OF INSTALLATION MAY VARY AT THE DISCRETION OF CONTRACTOR. IT IS HIS/HER RESPONSIBILITY TO ESTABLISH AND GUARANTEE A SMOOTH, UNIFORM, QUALITY TURF. IF STRAW MULCH IS USED AS A COVERING, A TACKIFIER MAY BE NECESSARY TO AVOID WIND
- 23. DELUXE 50 GRASS SEED MIX REINDER'S (800) 785-3301
- 20% KENTUCKY BLUE GRASS 15% NEWPORT KENTUCKY BLUE GRASS
- 15% SR 2100 Kentucky Bluegrass 25% Creeping Red Fescue
- 15% Replicator Perennial Ryegrass 10% Fiesta 4 Perennial Ryegrass
- APPLY AT A RATE OF 200 POUNDS PER ACRE. REFER TO SUPPLIERS SPECIFICATIONS & INSTALLATION CUT SHEETS FOR FURTHER FORMATION
- 24. DURING THE INITIAL "30 DAY MAINTENANCE PERIOD" THE LANDSCAPE CONTRACTOR IS REQUIRED TO PROVIDE AND ON-GOING PLEASANT VISUAL ENVIRONMENT WHEREAS ANY PLANT WHICH IS NOT RESPONDING TO TRANSPLANTING OR THRIVING SHALL IMMEDIATELY BE REPLACED. NEW LAWNS SHALL BE WATERED AND REPAIRED AND WEEDS MUST CONSTANTLY BE REMOVED, NO EXCEPTIONS WILL BE GRANTED.
 - MAINTENANCE IS THE RESPONSIBILITY OF THE PROPERTY OWNER TO MAINTAIN REQUIRED LANDSCAPING IN ACCORDANCE WITH THE MUNICIPALITY'S PROPERTY MAINTENANCE CODE AND AN APPROVED MAINTENANCE PLAN. THE MAINTENANCE MUST INCLUDE, AT A MINIMUM, METHODS FOR PROVIDING
 - NECESSARY IRRIGATION (if REQUIRED)
 - INTEGRATED PEST MANAGEMENT,
 - PROPER FERTILIZATION
 - TREE CARE AND PRUNING, SHRUB TIP CLIPPING AND SHAPING AS REQUIRED REPLACEMENT OF LOST VEGETATION, AND ALL DISEASED, DAMAGED, OR DEAD MATERIAL WILL BE
 - REPLACED BY THE END OF THE FOLLOWING PLANTING SEASON IN PERPETUITY. WEED MANAGEMENT AND BED CARE.
- 25. ALL NEWLY PLANTED TREES AND SHRUBS ARE TO RECIEVE AN APPLICATION OF AN ANTI-TRANSPIRANT SPRAY THAT WILL EFFECTIVELY REDUCE THE WATER LOSS OF TRANSPIRATION OF PLANT MATERIAL AND REDUCE THE STRESS OF TRANSPLANTATION. IT IS RECOMENDED AS PART OF THE ONGOING MAINTENANCE THAT ANY BROADLEAF EVERGREEN AND CONIFEROUS TREE AND SHRUBS (EXCLUDING ARBORVITAE) RECIEVE AN APPLIATION OF AN ANTI-DESICANT SPRAY TO REDUCE THE LOSS OF MOISTURE DUE TO WINTER DESICCATION.
- 26. MAINTENANCE. THE OWNER SHALL TEND AND MAINTAIN ALL PLANT MATERIALS IN A HEALTHY GROWING CONDITION AS PER THE APPROVED PLAN. PLANTINGS SHALL BE REPLACED WHEN NECESSARY AND KEPT FREE FROM REFUSE & DEBRIS. ALL PLANTING MATERIAL WHICH IS DYING OR DAMAGED BEYOND RECOVERY SHALL BE REPLACED WITHIN SIX (6) MONTHS OR BY THE NEXT PLANTING SEASON, WHICHEVER COMES FIRST.
- 27. LANDSCAPE / SITE DEMOLITION CONTRACTOR TO VERIFY LOCATIONS OF EXISTING TREES AND SHRUBS TO BE SALVAGED AND CLEARLY TAG THEM WITH MARKING TAPE AND CONSTRUCTION FENCE.

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WAUWATOSA **VETERANS COMMITTEE**

Wauwatosa, WI

<u>Project:</u>

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PROPOSED PLAZA PLAN SET GENERAL NOTES AND SITE INFORMATION,

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Date of Drawing.	09/20/23
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Job Number:

L23-025

Wauwatosa, WI

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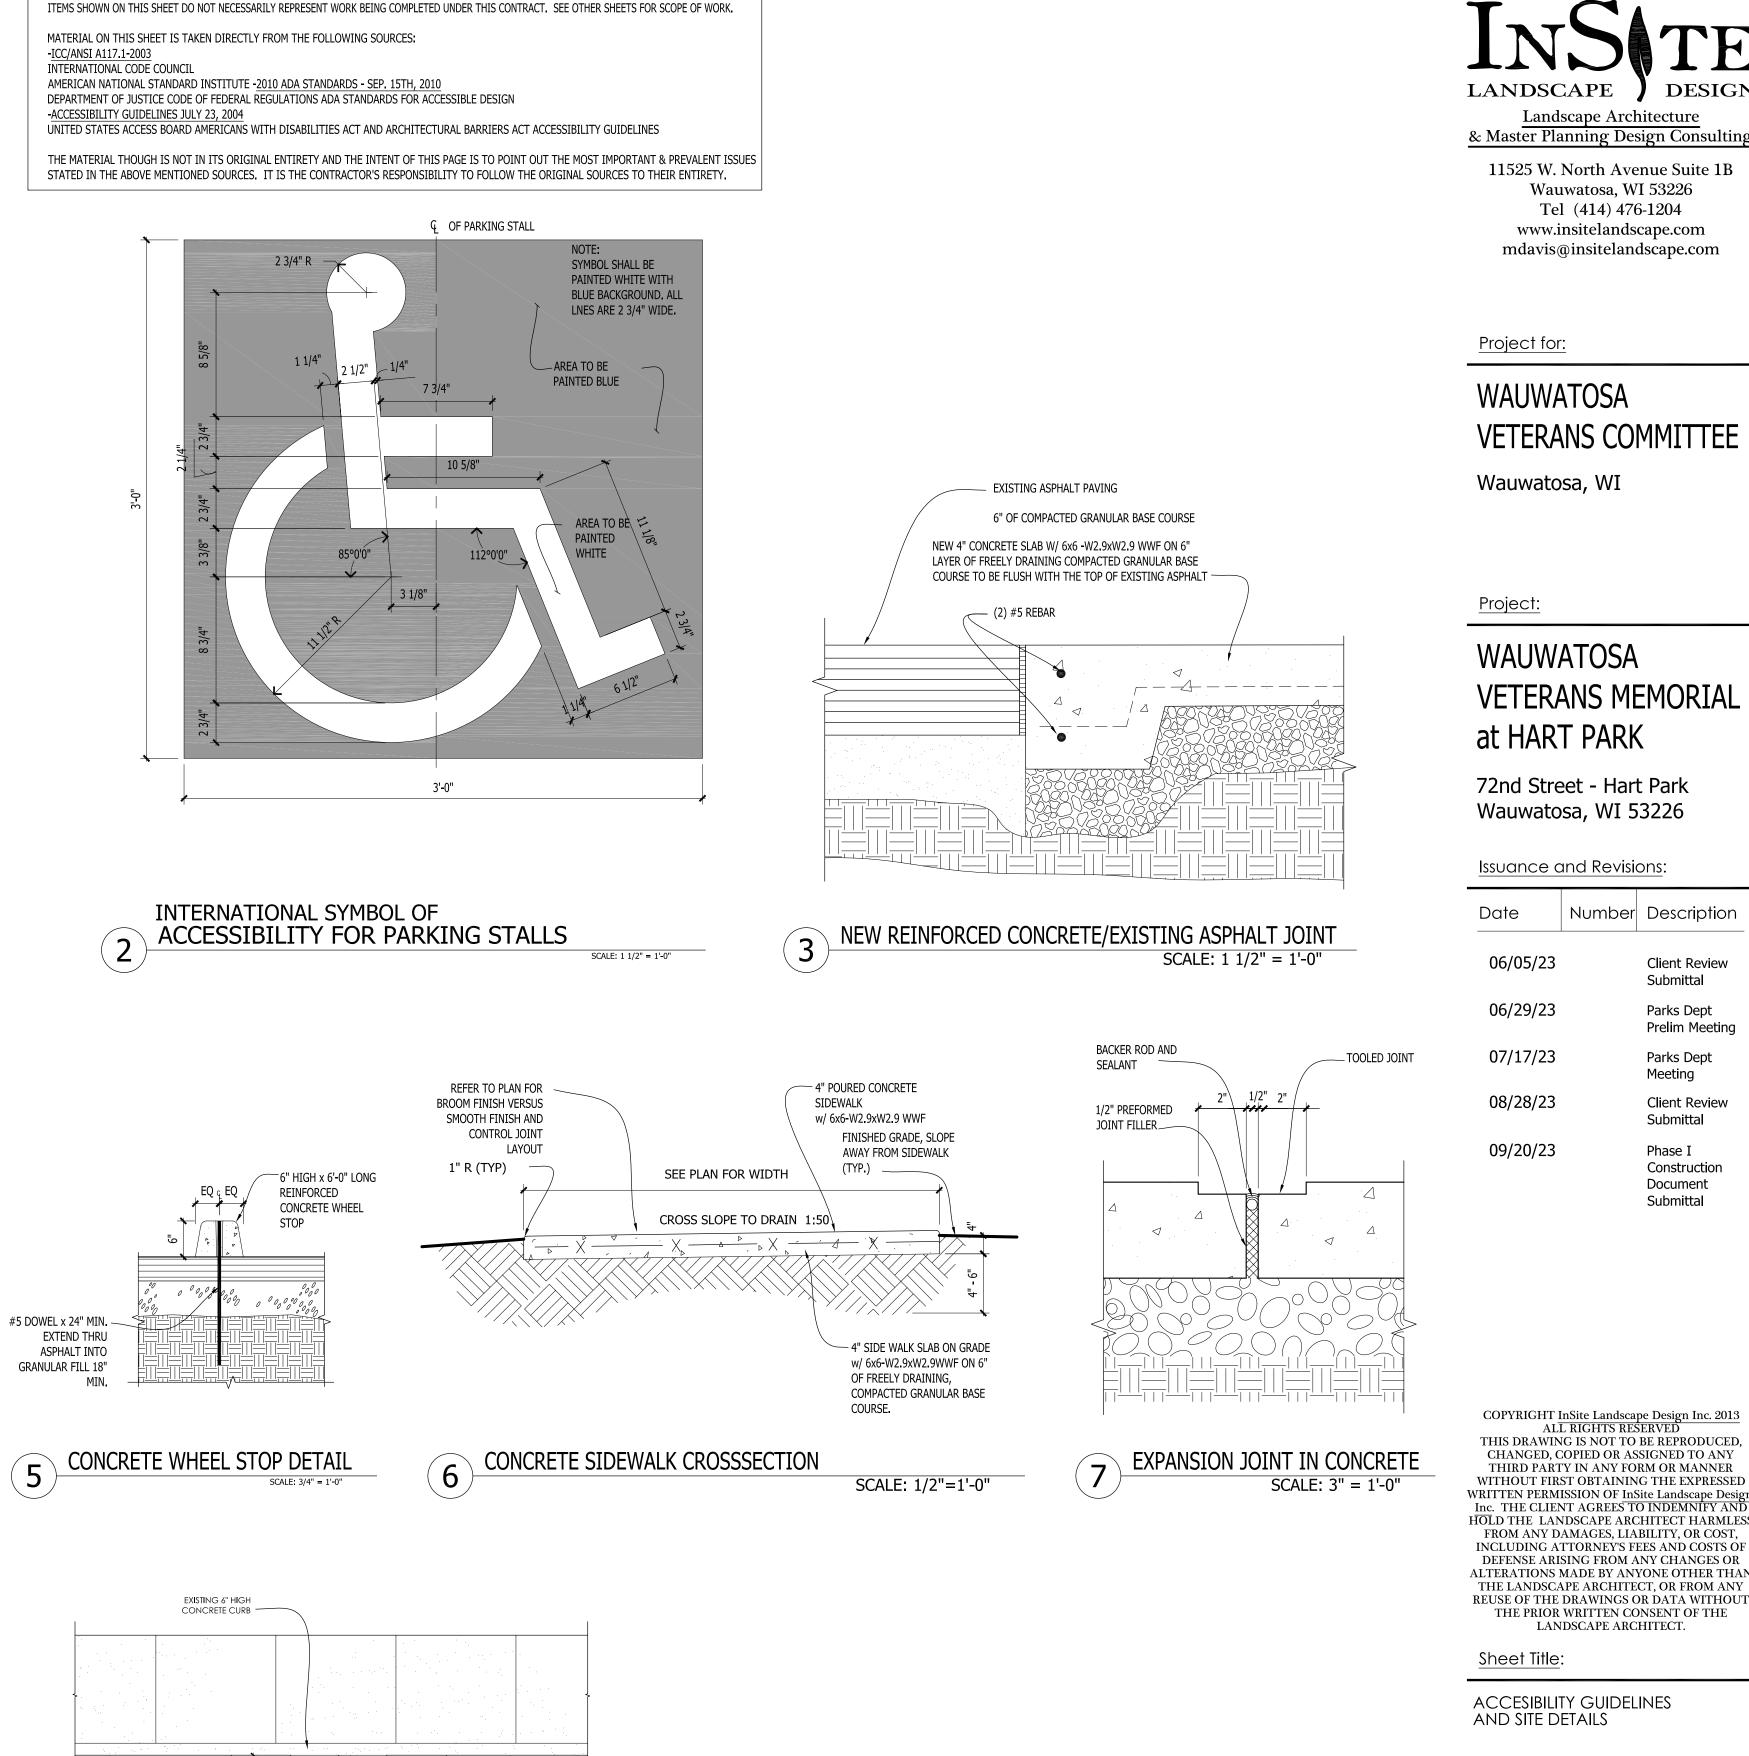
LANDSCAPE ARCHITECT.


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ACCESIBILITY GUIDELINES AND SITE DETAILS

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Sheet Number:





A. VERTICAL RISER

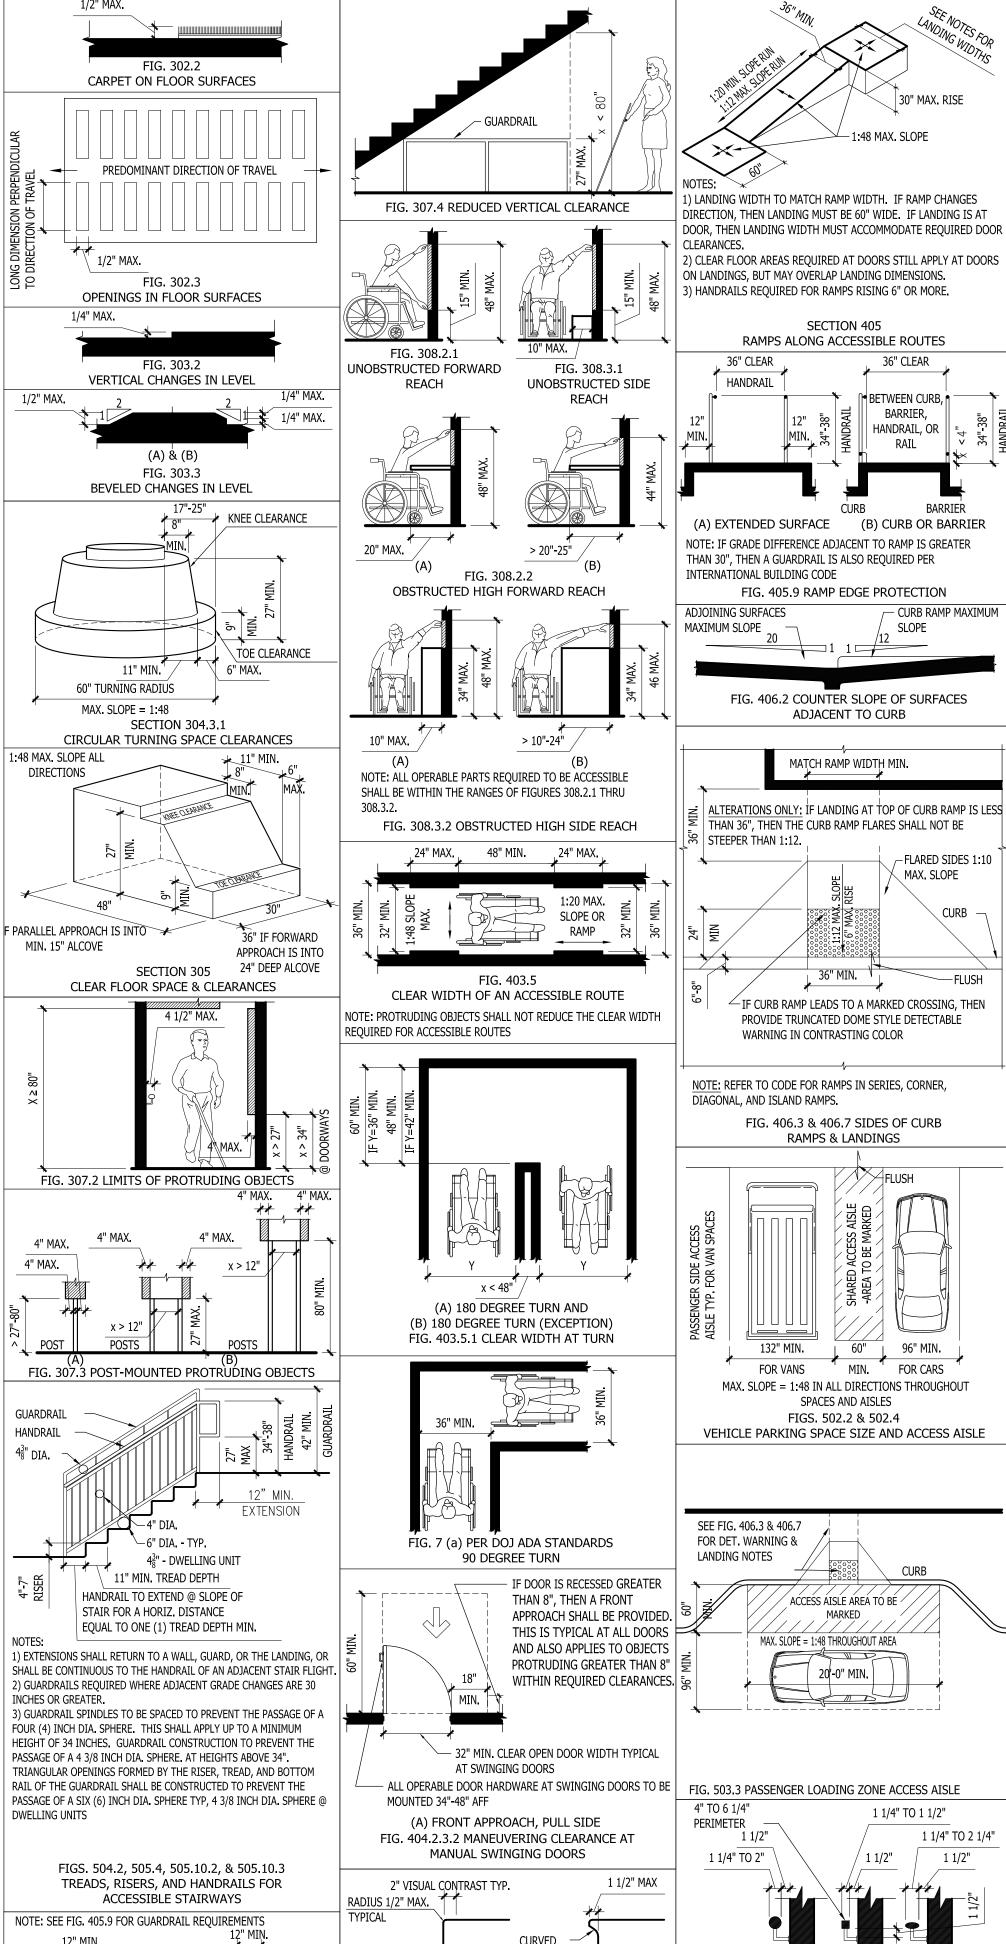C. BEVELED NOSING

NOTE: MAXIMUM SLOPE OF 1:48 ANY DIRECTION

FIG. 504.5 STAIR NOSINGS

BEVELED


FIG. 505.10.1 TOP AND BOTTOM HANDRAI

EXTENSION AT RAMPS

B. CURVED NOSING

D. ANGLED RISER

HANDRAIL CLEARANCE AND CROSS SECTION

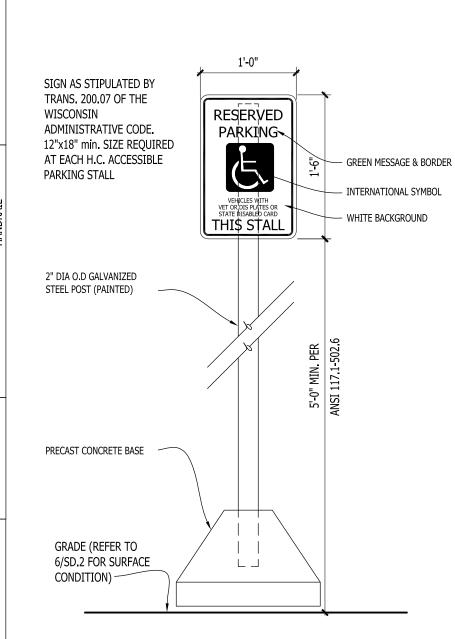



COMPACTED GRANULAR

FILL, SEE PAVING TYPE

SAW CUT AND FORM AS

FOR MIN DEPTH

REQUIRED

SCALE: 1" = 1'-0"

CONCRETE CURB DETAIL ("V-H" TYPE)

REINFORCEMENT TO RUN CONTINUOUS

- REINFORCEMENT TO BE DISCONTINUOUS ACROSS CONSTRUCTION JOINT

___1:1 SLOPE ~

____x___x

KEYWAY CUT FROM 2X2

- BREAK THE BOND BTW. NEW AND PREVIOUSLY PLACED SLABS

A CURING COMPOUND, ASPHALTIC EMULSION OR FORM OIL

CONSTRUCTION JOINT

1) SLABS TO BE PLACED USING THE LONG STRIP CONSTRUCTION METHOD.

2) REFER TO GENERAL NOTES, SPECIFICATIONS AND / OR DRAWINGS

3) SLAB REINFORCEMENT, IF OTHER THAN WWF, SHALL BE CHAIRED BY

FOR SUBGRADE PREPARATION REQUIREMENTS.


SOIL SUPPORTED SLAB BOLSTERS.

BY SPRAYING OR PAINTING THE EXPOSED SIDE OF JOINT WITH


EDGE EACH POUR TO 1/8" RADIUS

/1/4" MAXIMUM

CONTROL JOINT

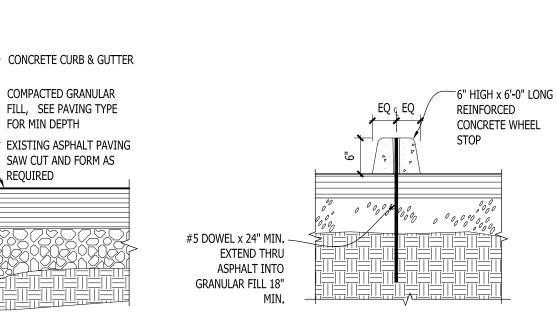

THIS SHEET FOR REFERENCE ONLY:

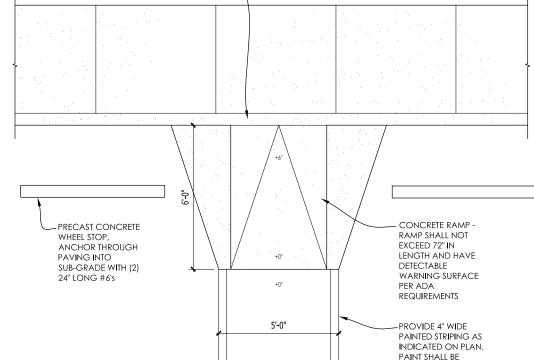


> BUILT UP CURB RAMP SCALE: 1/4"=1'-0"

"TRAFFIC YELLOW"

ACCORDANCE WITH

PL-4666 OR **I**N

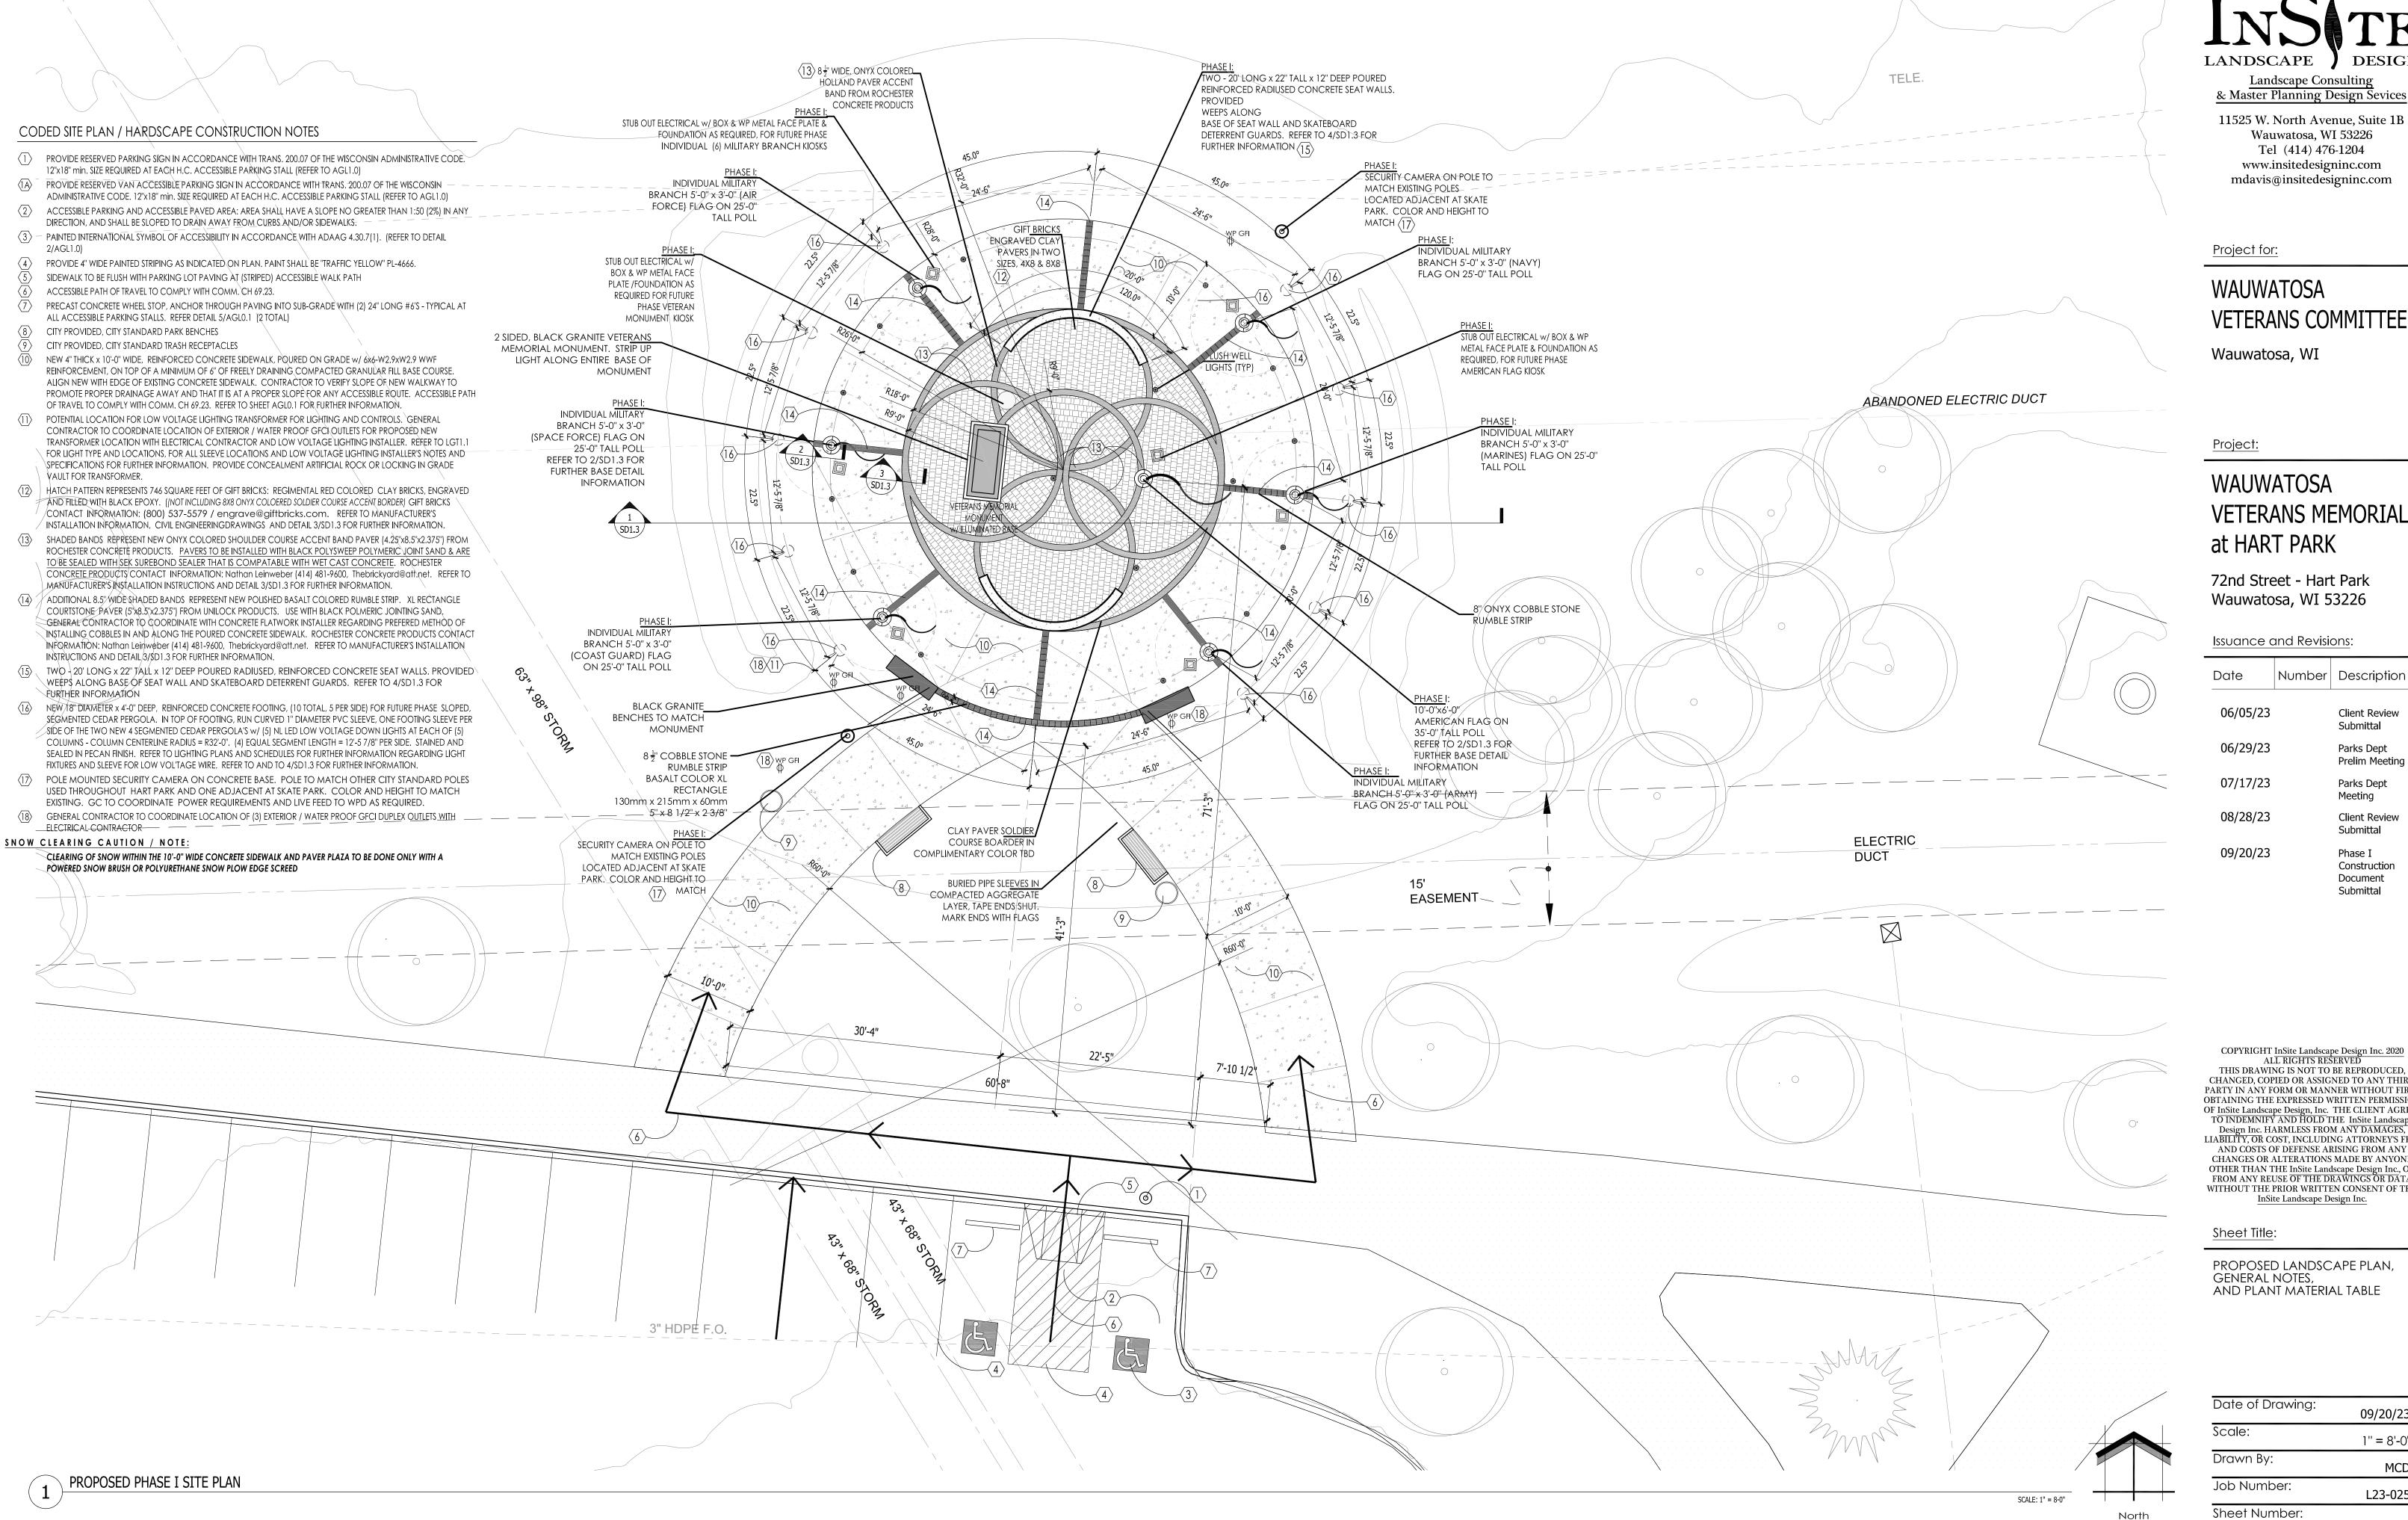

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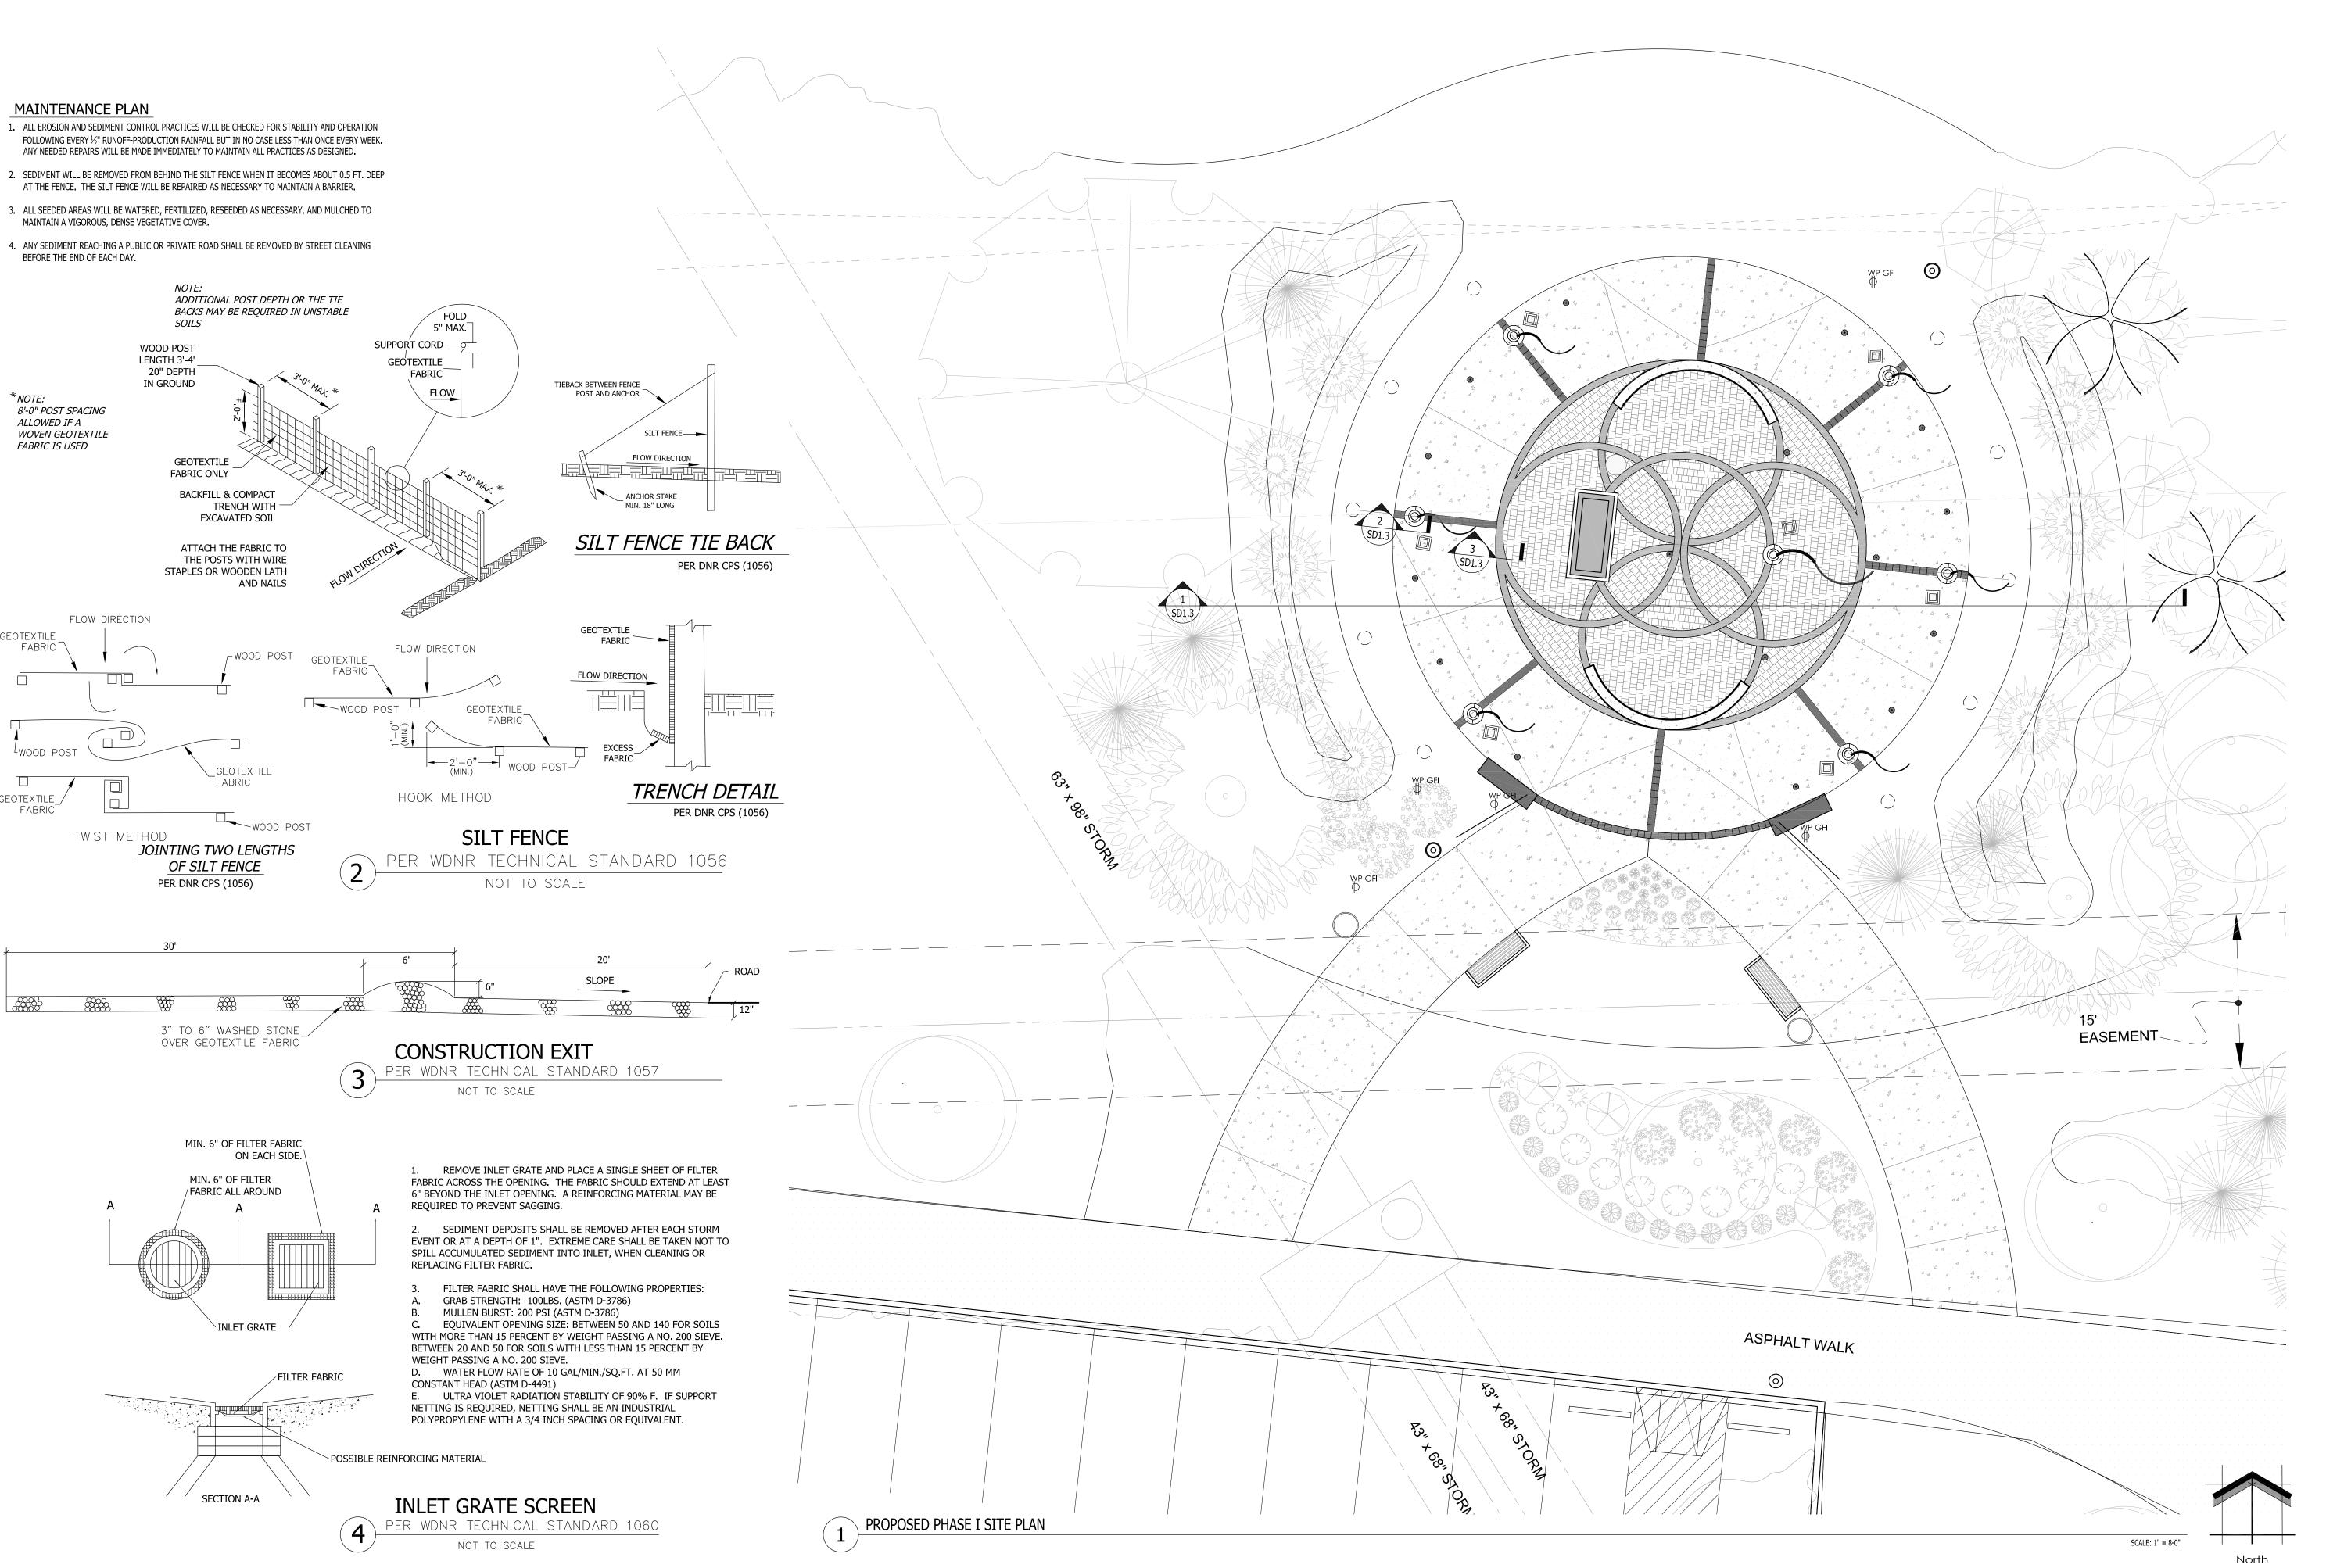
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PROPOSED LANDSCAPE PLAN, GENERAL NOTES, AND PLANT MATERIAL TABLE

5	
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MAINTENANCE PLAN

BEFORE THE END OF EACH DAY.

*NOTE: 8'-0" POST SPACING ALLOWED IF A

WOVEN GEOTEXTILE

FLOW DIRECTION

FABRIC IS USED

GEOTEXTILE

GEOTEXTILE_/

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PROPOSED PHASE I GRADING PLAN, EROSION CONTROL INFORMATION

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- 18" DIAMETER CONCRETE FOUNDATION COMPACTED AGGREGATE BASECOURSE

- 4" CONCRETE WALK FINE SAND FILLED JOINT BETWEEN CONCRETE AND PAVER 4.25"x8.5"x2.375"ONYXCOLORED ACCENT PAVERS 4"x8" AND 8"x8" CLAY GIFT BRICK ENGRAVED PAVERS - 1" MAXIMUM SHARP SAND LEVELING BED FOR PAVERS WITH A GEO- TEXTILE FABRIC ATOP GRAVEL 5-6" SUBBASE OF CLASS 5 GRAVEL OR AS SPECIFIED BY MANUFACTURER

-WATERPROOF COMPOUND 1" DEEP

FILL SPACE WITH PACKED DRY SAND

FOUR WELDED STEEL WEDGES

WELDED TO PLATES

2'-0"

2 FLAG POLE BASE

16" x 16 \" WELDED STEEL PLATE

16 GAUGE GALV. CORRUGATED STEEL TUBE

- 8 x 8 DIA" PLATE SUPPORT WELDED TO SPIKE

SCALE 1" = 1'-0"

 $\frac{3}{4}$ " DIA. STEEL LIGHTNING GROUND SPIKE

-STANDARD METAL BASE

⁻4 HARDWOOD WEDGES

CONCRETE INTERLOCKING PAVER DETAIL SCALE: 1 1/2"=1'-0"

(4) CONCRETE SEATWALL

CHANNEL IS SHORT 3" AT EACH END OF

OF CHANNEL MOUNT PRIOR TO FORMING AND POURING SEAT WALL. REFER TO CUT

INSIDE FACE OF SEAT WALL. VERIFY SIZE

SHEETS FOR FURTHER INFORMATION AND

INSTALLATION INSTRUCTIONS.

TWO - 20' LONG x 22" TALL x 12"

RADIUSED CONCRETE SEAT WALLS.

DEEP POURED REINFORCED

#5 AT 12" O.C.,

FULL HEIGHT

GIFT BRICK

2" CLEAR —

4"x8" AND 8"x8" CLAY

ENGRAVED PAVERS -

ACCENT PAVERS—

4.25"x8.5"x2.375"

ONYX COLORED

5 SLOPED PERGOLA FOOTING

STEELCRAFT LA-FRO12BC

SKATEBOARD DETERRENT

ENDS AND 36" O.C. THERE

GUARDS SPACED AT 18" FROM

AFTER. ANCHOR WITH OFFSET

THRU-HOLES FOR SMART PIN

PLUS SYSTEM. USE ANCHORS

IN CONJUNCTION WITH 2 PART

PROVIDED 1"DIA WEEPS ALONG

IMPACT RESISTANT EPOXY

BASE OF SEAT WALL @ 36"

- 1/2" x 4" STRIP JOINT EXPANSION

JOINT BETWEEN WALL AND new

- 1" DIA HOLE/SLEEVE TO RUN LOW

4" REINFORCED POURED CONCRETE

VOLTAGE CABLE TO STRIP LIGHT

_ 2" DIA SLEEVE TO RUN LOW

VOLTAGE CABLE AND POWER

8" OF TYPE A: $\frac{3}{4}$ " - 1" GRANULAR

STONE-FREE OF SHALE, CLAY, FRIABLE MATERIAL AND DEBRIS-

FILL- ANGULAR CRUSHED WASHED

GRADED IN ACCORDANCE WITH

CONCRETE SLAB

SIDEWALK

ASTM C136

6061-T6 ALUMINUM

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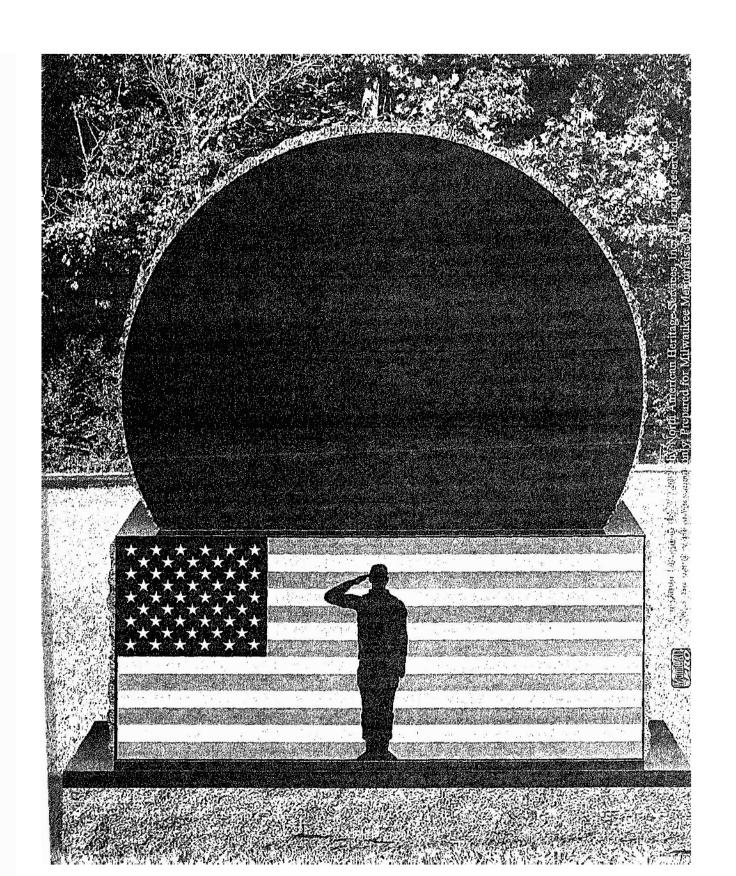
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PROPOSED PHASE I HARDSCAPE MATERIALS

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SERVED IN THE ARMED FORCES OF THE UNITED STATES OF AMERICA TO PRESERVE OUR FREEDOM

MEMORIAL PLAZA MONUMENT FRONT

HOLLAND 6 and 8cm PAVERS

- Larger than typical Hollands Smooth top, beveled edge

- For patios, paths, pools and drives

0.24 sq. ft.

Rochester

Dimensions shown are nominal. Pallet square footage is accurate, layers and bands square footages have been rounded to nearest whole number.


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MEMORIAL PLAZA MONUMENT BACK







5×5×23/6" 130 x 130 x 60mm

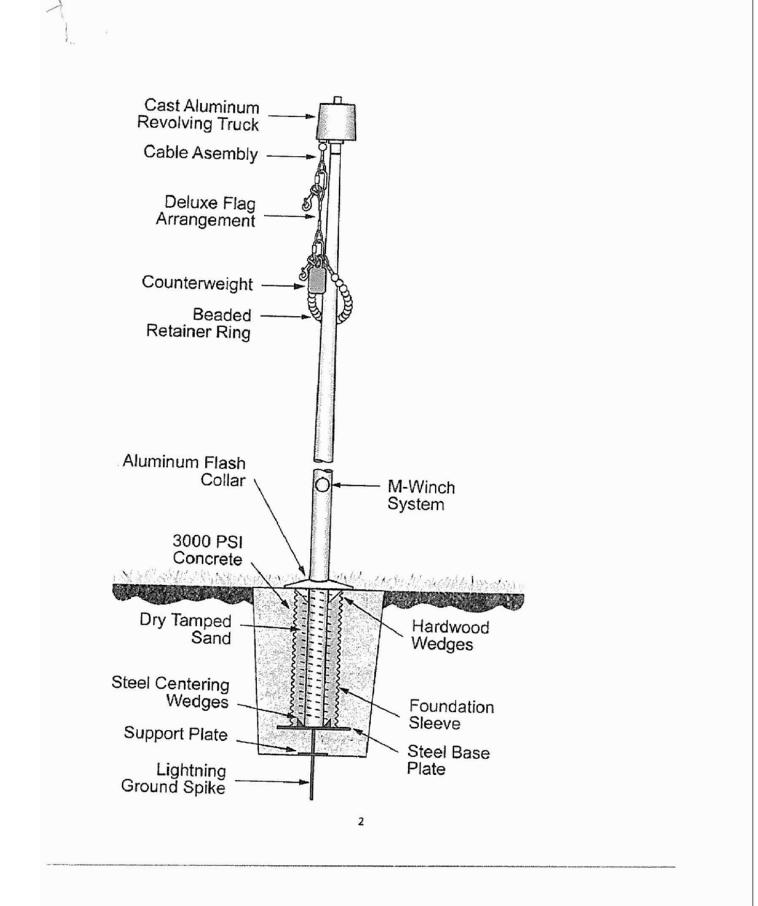6 UNILOCK COURTSTONE 8" WIDE BASALT COLORED RUMBLE STRIP

Courtstone^{*} Exclusive to UNILOCK 5 UNIT RANDOM BUNDLE DRIVE FRIENDLY LARGERECTANGLE XL Rectangle 5 x 8½ x 23/s" 5 x 73/s x 23/s" 130 x 215 x 60mm 130 x 185 x 60mm SMALL RECTANGLE 5 x 81/2 x 23/6" 5 x 53/4 x 23/6" 130 x 165 x 60mm

4.0000 3.6250 Material: 6061-T6 Aluminum. Finish: Hard tumble to remove all machined and/or cut edges. Type II Clear Anodize or outdoor rated Polyurethane Coat. LA-FRQ12BC Anchoring: Two offset thru holes for Smart Pin Plus.
Use anchors in conjunction with two-part impact resistant epoxy. Steelcraft Product Spacing: 18" from end of planters/walls and approximately 36" centers.

STEELCRAFT LA-FRO12BC SKATEBOARD DETERRENT GUARDS

ELEGANCE

interlock

Holland 8cm can be made in any color with or without KolorLast.

Set-up fee and minimum quantity required, customer must take

400 (98 sq. ft.)


2,560 lbs.

f P in O

entire production run. Returns not allowed.

3 FLAG POLE

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Quantity	Code Name	Symbol	Scientific Name	Common Name	Planting Size	Comments
2	AcsaB		Acer saccharum 'Bailsta'	Fall Fiesta Sugar Maple	2 1/2" Cal - B&B	1
2	BepoW		Betula populifolia 'Whitespire'	Whitespire Japenese White Birch	2 1/2" Cal - B&B	1
2	GibiPS	9	Ginko biloba 'Princeton Sentry'	Princeton Sentry Maidenhair Tree	2 1/2" Cal - B&B	1, 6
4	MaAk	X	Malus "Adirondack"	Adirondack Flowering Crab	1 1/2" Cal - B&B	1
14	Extg	\odot	Existing to Remain	Existing to Remain	Existing	2

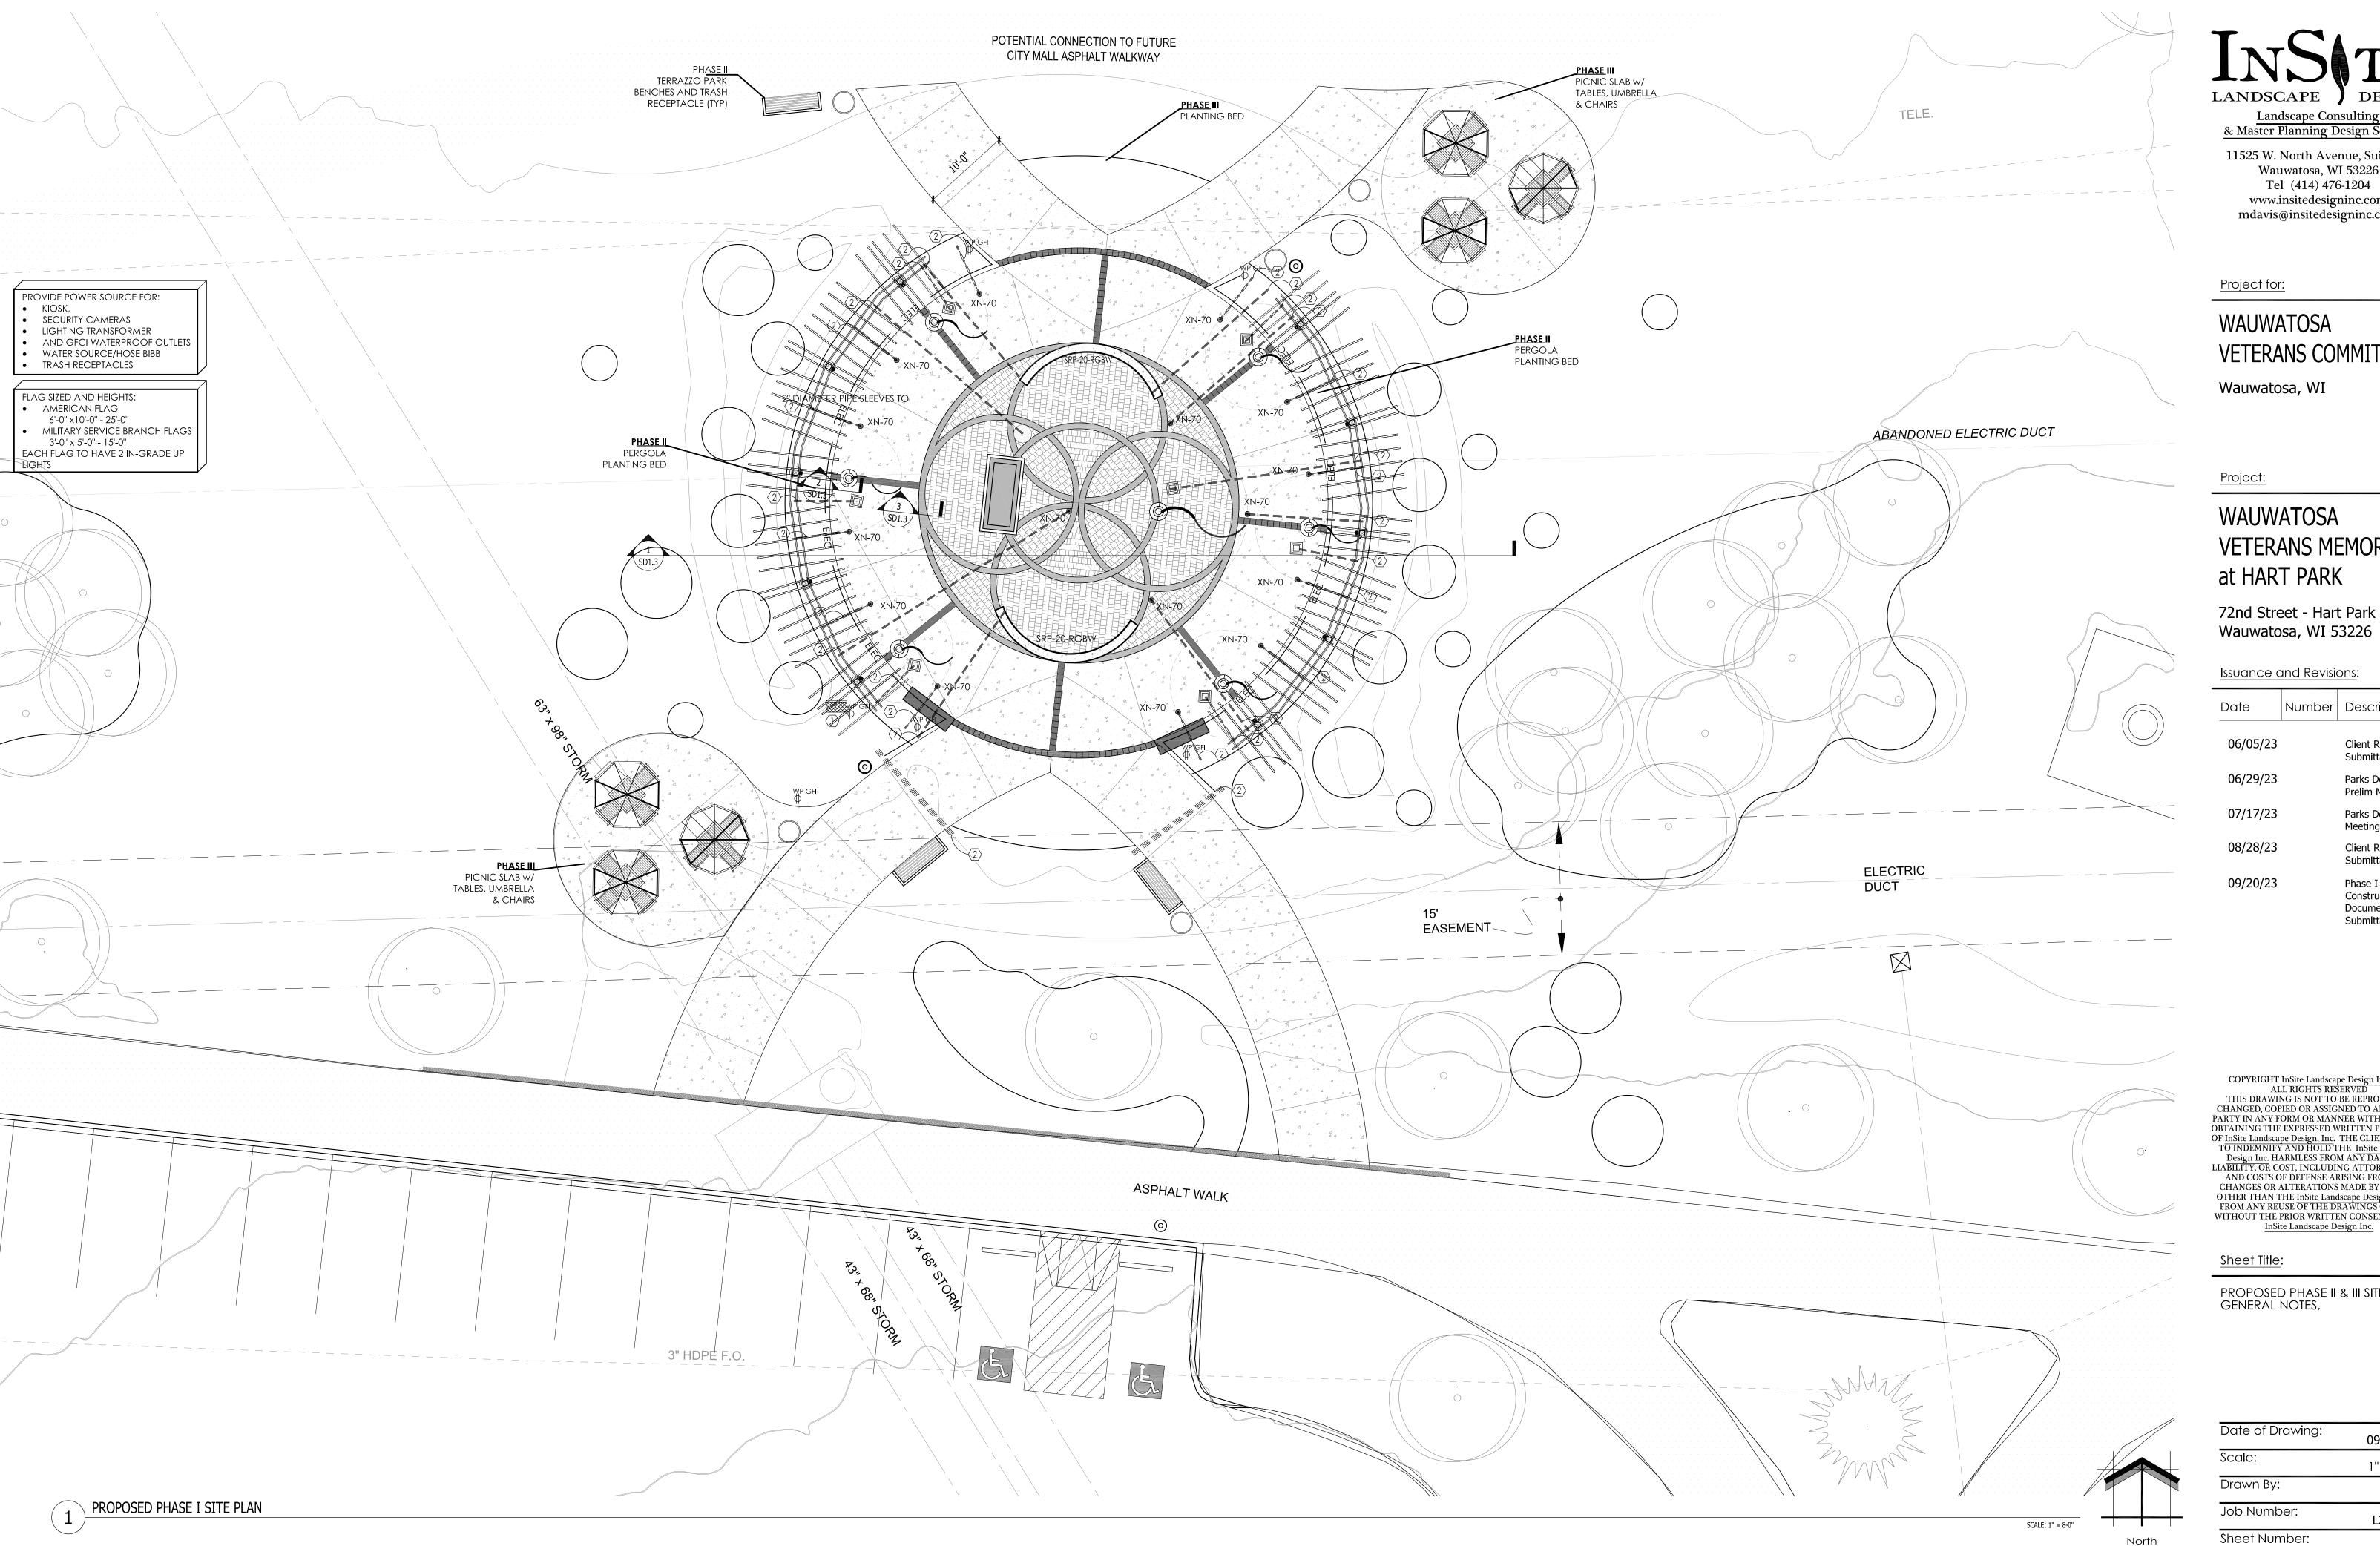Quantity	Code Name	Symbol	Scientific Name	Common Name	Planting Size	Comment
10	Piom	*	Picea omorika	Serbian Spruce	7' - B&B	3
8	JuscM		Juniperus scopulorum 'Moonglow'	Moonglow Juniper	7' - B&B	3

Quantity	Code Name	Symbol	Scientific Name	Common Name	Planting Size	Commer
13	PaviHR	ZWZ ZWZ	Panicum virgatum 'Hot Rod'	Hot Rod Switch Grass	1-Gal - Cont	5

Quantity	Code Name	Symbol	Scientific Name	Common Name	Planting Size	Comments
8	DeYS	(3	Deutzia 'NCDX1'	Yuki Snowflake Deutzia	15" - 18" - Cont	4
10	PhopC	6	Physocarpus opulifolius 'Mindia'	Coppertina Ninebark	24" - 30" - B&B	4
3	WefISB	\otimes	Weigela florida 'Verweil4'	Sonic Bloom Red Reblooming Weigela	18" - 24"- Cont	4
Perennial						
Quantity	Code Name	Symbol	Scientific Name	Common Name	Planting Size	Comments

Pow Wow Wild Berry Coneflower

Little Grapette Dwarf Daylily

4 1/2" pot

1-Gal - Cont

9

LaanK Lavandula angustifolia 'Kerlavangem' Sweet Romance Lavender 1-Gal - Cont

Echinacea purpurea 'PA\$702917'

| Hemerocallis x 'Little Grapette'

Straight central leader, full & even crown. Prune only after planting.

Prune existing tree, remove any dead, diseased or hazardous limbs. Thin out as required and raise canopy for safety and viability for both pedestrians and motorists.

Evenly shaped upright tree with full branching to the ground.

E. Full, well rooted plant, evenly shaped.

EcpuPW

HeLG

5. Full, well rooted plant.6. Male only

LANDSCAPE / SITE DEMOLITION CONTRACTOR TO VERIFY LOCATIONS OF EXISTING TREES TO BE SALVAGED AND CLEARLY TAG THEM WITH MARKING TAPE AND CONSTRUCTION FENCE.

LANDSCAPE INSTALLATION CONTRACTOR TO COORDINATE INSTALLATION OF NEW PLANT MATERIAL AND THE COORDINATION WITH EXISTING TREES TO BE SALVAGED.

COORDINATION WITH EXISTING TREES TO BE SALVAGED.

- MULCH BED AREA. DRESS WITH 2"-3" OF SHREDDED HARDWOOD BARK MULCH. TAKE CARE WITH INSTALLATION NOT TO DAMAGE OR COVER PLANTS. REFER TO GENERAL NOTES AND SPECIFICATIONS FOR FURTHER INFORMATION.
- (2) EARTHEN BED EDGE (SHOVEL POINT) LANDSCAPE EDGE. TYPICAL ALL PLANT MATERIAL AREAS. DRESS WITH 2"-3"
 OF SHREDDED HARDWOOD BARK MULCH. REFER TO GENERAL NOTES AND SPECIFICATIONS FOR FURTHER
 INFORMATION
- MULCHED 4'-0" DIA. TREE RING BED AREA W/ EARTHEN BED EDGE (SHOVEL POINT) LANDSCAPE EDGE AS REQUIRED. DRESS WITH 2"-3" OF SHREDDED HARDWOOD BARK MULCH. REFER TO LSP1.2, GENERAL NOTES AND SPECIFICATIONS FOR FURTHER INFORMATION.
- SEEDED AREAS OF TURF GRASS. REPAIR ANY AND ALL TURF DAMAGE FROM THE CONSTRUCTION PROCESS. IT IS VERY IMPORTANT TO FOLLOW THE MANUFACTURERS INSTALLATION INSTRUCTIONS REGARDING THE TURF GRASS FOR PROPER GERMINATION AND SURVIVABILITY OF THE SEED MIX. ALSO REFER TO GENERAL NOTES FOR PREPARATION OF TOP SOIL AND SEED INSTALLATION. REFER TO GRADING PLAN FOR FURTHER INFORMATION. ALSO REFER TO GENERAL NOTES AND SPECIFICATIONS FOR FURTHER INFORMATION.

INS TE

Landscape Consulting & Master Planning Design Sevices

11525 W. North Avenue, Suite 1B Wauwatosa, WI 53226 Tel (414) 476-1204 www.insitedesigninc.com mdavis@insitedesigninc.com

Project for:

WAUWATOSA VETERANS COMMITTEE

Wauwatosa, WI

<u>Project:</u>

WAUWATOSA VETERANS MEMORIAL at HART PARK

72nd Street - Hart Park Wauwatosa, WI 53226

Issuance and Revisions:

Date	Number	Description
06/05/23		Client Review Submittal
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Submittal

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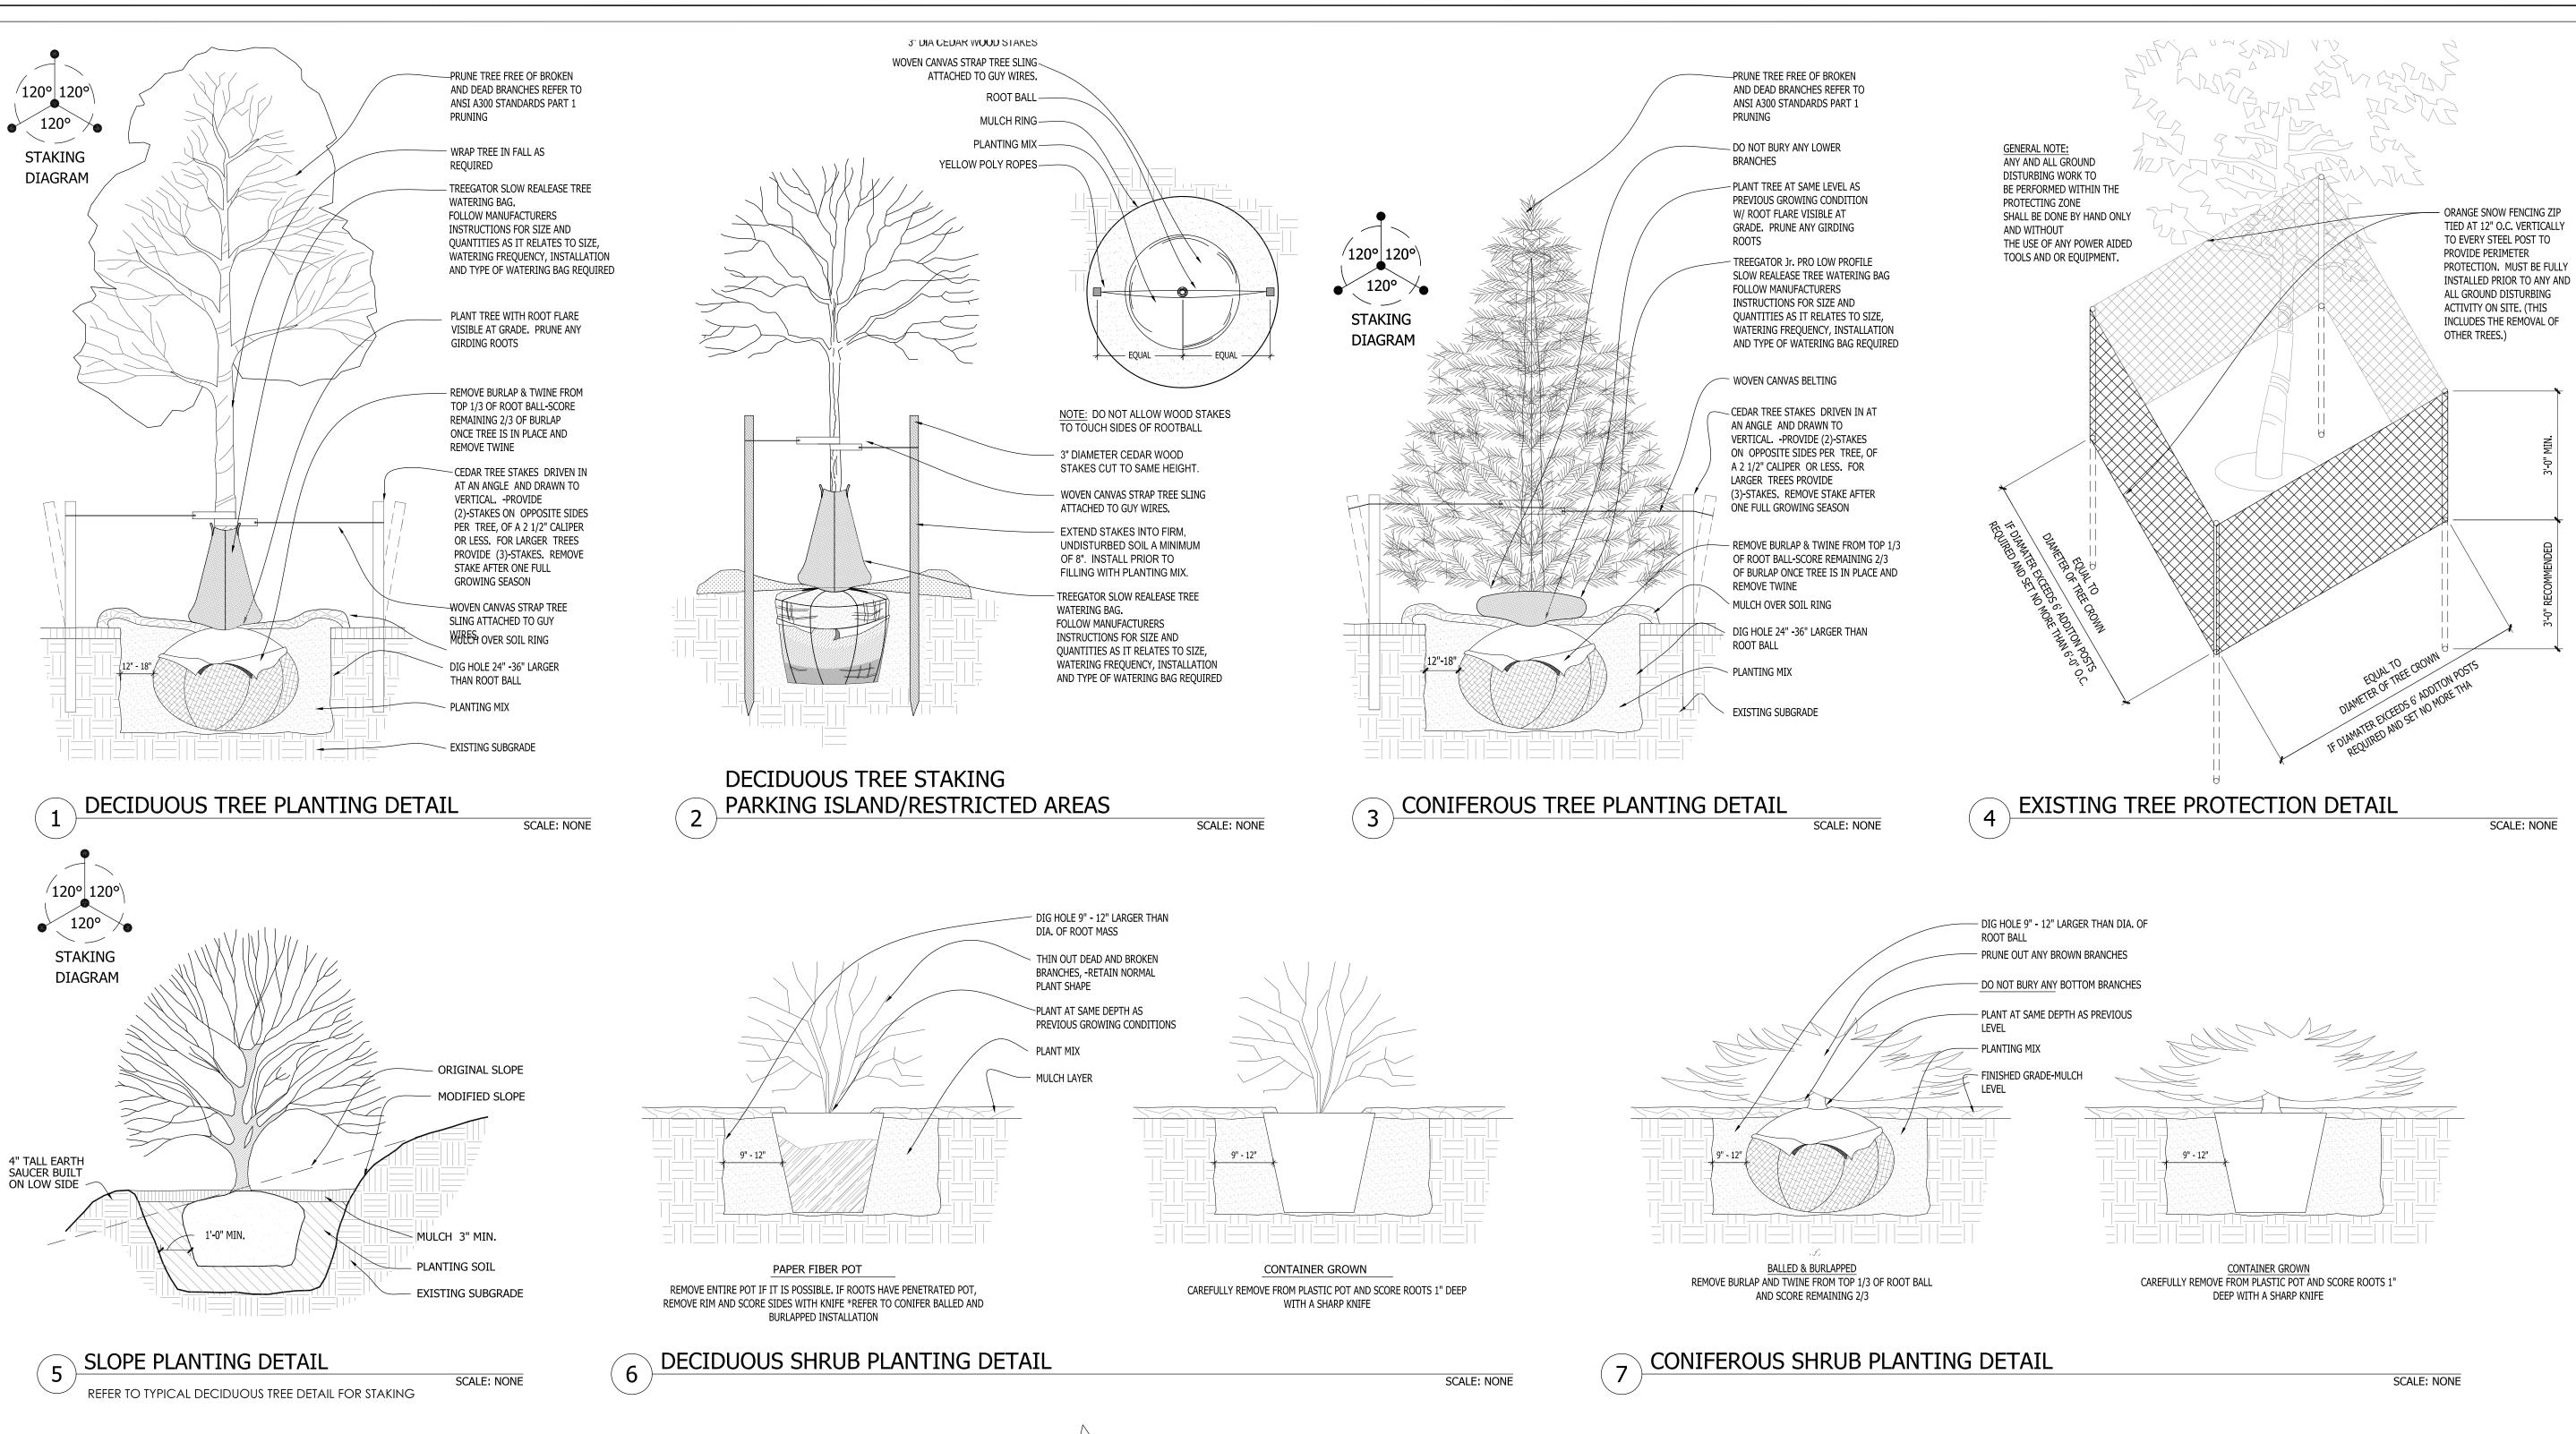
<u>Sheet Title</u>:

PROPOSED PHASE I LANDSCAPE PLAN, AND PLANT MATERIAL TABLE

Date of Drawing:	09/20/23
Scale:	1" = 20'-0"
Drawn By:	MCD
Job Number:	1 23-025

1SP1.1

Sheet Number:



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Sheet Title:

PROPOSED LANDSCAPE PLAN, PLANTING DETAILS

Date of Drawings	
Date of Drawing:	09/20/23
Scale:	As Noted
Drawn By:	MCD
Job Number:	L23-025

Sheet Number:

LSP1.2

12" MIN. VARIES WITH PLANT MATERIAL SELECTED
REFER TO LANDSCAPE PLANS

SCALE: NONE

VARIES W/ BEDS REFER TO PLANS

PERENNIAL BED PLANTING DETAIL

PERIMETER OF BUILDING

GRASSES -

MULCH

TURF GRASS

12" MINIMUM OF

UNDISTURBED EARTH

PLANTING SOIL MIX

PERENNIALS AND/OR PERENNIAL

SHREDDED HARDWOOD BARK

SPADE EDGE EARTHEN

BED EDGE STANDARD

BEDLINES ARE TO BE CUT CRISP AS PER PLAN. A CLEAN DEFINITION BETWEEN TURF AND PLANTING BED IS REQUIRED.

TOP OF MULCH SHOULD BE CRESTED 1-2" ABOVE TURF FOR POSITIBE DRAINGE. SLOPE GRADUALLY.

3" (+/-) MULCH BED

9 SPADE EDGE PLANT BED EDGE DETAIL

SCALE: NONE

Proposed Phase II Plant Material Table

Quantity	Code Name	Symbol	Scientific Name	Common Name	Planting Size	Comments
4	JuscM		Juniperus scopulorum 'Moonglow'	Moonglow Juniper	5' - 6' - B&B	
Perennial Gr	ass					
Quantity	Code Name	Symbol	Scientific Name	Common Name	Planting Size	Comments
28	PaviN	**	Panicum virgatum 'Northwind'	Northwind Switch Grass	1-Gal - Cont	
	eciduous Shrub	•		,		
Quantity	Code Name	Symbol	Scientific Name	Common Name	Planting Size	Comments

<u>Proposed Phase III Plant Material Table</u>

ass					
Code Name	Symbol	Scientific Name	Common Name	Planting Size	Comments
PaviHR	ZW.	Panicum virgatum 'Hot Rod'	Hot Rod Switch Grass	1-Gal - Cont	
Code Name	Symbol	Scientific Name	Common Name	Planting Size	Comments
EcpuPW	\$200 S	Echinacea purpurea 'PAS702917'	Pow Wow Wild Berry Coneflower	4 1/2" pot	
HeLG	**	Hemerocallis x 'Little Grapette'	Little Grapette Dwarf Daylily	1-Gal - Cont	
	Code Name PaviHR Code Name EcpuPW	Code Name Symbol PaviHR Code Name Symbol EcpuPW	Code Name Symbol Scientific Name PaviHR Panicum virgatum 'Hot Rod' Code Name Symbol Scientific Name EcpuPW Echinacea purpurea 'PAS702917'	Code Name Symbol Scientific Name Common Name PaviHR Panicum virgatum 'Hot Rod' Hot Rod Switch Grass Code Name Symbol Scientific Name Common Name EcpuPW Echinacea purpurea 'PAS702917' Pow Wow Wild Berry Coneflower	Code NameSymbolScientific NameCommon NamePlanting SizePaviHRPanicum virgatum 'Hot Rod'Hot Rod Switch Grass1-Gal - ContCode NameSymbolScientific NameCommon NamePlanting SizeEcpuPWEchinacea purpurea 'PAS702917'Pow Wow Wild Berry Coneflower4 1/2" pot

LANDSCAPE PLAN CODED CONSTRUCTION NOTES

LANDSCAPE / SITE DEMOLITION CONTRACTOR TO VERIFY LOCATIONS OF EXISTING TREES TO BE SALVAGED AND CLEARLY TAG THEM WITH MARKING TAPE AND CONSTRUCTION FENCE.

LANDSCAPE INSTALLATION CONTRACTOR TO COORDINATE INSTALLATION OF NEW PLANT MATERIAL AND THE

COORDINATION WITH EXISTING TREES TO BE SALVAGED.

- (1) MULCH BED AREA. DRESS WITH 2"-3" OF SHREDDED HARDWOOD BARK MULCH. TAKE CARE WITH INSTALLATION NOT TO DAMAGE OR COVER PLANTS. REFER TO GENERAL NOTES AND SPECIFICATIONS FOR FURTHER
- $\langle 2 \rangle$ Earthen Bed Edge (Shovel Point) Landscape Edge. Typical all plant material areas. Dress with 2"-3" OF SHREDDED HARDWOOD BARK MULCH. REFER TO GENERAL NOTES AND SPECIFICATIONS FOR FURTHER
- MULCHED 4'-0" DIA. TREE RING BED AREA W/ EARTHEN BED EDGE (SHOVEL POINT) LANDSCAPE EDGE AS REQUIRED. DRESS WITH 2"-3" OF SHREDDED HARDWOOD BARK MULCH. REFER TO LSP1.2, GENERAL NOTES AND SPECIFICATIONS FOR FURTHER INFORMATION.
- $\overline{4}$ SEEDED AREAS OF TURF GRASS. REPAIR ANY AND ALL TURF DAMAGE FROM THE CONSTRUCTION PROCESS. IT IS VERY IMPORTANT TO FOLLOW THE MANUFACTURERS INSTALLATION INSTRUCTIONS REGARDING THE TURF GRASS FOR PROPER GERMINATION AND SURVIVABILITY OF THE SEED MIX. ALSO REFER TO GENERAL NOTES FOR PREPARATION OF TOP SOIL AND SEED INSTALLATION. REFER TO GRADING PLAN FOR FURTHER INFORMATION. ALSO REFER TO GENERAL NOTES AND SPECIFICATIONS FOR FURTHER INFORMATION.

LANDSCAPE DESIGN

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<u>Sheet Title:</u>

PROPOSED PHASE II & III LANDSCAPE PLAN, AND PLANT MATERIAL TABLE

Date of Drawing:	09/20/23
Scale:	1'' = 20'-0''
Drawn By:	MCD
Job Number:	L23 - 025

Sheet Number:

Quantity	Code Name	Symbol	Description
1	Transformer		FX-LUMINARE LUXOR ZDC 300 WITH COLOR WATT TRANSFORMER W/ STAINLESS STEEL FINISH FINISH. LUXOR WI-FI MODULE P/N FXWIFIMOD. REFER TO CUT SHEETS FOR FURTHER INFORMATION AND INSTALLATION INSTRUCTIONS, LOCATIONS TO BE DETERMINED
16	XN-70 XN-ZD-H1-W-WF-RG-BZ	•	FX-LUMINARE XN-70 GRANDE IN GRADE UP LIGHT W/LUXOR TECHNOLOGY H1 WIDE FLOOD LAMP &BRONZE METALLIC FINISH. REFER TO CUT SHEETS FOR FURTHER INFORMATION AND INSTALLATION INSTRUCTIONS.
10	NL NL-ZDC-UD-BZ	•	FX-LUMINARE NL ZDC UP/DOWN LIGHT W/ LUXOR TECHNOLOGY & BRONZE METALLIC FINISH (5) PER PERGOLOA. REFER TO CUT SHEETS FOR FURTHER INFORMATION & INSTALLATION INSTRUCTIONS.
2	SRP-20-RGBW		FX-LUMINARE SRP-20-RGBW STRIP LIGHT W/ LUXOR TECHNOLOGY, 20'-0" LONG, SRP-CHN CHANNEL MOUNT AND SRP-CC COLOR CONTROLLER. TRIM 2'-6" OFF OF END OF STRIP LIGHT SO THAT CHANNEL IS SHORT 3" AT EACH END OF INSIDE FACE OF SEAT WALL. VERIFY SIZE OF CHANNEL MOUNT PRIOR TO FORMING AND POURING SEAT WALL. REFER TO CUT SHEETS FOR FURTHER INFORMATION AND INSTALLATION INSTRUCTIONS.
	Pipe Sleeve and Cable		Approximate locations for pipe sleeve and cabling

1. AT LEAST SEVENTY-TWO HOURS PRIOR TO ANY EXCAVATION, CONTRACTOR SHALL VERIFY UTILITY LOCATIONS AS GIVEN BY THE ELECTRIC, GAS, TELEPHONE, WATER, SEWER, AND CABLE TELEVISION COMPANIES, UTILITIES OR ENTITIES. REVIEW WITH OWNER'S REPRESENTATIVE SITE MECHANICAL, SITE ELECTRICAL AND LIGHTING, SITE GRADING AND DRAINAGE, SITE IRRIGATION AND ALL OTHER DRAWINGS PERTAINING TO UNDERGROUND UTILITY LOCATIONS. RECORD SET OF INFORMATION THE SAME AS IN POSSESSION OF OWNER'S REPRESENTATIVE. ALSO REVIEW OWNER'S "MARK SETS" OF ALL OF THESE DRAWINGS IN POSSESSION OF THE CONTRACTOR OR OWNER. MARK ALL SUCH UTILITIES ON THE SITE PRIOR TO COMMENCING. COORDINATE WITH OWNER BEFORE AND DURING CONSTRUCTION.

REPAIR ANY DAMAGE TO ANY SYSTEM THAT IS CAUSED BY LIGHTING INSTALLER AT NO COST TO OWNER.

2. DEVIATIONS FROM THE APPROVED THE WAUWATOSA VETERANS MEMORIAL PLAZA PROJECT PLANS SHALL BE NOTED ON THE RECORD DRAWING BY THE LIGHTING INSTALLER /CONTRACTOR AND ONLY WITH PRIOR APPROVAL OF THE LANDSCAPE ARCHITECT AND OWNER'S REPRESENTATIVE. VERBAL AGREEMENTS OR REVISIONS WITHOUT A CHANGE ORDER WILL NOT BE RECOGNIZED BY LANDSCAPE ARCHITECT AND OWNER.

GENERAL CONTRACTOR TO COORDINATE POWER SOURCE FOR OUTLETS, SECURITY CAMERAS AND KIOSKS WITH CITY STAFF AND SUBCONTRACTORS.
 LOW VOLTAGE FIXTURES TO BE INSTALLED BY F/X LUMINARE FACTORY-TRAINED & CERTIFIED

4. LOW VOLTAGE FIXTURES TO BE INSTALLED BY F/X LUMINARE FACTORY-TRAINED & CERTIFIED TECHNICIANS WHOM IS ABLE TO PROVIDE LUXOR ZD & ZDC SYSTEM PROGRAMMING AND IN-FIELD SUPPORT.

5. FIXTURES SHALL BE INDIVIDUALLY PROGRAMMABLE & DIMMABLE TO ACHIEVE MULTIPLE LUMEN OUTPUTS BASED ON LOCATION AND APPLICATION OF EACH FIXTURE; SEE "LIGHTING PROGRAM SCHEDULE"

LIGHTING CONTROLLER SHALL BE WI-FI COMPATIBLE TO ALLOW APP-BASED ON DEMAND SWITCHING & DIMMING OF INDIVIDUAL FIXTURES. AND LUXOR CLOUD TECHNOLOGIES
 RECOMMENDED LIGHTING SUPPLIER: REINDERS INC. REINDERS IS AN AUTHORIZED FX LUMINAIRE MASTER DISTRIBUTOR AND IS FACTORY-TRAINED & CERTIFIED TO PROVIDE IN-FIELD SUPPORT FOR THE INSTALLATION AND PROGRAMMING OF LUXOR ZD & ZDC SYSTEMS. CONTACT: JOEL REINDERS, JPR@REINDERS.COM, 262-372-5780.

- MINIMUM DEPTH (IN AREAS SUCH AS LAWNS AND FLOWER BEDS 10"-12" IS RECOMMENDED TO AVOID DAMAGE FROM TILLING OR AERATION AND EDGING.
- 12. METAL FENCE INSTALLER TO COORDINATE WITH LIGHTING INSTALLER REGARDING INSTALLATION LOGISTICS AND TIMING.
- 13. CONCRETE CONTRACTOR TO COORDINATE WITH LIGHTING INSTALLER REGARDING THE INSTALLATION OF PIPE SLEEVES, CABLE, ELECTRICAL BOXES AND LIGHT FIXTURES BEING PLACED IN CONCRETE FORMS. PIPE SLEEVES ARE TO BE PLACED IN GRANULAR BASE COURSE ENDS ARE TO BE TAPED SHUT AND MARKED WITH FLAGS.

14. ALL CABLE TO BE PROTECTED IN 1" SLEEVE, MINIMUM.

- 15. ALL FIXTURES THAT ARE SPECIFIED AS LED COLOR CHANGING SHALL USE RGBW TECHNOLOGY AND SHALL HAVE ADJUSTABILITY OF THE FOLLOWING ATTRIBUTE VALUES: HUE, SATURATION AND INTENSITY. COLOR PALETTES WILL BE DETERMINED UPON INSTALLATION AND/OR FINAL WALK THROUGH.
- KITCHLER 15529BLPRO CONNECTOR OR ACE BRASS SCREW-TIGHT LUG WITH SHRINK TUBE CONNECTOR 17. LOW VOLTAGE LIGHTING CABLE SHALL BE UL (1493) AND RATED FOR OUTDOOR USE (SUNLIGHT RESISTANT). LOW VOLTAGE LIGHTING CABLE GAUGE TO BE SIZED APPROPRIATELY BASED ON THE LOAD

16. ALL LOW VOLTAGE LIGHTING CABLE CONNECTIONS TO BE DONE WITH A SILICONE-FILLED LOCKING

- AND LENGTH OF THE LIGHTING RUN.

 18. LANDSCAPE LIGHTING CONTRACTOR TO COORDINATE POWER REQUIREMENTS AND LOCATION OF EXTERIOR AWATER PROOF GEOLOGIST FOR PROPOSED NEW TRANSFORMER LOCATIONS WITH
- EXTERIOR / WATER PROOF GFCI OUTLETS FOR PROPOSED NEW TRANSFORMER LOCATIONS WITH GENERAL CONTRACTOR AND LANDSCAPE ARCHITECT.

 19. REVIEW AND FOLLOW MANUFACTURERS INSTALLATION INSTRUCTIONS FOR MOUNTING AND
- INSTALLING TRANSFORMERS
 20. OWNER TO COORDINATE WITH LANDSCAPE ARCHITECT AND LIGHTING INSTALLER LIGHT SELECTION
- OF COLOR CAPABLE (ZDC) VERSUS NON COLORED (ZD) LIGHT FIXTURES.
 21. FINAL THEME COLORS AND TIMES TO BE ADJUSTED WITH OWNER AFTER INSTALLATION.

LOCATION FOR LOW VOLTAGE LIGHTING TRANSFORMER.
GENERAL CONTRACTOR TO COORDINATE LOCATION OF
EXTERIOR / WATER PROOF GFCI OUTLETS FOR PROPOSED NEW
TRANSFORMER LOCATION WITH ELECTRICAL CONTRACTOR
AND LOW VOLTAGE LIGHTING INSTALLER. REFER TO LOW
VOLTAGE LIGHTING INSTALLER'S NOTES AND SPECIFICATIONS
FOR FURTHER INFORMATION.

LOCATION OF PVC SLEEVE FOR LOW VOLTAGE LIGHTING, KIOSKS AND OUTLETS. GENERAL CONTRACTOR TO COORDINATE LOCATION WITH PAVING CONTRACTOR AND LOW VOLTAGE LIGHTING INSTALLER. REFER TO LOW VOLTAGE LIGHTING INSTALLER'S NOTES AND SPECIFICATIONS FOR FURTHER INFORMATION.

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Sheet Title:

PROPOSED PHASE I & II LOW VOLTAGE LIGHTING PLAN, AND LIGHT FIXTURE TABLE

Date of Drawing:	09/20/23
Scale:	1" = 20'-0"
Drawn By:	MCD
Job Number:	L23-025

Sheet Number:

LGT1.1

mdavis@insitedesigninc.com

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Phase I

Construction

Document

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Sheet Title:

PROPOSED LIGHT FIXTURES

Date of Drawing: 09/20/23 Scale: NONE Drawn By: MCD Job Number: L23-025

Sheet Number:



FX Luminaire

Output

Input Primary

IP Rating

Input Amperage Primary

Output Voltage Secondary

Maximum Open Circuit Volts

FX Luminaire is an industryleading manufacturer of landscape and architectural lighting products with a focus on the advancement of LED technology and digital lighting control with zoning, dimming, and color adjustmen capabilities. We offer a full spectrum of specification-driven lighting fixtures that can be utilized to create elegant, cuttingedge landscape lighting systems for commercial or residential applications. Our products are available exclusively via our extensive professional distributor network.

LUXOR Controller SPECIFICATIONS

Materials 304 stainless steel and powdercoated galvanized steel outer box Hardware

Two pan-head machined mounting screws with plastic mounting brackets attached to transformer box.

Heavy-gauge, grounded, integrally molded plug; 5' (1.5 m) length. Standard lowvoltage lighting wire required (e.g., 12-2, 10-2, etc./2.05 mm, 2.58 mm, etc.) between controlle and fixtures. No additional communication wire is required.

Learn more. Visit fxl.com | +1-760-744-5240

Input: 120 VAC, 60 Hz Input: 220-240 V, 50-60 Hz (230 V/CE version) Ambient Operating Temperature 0°F to 140°F (-18°C to 60°C) Create up to 250 independently

220-240 V, 50-60 Hz

15 VAC

Wi-Fi Connectivity adjustable lighting zones. Control each zone independentl router with the Luxor Wi-Fi with separate on/off times, various intensities (0-100% in LAN Module. Optional "Direct Connect* mode allows devices Luxor Linking to connect directly to a single Luxor Linking offers an easy way

260 W (CE version)

15 VAC

ISELV

220-240 V, 50-60 Hz

or a network router. with a single point of control. Communication Preinstalled 8" (203 mm) RJ-11 communication cable between a total of 10 units. The maximum facepack (i.e., user interface) and hardwired (Cat 5/5e/6) chassis (i.e., power unit). connection between the primary Wireless App Control and farthest satellite controller is 3.000' (0.9 km). With wireless Network module required. Luxor Linking, add 10+ satellite The Luxor App is available for units connected to the primary iOS and Android devices. Control via app available for on-site or

controller by LoRa radio up to 3,000' (0.9 km). Compatible Devices Only fixtures or devices with Luxor Technology are compatible with the Luxor Controller. Devices have varying levels of control, including: 1) zoning, or 2) zoning/ dimming, or 3) zoning/dim color. Mix and match fixtur

300 W: 23.1 lb (10.5 kg) 300 W (CE): 19.1 lb (8.7 kg) Installation Requirements devices with varying levels of Designed for installation on a control technology on a vertical surface in the upright position only. Transformer must be in a free airspace; do not instal

International Compliance Compliant per IEC 61347-1 and

IEC-61347-2-11

300 W

2.68 A

14 VAC

15 VAC

IP43

manually via assignment ports

on facepack or wirelessly via

controller without using Wi-Fi

Standard stainless steel finish and matte gray powder coat.

120 V, 60 Hz

Sustainability he Light Assignment Module Innovation meets conservation in the design and manufacturing of our products. Where we can, we use recycled materials while maintaining superior provide high-quality light at ISO 9001:2015 certified facility

10-year limited warranty

₹ (€&.@.

Learn more. Visit fxl.com | +1-760-744-5240

LUXOR Controller ordering information

WIRELESS CONTROLLER ACCESSORIES: Specify Separately

Compliance

230 V Internationa

eu 230 V, CE Certified

Code

LAM

WIFI-MOD2

WIFI-MOD2-RMT

Wattage

Luxor Satellite Controlle

Item

■ WI-FI MODULE

EXAMPLE CONTROLLER CONFIGURATION: LUX-300-SS - 300 - -

■ WI-FI MODULE REMOTE MOUNT 10' (3 m)

■ WIRELESS LINKING MODULE, NORTH AMERICA LINK-MOD

■ WIRELESS LINKING MODULE, INTERNATIONAL LINK-MOD-E

■ LIGHT ASSIGNMENT MODULE

Finish

■ M Matte Gray

WIRELESS Luxor Linking HARDWIRED Luxor Linking LUXOR LoRa long-range radio — Direct-burial Cat 5/5e/6 cables

Wireless Luxor Linking

LoRa radio (wireless)

Up to 3,000' or 914 m

Mount at controller or remote

Yes (unique IDs)

Hardwired Luxor Linking

Network cable (Cat 5/5e/6)

3,000' or 914 m (installed wire)

Up to 10

Direct-burial Cat 5/5e/6 cable and conduit

Yes (variable)

LUXOR Controller LINKING COMPARISON

FEATURES

Distance

Installation

Communication

Number of Linked Controllers

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FXLIT-015 B 5/22

FX LUMINAIRE LUXOR CONTROLLER

LANDSCAPE & ARCHITECTURAL LIGHTING

The Luxor Controller offers zoning, dimming, and

Quick Facts

in any wiring configuration

Adjust intensity from 0-100%

30,000 color options per zone

 Optional cloud-based iOS® or Android™ app control

RGBW color-changing capabilities, plus optional Wi-Fi

250 independent lighting zones
 Luxor Linking compatible for

Event-based scheduling options
 304 stainless steel and powder-



a single point of control in

Built-in astronomical timing

coated galvanized construction

larger installations

ETL and CE certified

produces soft light distribution, and protects against harsh environments

 Silicone-encased LEDs deliver a soft, diffused light distribution for top performance in a range of applications

 A high IP65 rating ensures dust-proof and water-resistant performance




SRP WHITE Strip Light

Highly versatile SRP Strip Lights make it easier than ever to illuminate stair ledges, outdoor patios, hardscape elements, and more.

Features

• 12 VAC power ensures compatibility with any low-voltage lighting transformer Two color temperature options offer a warm

- (2,700K) or soft (3,000K) look • 10' (3.1 m) and 40' (12.2 m) lengths
- Preinstalled 10' (3.1 m) power feed Compatible with Luxor® Low-Voltage CUBE
- SRP WHITE STRIPLIGHT MODELS (LCM-LV) for zoning and dimming capabilities

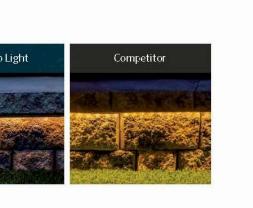

CE Version

8" (203 mm)

Standard

Version

8" (203 mm)

 Total Lumens: 28.7 lm/ft (94.6 lm/m) Input Voltage: 10 to 15 V Input Power: 0.6 W/ft (2.1 W/m)

VA: 0.7 W/ft (2.2 W/m)

Model	Description	
SRP-10-W	2,700K, 10' (3.1 m)	
SRP-10-S	3,000K, 101 (3.1 m)	
SRP-40-W	2,700K, 40¹ (12.2 m)	
SRP-40-S	3,000K, 40' (12.2 m)	

SRP RGBW Strip Light Endless opportunities to color your world! When installed with the SRP-CC Color Controller, the SRP RGBW Strip Light is compatible with the next-generation Luxor Controller from FX Luminaire or any traditional low-voltage transformer for unmatched color-changing effects. Total Lumens: 24.3 lm/ft (80.0 lm/m) Same award-winning design as SRP White (install, construction, etc.) · Input Voltage: 10 to 15 V 12 VAC power ensures compatibility with any Input Power; 1.7 W/ft (5.6 W/m) low-voltage lighting transformer VA: 2.9 W/ft (9.6 W/m) * Total RBGW control; SRP-CC Strip Light Color Controller required SRP RGBW STRIP LIGHT MODELS · Two convenient control options: Standalone or Luxor Mode Description Luxor Mode allows a Luxor Controller to SRP-RGBW SRP RGBW Strip Light, 10' (3.1 m) assign a Group and set Hue, Saturation, and Intensity values Strip Light Color Controller Standalone Mode can be used with our EX, PX, and DX models as well as any standard low-voltage transformer, allowing you to manually set Hue, Saturation, and Intensity values Luxor Mode Standalone Mode








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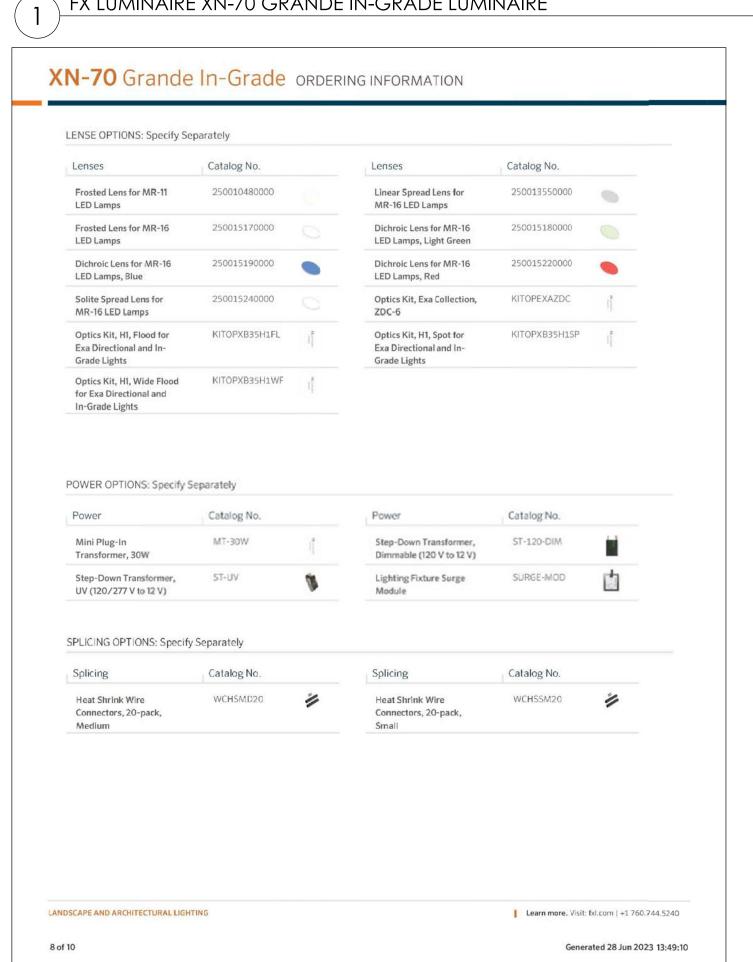


Y FX LUMINAIRE SRP RGBW STRIP LIGHT

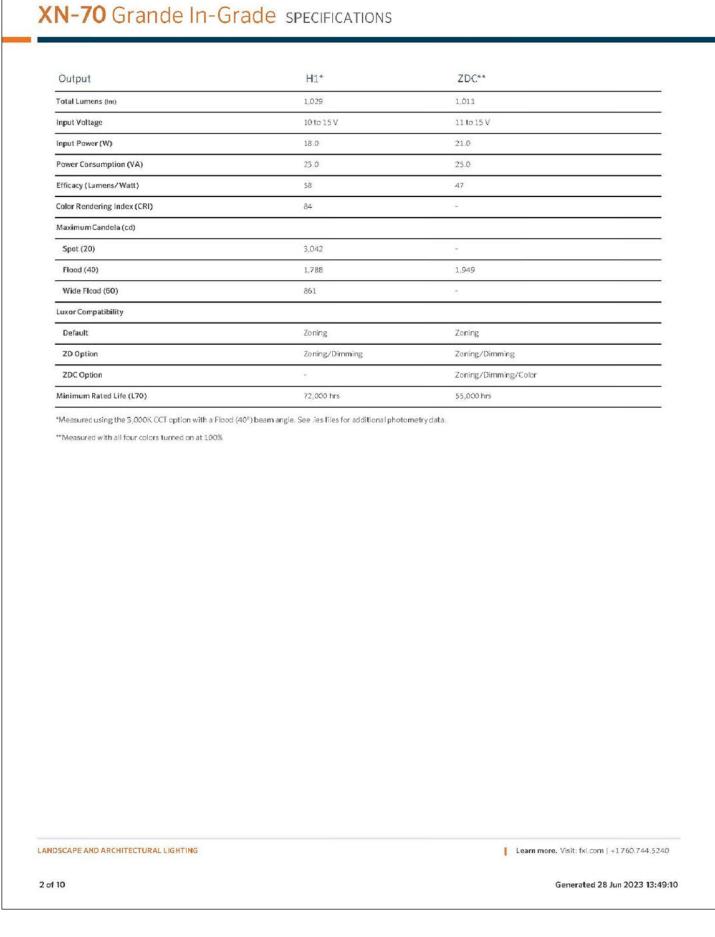

FX Luminaire FX Luminaire is an industry- leading manufacturer of landscape and architectural lighting products with a focus on the advancement of LED technology and digital lighting control with zoning, dimming, and color adjustment capabilities. We offer a full spectrum of specification- driven lighting fixtures that can be util zed to create elegant, cutting-edge landscape lighting systems for commercial or residential applications. Our products are available exclusively via our extensive professional distributor network. Materials 316 marine-grade stainless steel, die-cast aluminum, and stainless steel hardware. LED Integrated module with Cree LEDs. Gold-plated connectors and potted driver for maximum reliability and corrosion resistance. Proprietary onboard intelligent driver uses firmware-controlled temperature regulation, maximizing LED life. Optics Color temperature and beam angle defined by part number. Both components are serviceable with parts ordered separately.	Dimming Primary; Consult transformer specifications Secondary; Luxor® control or a trailing-edge (reverse phase-cut) dimmer. Configuration Integral driver. Finish Polished stainless steel finish and polyester TGIC powder-coat layer. Tested to ASTM standards. Hardware Teflon-coated faceplate screws. Wiring Bottom entry 16 AWG (1.3 mm); SOW Cable, 105 C, 600 V, 31 (1 m) length.	Sockets Nonreplaceable Molex connector with Moisture Block® Technology to prevent moisture from wicking up into sealed areas of the luminaire. Power Input 10-15 Vac/dc, 50/60 Hz. for white, and 11-15 Vac, 50/60 Hz. for RGBW (ZDC). Remote transformer required (specify separately). Housing Die-cast aluminum. Weight 5.5 lb / 2.5 kg Lens High optical purity glass with load strength suitable for walk-over and drive-over applications. Static load rating: 4,400 lb (2,300 kg).	Ambient Operating Temperature 0°F to 140°F (-18°C to 60°C) Sustainability Innovation meets conservation in the design and manufacturing of our products. Where we can, we use recycled materials while maintaining superior functionality. Our LED products provide high quality light at optimal energy efficiency, lifespan, and durability. Installation Requirements Designed for recessed installation in the upward direction only. Control ZD or ZDC utilizes Luxor Technology to zone fixtures in up to 250 groups, dim each group in 1% increments between 0 and 100%, or change to one of 30,000 colors with RGBW LEDs. Select the ZD option for zoning/dimming/color. Standard fixture zoneable with Luxor Controller.	Warranty 10-year mi Listings Listings Listings Listings	e. Visit: fxl.com +1	
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Fixture 1	Luxor Option La	amp	Color Temp	1	Beam Angle	Style	Finish	
	[default] H Zone 18	1 8.0 W / 23.0 VA	W Warm (2700 K)		SP Spot (20°)	RG Ring	BZ Bronze Metallic	
		default ZDC option]	S Soft (3000K)		FL Flood (40°)		FB Black	3
	ZDC 23	1.0 W / 25.0 VA	[default ZDC	option]	WF		DG Desert Granite	
	Zone/Dim/Color		RGBW		Wide Flood (60°)		WI Weathered Iron	
							SB Sedona Brown	
							FW Flat White	
							SV Silver	
							SS Stainless Steel	
EXAMPLE FIXT	URE CONFIGURATION: XV-7	<u>~</u> -×x-xxxx-xx						
	Flood - Illuminance a		140 444	MOUNTIN	NG OPTIONS: Spec	ify Separa	itely	
Distanc	e Center Beam fo	c Bear	m Width	MOUNTIN	IG OPTIONS: Spec	cify Separa		
Distance Feet (Met	e Center Beam for ers) Foot-Candles (Lu	C Bear	Horizontal: 38°	Mounts			og No.	N.
Distanc	e Center Beam for Foot-Candles (Lum) 15.5 fc (167 lx)	Dear Bear Vertical: 38 °		Mounts	IG OPTIONS: Spec g Kit for KT or rade Lights	Catalo	og No.	Risebale sees
Distance Feet (Met 10.0' (3.0)	e Center Beam for Foot-Candles (Lu m) 15.5 fc (167 x) m) 3.9 fc (42 x)	C Bear Vertical: 38 ° 6.7' (2 m)	Horizontal: 38 ° 6.9' (2.1 m)	Mounts	g Kit for KT or	Catalo	og No.	Russia
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Distance Feet (Met 10.0' (3.0) 20.0' (6.1) 30.0' (9.1)	e Center Beam for Foot-Candles (Lu m) 15.5 fc (167 x) m) 3.9 fc (42 x) m) 1.7 fc (19 x) m) 1 fc (10 x)	Sear Sear Sear Sear Sear Sear Sear Sear	Horizontal: 38 ° 6.9' (2.1 m) 13.7' (4.2 m) 20.6' (6.3 m) 27.4' (8.4 m)	Mounts Mounting Exa In-Gr	g Kit for KT or rade Lights	Catalo	og No.	Number of the state of the stat
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FX LUMINAIRE SRP RGBW STRIP LIGHT

Date of Drawing: 09/20/23 Scale: NONE Drawn By: MCD Job Number: L23-025 Sheet Number:

LANDSCAPE DESIGN Landscape Consulting & Master Planning Design Sevices 11525 W. North Avenue, Suite 1B Wauwatosa, WI 53226 Tel (414) 476-1204 www.insitedesigninc.com mdavis@insitedesigninc.com Project for: WAUWATOSA **VETERANS COMMITTEE** Wauwatosa, WI <u>Project:</u> WAUWATOSA VETERANS MEMORIAL at HART PARK 72nd Street - Hart Park Wauwatosa, WI 53226 Issuance and Revisions:

> 06/05/23 Client Review Submittal 06/29/23 Parks Dept Prelim Meeting 07/17/23 Parks Dept Meeting 08/28/23 Client Review Submittal 09/20/23 Phase I Construction

Number Description

Document

Submittal

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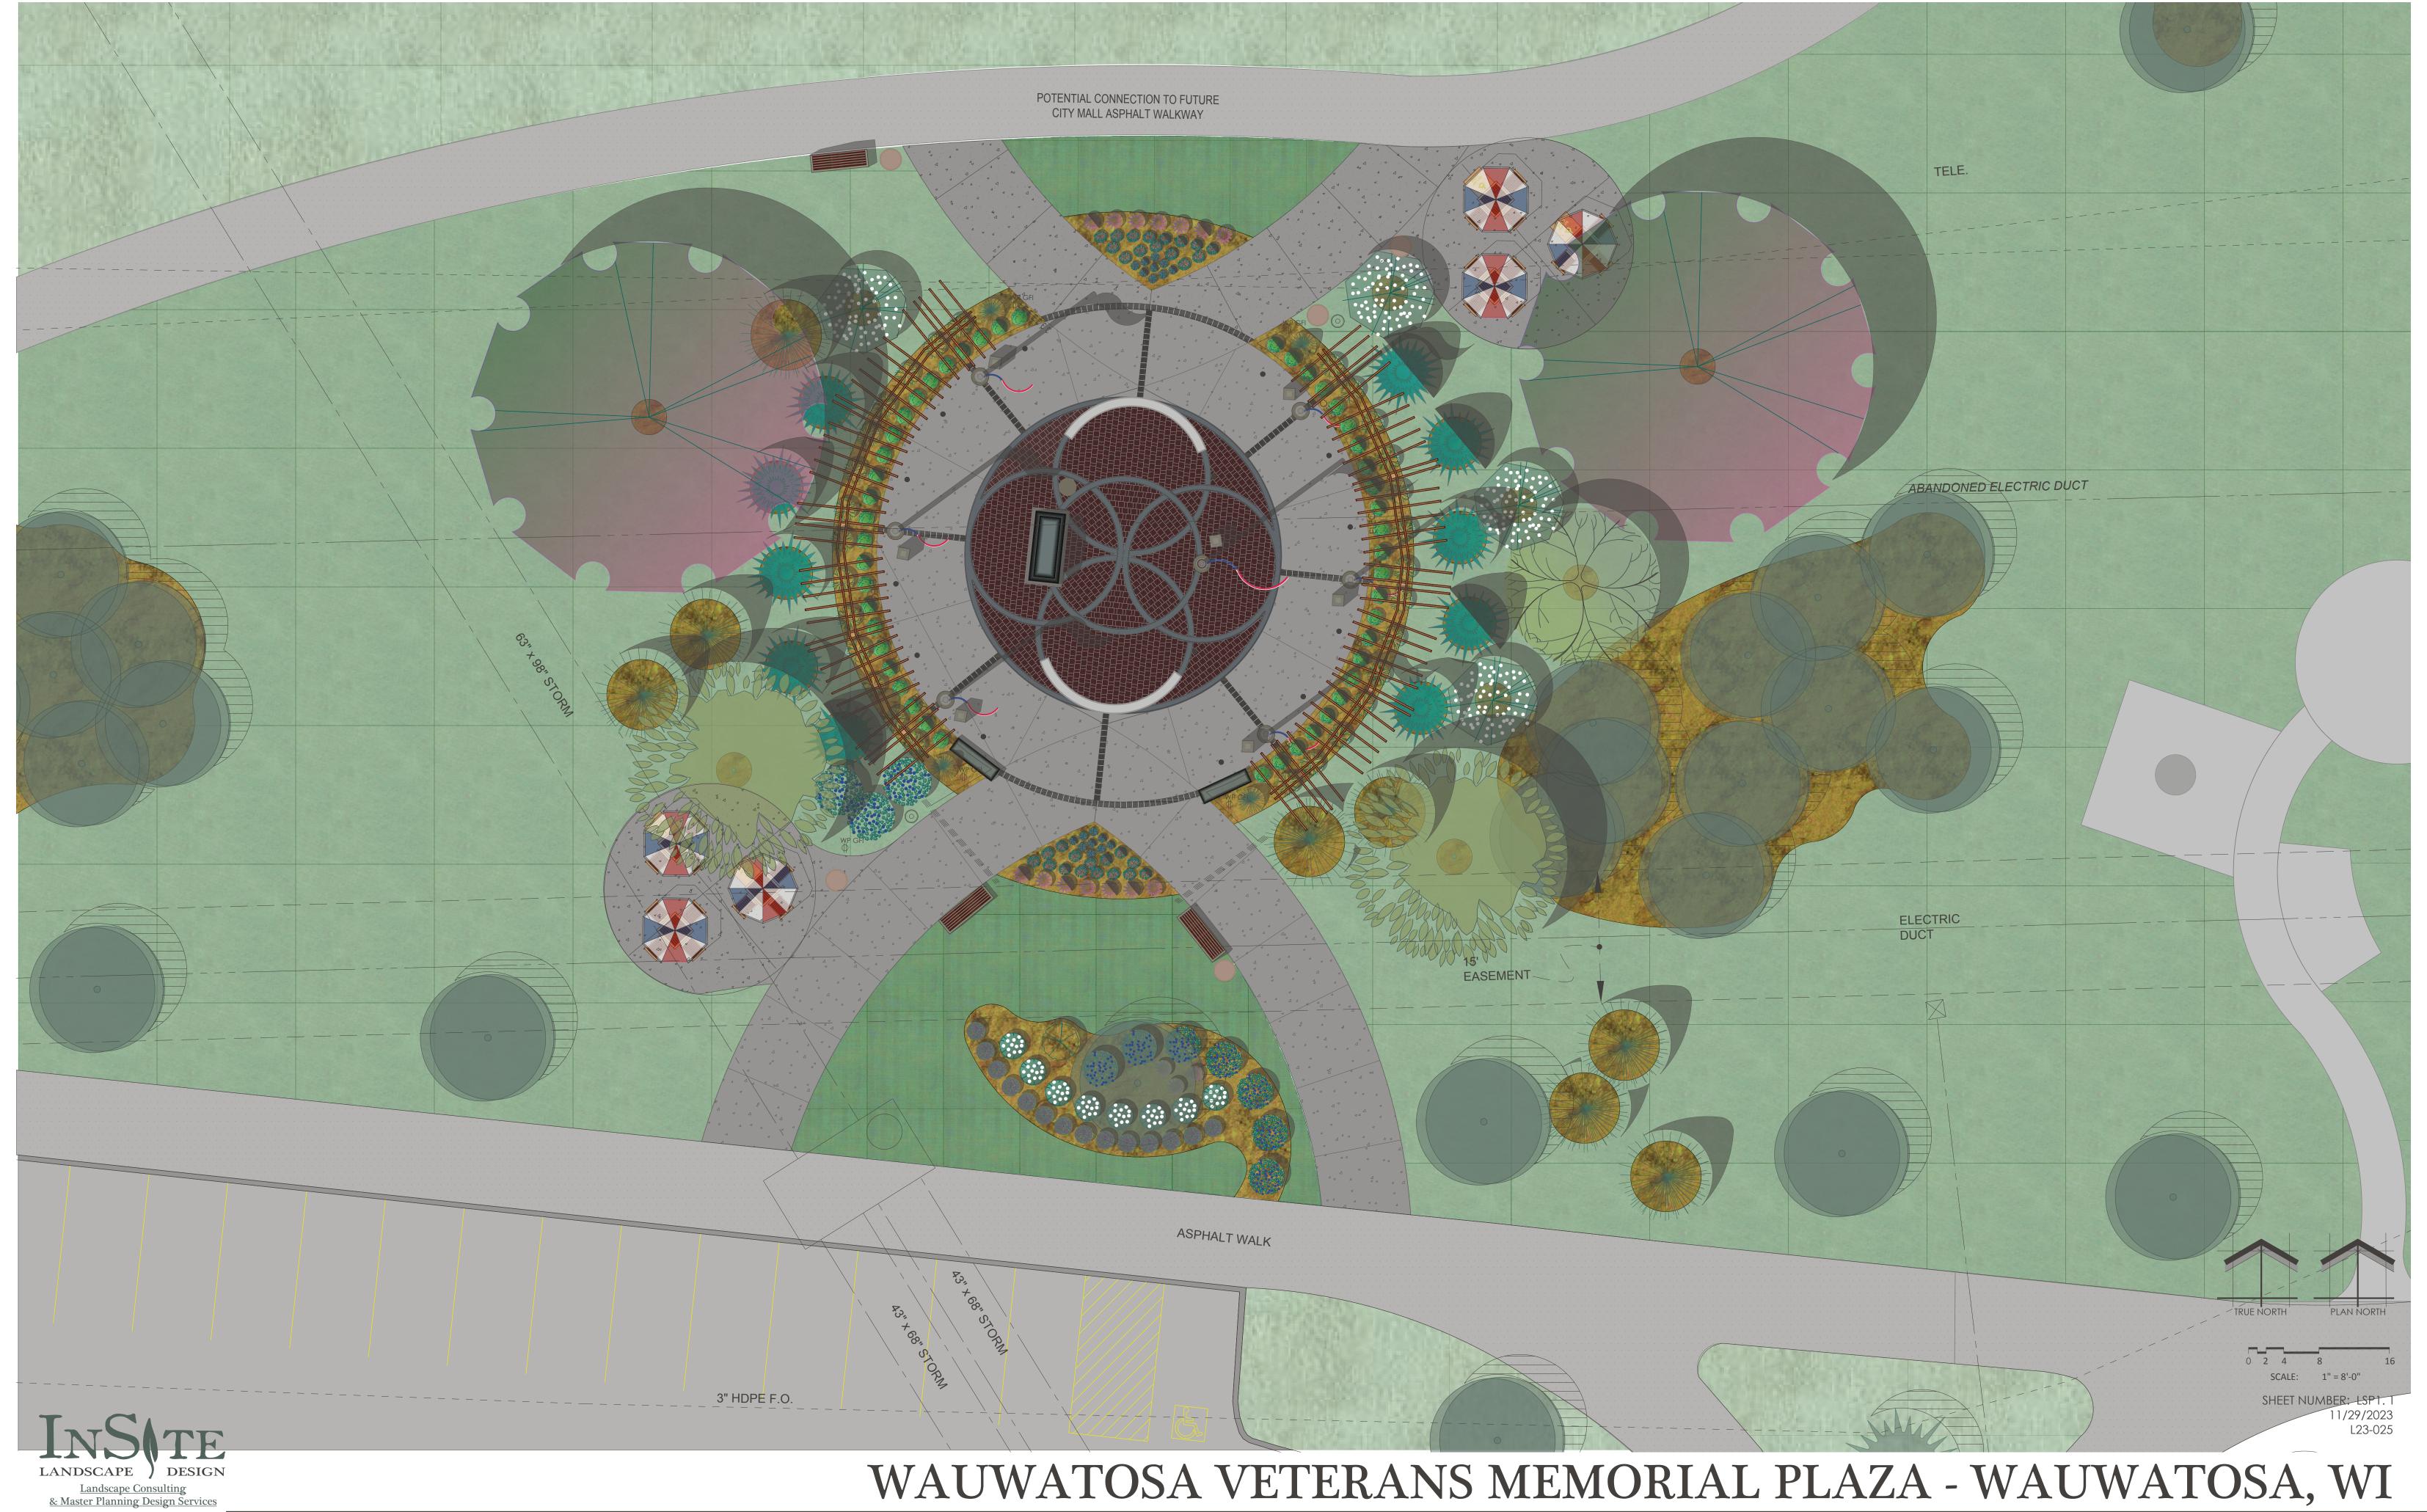
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<u>Sheet Title</u>:

PROPOSED LIGHT FIXTURES



WAUWATOSA VETERANS MEMORIAL PLAZA - WAUWATOSA, WI Proposed Plaza Exhibit

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